# A NEW CUSTOM RESIDENCE FOR

# JAMES & DARLEEN LeBARON

501 Yawl Lane | Longboat Key, Florida | 34228 LOT 10 | Country Club Shores | Town of LBK





DN: c=US, o=Florida, dnQualifier=A01410D0 000017EDASAC3A7000 C2DA1, cn=Jody D Young Jr. Date: 2022.04.07 17:13:59-04'00' Adobe Acrobat version: 2022.001.20085

NPDES

GENERAL NOTES	EROSION & SEDIMENT CONTROL NOTES		TYPICAL ABBREVIATION	15	1	DRAWING SHEET INDEX
1. BLANKINGS DO NOT SCALE THESE DRAWINGS. WRITTEN DIMERSINS AND NOTES SHALL CONTROL.  CONTACT HE SUPPRETINEDRY WITH ANY CONNETTION THE PRANS BEFORE EEGINBING WORK, UNLESS OTHERWISE SPECIFIED, ALL DIMENSIONS ARE TO STRUCTURAL TERMS AND DO NOT INCLUDE FINISHES. DIMENSIONS, SEES. MEASUREMENTS AND LOCATION INSTRUCTIONS ARE NORMAN, AND APPROXIMATE AND MAY VARY FROM WHAT IS SPECIFIED OR REQUIRED.  ONSITE VERFICATIONS: FALCH SUB-CONTRACTION SHALL REPORT ANY DISCREPANCY OR OTHER CHESTIONS SUB-CONTRACTIONS: EACH SUB-CONTRACTION SHALL REPORT ANY DISCREPANCY OR OTHER CHESTIONS ACCEPTING FULL RESPONSIBILITY FOR ANY PERFORM. ONESSONS A DISCREPANCY OR OTHER CHESTIONS APPLICABLE CODES ITS THE INTENT THAT THESE DRAWINGS BE IN CONFORMANCE WITH THE 200 PFG., 2017 NEC AND ALL PREFLOADS HOUT COUNTY, STATE AND FEDERAL CODES, ORDINANCES, LAND REGULATIONS AND RESTRICTIVE COVENANTS GOVERNING THE STRE.  SCOPE OF MORE ALL TRACES SHALL FURNISH ALL BOOKS CEUDINARY, AND MATERIALS, AND SHALL SCOPE OF MORE ALL TRACES SHALL FURNISH ALL BOOKS CEUDINARY. AND MATERIALS, AND SHALL SCOPE OF MORE ALL TRACES SHALL FURNISH ALL BOOKS CEUDINARY OR REGULATED ANY CODE WITHIN THE REPLYANT JURISDICTIONS OF GOVERNING THE SITE TO. COMPLETE THER SCOPE OF WORK.  CEILING HEIGHTS: MAY BE ADJUSTED AS REQUIRED FOR STRUCTURAL ENGINEERING OF MICHAEL MAY COLUMN. CAN BE ALL MATERIALS SHALL FERNISH ALL PER AND MATERIAL SHALL FOR ANY ADDITIONAL CARBONISH OF MATERIALS.  CEILING HEIGHTS: MAY BE ADJUSTED AS REQUIRED FOR STRUCTURAL ENGINEERING OR MICHAELOUS OR MICHAELOUS CONTRACTOR OF MICHAELOUS CONTRACTOR OF MICHAELOUS CONTRACTOR.  CHARGE DEAL MATERIALS SHALL ENSIVED FOR PERSAMALL LAVOUR ONLY, AS SUCH ALL DUMENSIONS DRAWNESS AS SUPPORTED BY CONTRACT FOR THE THE DEBLANC AND STALLED PER APPROVED CARRIET FOR THE DEBLANC AND STALLED PER APPROVED CARRIET.	1. WHEN PANIFALL AND DULOFF COCURS, DALY NEPRCIDENC OF THE REQUION AND DESIMENT CONTROLS AND DISCHARGE OUTFLASS MICH SERVICED BY SOMEONE REVOKED RECORDED AND THE PROPRIES PRACTICES INSTALLATION. AND MAINTENANCE OF REOSEN AND SEDMENT CONTROLS WHO WORKS FOR THE PREMITTE.  2. DURING WE WE WHATHER PRISON CHAPPORARY STABLEDING OF THE SIZE WAS COCURED THE DO FEACH WORK DAY.  3. SEDMENT CONTROLS MUST BE INSTALLED AND MAINTAINED ON ALL DOWN GRADIENT SIZES OF THE CONSTRUCTION SIZE AT ALL TIMES DURING CONSTRUCTION SIZE AT ALL TIMES DURING CONSTRUCTION SIZE AT ALL TIMES DURING CONSTRUCTION THEY MUST SERVINE IN PLACE UNIT SERVAMENT VEGETAINOR OF OTHER PREMAMENT OF THE MAINTENANCE AT ALL TIMES DURING CONSTRUCTION. THEY MUST SERVINE HAVE AND MAINTAINED AT ALL TIMES DURING CONSTRUCTION SIZE AND THE SIZE OF THE STABLE SERVINE AND THE SAME SERVINE TO AND THE SAME SERVINE AND	ADDITIONAL ABBREVIATION AV ABOVE AFF ABOVE RESHED ROOR AFF ABOVE RESHED ROOR ALIMANIAN AFF ABOVE RESHED ROOR ALIMANIAN AFF ABOVE RESHED ROOR ALIMANIAN ALIMA	NS GENERAL ABBREVIATIONS WHICH MAY BE USED T  SA AND SYMBOLIS CAN BE FOLING WITHIN THE REELY  CHOMP FEMBERS 18 BOOK BE TO BE	ANT SHEETS LEGEND AND/OR NOTES.  REF REFINGERATOR SOD SUBNIC GLASS DOOR SF SQUARE PIET (POOT) SQUARE PIET (POOT) SQUARE PIET (POOT) SHOWER SHOWER SHOWER SPECIS SHOWER SPECIS SHOWER SPECIS STRUCTURAL TAGO TOROUGH AND GROOVE	A0.0 A1.0 A2.1 A2.1d A2.2 A2.2d A3.0 A4.0 A4.1 A6.1 A6.2 A7.0 D1.0	COVER SHEET  SIE AND DRAINAGE PLAN  MAIN LEVEL FLOOR PLAN  MAIN LEVEL DIMENSION PLAN  UPPER LEVEL FLOOR PLAN  ROOF PLAN  EVERSION ELEVATIONS (FRONT & REAR)  EXTERIOR ELEVATIONS (FRONT & REAR)  EXTERIOR ELEVATIONS (SIDES)  MAIN LEVEL ELECTRICAL PLAN  UPPER LEVEL ELECTRICAL PLAN  SCHEDULES & NOTES  INTERIOR DEFAILS  EXTERIOR DEFAILS  EXTERIOR DEFAILS
DESIGN DISCLOSURE	THE APPLICATION RATE OF FERTILIZERS USED TO REESTABLISH VEGETATION MUST FOLLOW MANUFACTURERS RECOMMENDATIONS, NUTRIEN RELEASE FROM FERTILIZERS TO SURFACE WATERS MUST BE MINIMIZED. TIME RELEASE FROM JET BE WITH ANY WATER WAY RIPARIAN  THE APPLICATIONS, NUTRIEN RELEASES FROM FERTILIZERS TO SURFACE WATERS MUST BE MINIMIZED. TIME RELEASE  FERTILIZERS SHOULD BE USED AND CARE SHOULD BE MADE IN APPLICATION OF FERTILIZERS WITHIN ANY WATER WAY RIPARIAN  THE APPLICATION MADE TO THE PROPERTY OF	V ee e	DESIGN CRITERIA		\$1.0 \$1.1	FOUNDATION PLAN FOUNDATION DETAILS
THE PURPOSE OF THIS DISCLOSURE IS TO ACKNOWLEDGE THAT JOHN CANNON HOMES, INC. DESIGNS BUILDING PLANS FOR ITS CUSTOMERS FOR THE PURPOSE OF CONSTRUCTION THER HOME. AND MAKES NO CLAIMS AS TO REPRESENTING TESTS AS AN ARCHITECT OR SPEPR IN THE PURCHONAL UTILITY OF HOUSE SOSY. IN AS SUCH, NO REPRESENTATIONS ARE MADE AS TO THE ASSTRUCTION ALTHOUGH THE PLANS FOR SPECIAL DISCLOSURES. IN AS SUCH, NO REPRESENTATIONS ARE MADE AS TO THE ASSTRUCTION ALTHOUGH THE PLAN ES READED FOR A PURP AND DEVICE. YOU COMEACT AND THESE FARSA ARE CUSTOM. ALTHOUGH THE PLAN ES READED FOR A PURP THE ACCURATION. THE PLAN AS TO SESSION CHANGES, ADDITIONS, DELETIONS, SUBSTITUTIONS, DEVIATIONS AND / OR ALTERATIONS FROM WHAT IS SHOWN ON OUR MODGLE OF YOUR FLANS SIDE AT CONTRACT. JOHN CANNON HOMES, INC. PLUT REPRESENTS THE DESIGN OF THE HOUSES STRUCTURAL INTEGRITY TO BE IN ACCORDANCE WITH A PURP LABBE BUILDING CODES AND GOVERNMENTS ARE COURSEMENTS. THESE COMPRIGHTED PLANS ASSET THE PROPERTY OF JOHN CANNON HOMES, INC. IN SO MUCH ANY UNAUTHORIZED USE DUPLICATION. THE HOUSES DESIGN AND / OR LAYOUT (I.E. ROOM LAYOUT, SEE AND / OR CONFIGURATION. DOOR AND HOME DEVIATIONS. ECC.) TO CONTRACT AN ARCHITECTOR SIMILAR PEPER THIS HEE DEVIAL COSTS INCLURRED SURGESTED THAT AND ISLIGATIONS HAVING CHISCISTORS OF SIMILAR PEPER IN THE FIRST OF HOUSE BESTON AND LAYOUT TO ASSIST THEM IN RESOUNCE HAVE QUESTIONS OR CONCERNS RESORDING THE FILLOFICATION. SURGESTED THAT AND SISTEMATION TO BE SERVING THE OFF OF THE PURP AND A SISTEMATION. DOOR AND WINDOW LOCATIONS, ECC.) TO CONTRACT AN ARCHITECTOR OF SIMILAR PEPER IN THE FIRST OF HOUSE BESTON AND LAYOUT TO ASSIST THEM IN RESOUNCE HOMES OF THE BUILDING FLANS OF THE PURP AND ARCHITECTURE. AND ADDITIONAL COSTS O'CURRENORS THE PLAY ARCHITECTURE. THE PURP AND ARCHITECTURE OF THE PURP AND ARCHITECTURE. AND ADDITIONAL COSTS O'CURRENORS THE PURP AND ARCHITECTURE. THE PURP AND ARCHITEC	20. OWNER OR DESIGNATED PERSON SHALL BE RESPONSIBLE FOR PROPER INSTALLATION AND MAINTENANCE OF ALL BROSION AND SEDMENT CONTROL MEASURES IN ACCORDANCE WITH CURRENT CLEAN WATER SERVICES STANDARDS, STATE AND FEDERAL RESCULATIONS.  13. PRORT TO ANY LAND DETURBING ACTIVITIES. THE BOUNDARDS OF THE CLEARING LIMITS, VEGETATED BUFFERS, AND ANY SENSITIVE AND STANDARDS OF THE CLEARING LIMITS. VEGETATED BUFFERS, AND ANY SENSITIVE AND STANDARDS OF THE CLEARING LIMITS. VEGETATED BUFFERS, AND ANY SENSITIVE AREAS SHOWN ON THIS FLAN SHALL BE CLEARLY DELINEATED IN THE FELD. DIMESS OTHERWISE APPROVED FOR THE DURALTION OF THE PROJECT. IN THE PERSON OF THE PROJECT. IN THE PERSON OF THE PROJECT. IN THE PROJECT. IN THE SEM SWM SIMLS BE ANAILARDED FOR THE DURALTION OF THE PROJECT. IN THE PROJECTION. THESE BWYS MUST BE ANAILARDED FOR THE DURALTION OF THE PROJECT. IN THE PROJECT. IN THESE BWYS MUST BE ANAILARDED FOR THE DURALTION OF THE PROJECT. IN THE PROJECT. IN THE SEM SEM SIMLS BE ANAILARDED FOR THE PURPLAND OF SECURAL OSES OF THE DIRECT HEAVY AND SECURED THE PROJECT. IN THE	BUILDING AREAS GOUND LEVEL UPPER LEVEL TOTAL LUNION GARAGE ENTRY LAMAI UPPER LAMAI TOTAL LUNGER ROOF UPPER POOL AREA	2017 National Best PROJECT SPECING 3075 SO FT PARCEL ID: 00101 920 SO FT JURSDICTION: SAS 488 SO FT 489 SO FT 50 F	:INFORMATION 60007 RASOTA COUNTY E: AE ATION: 10'-0" NAVD EVATION: 11'-0" NAVD	\$2.0 \$2.1 \$3.0 \$3.1 \$4.0 \$4.1 \$4.2 \$4.3 \$4.4	FEST FLOOR STRUCTURAL PLAN SECOND FLOOR STRUCTURAL PLAN FREST FLOOR FRAMING PLAN STRUCTURAL DEFAILS STRUCTUR
HELDO THE BUSINESS WELL SHEET ARE PERCEIVEN DOOR SIZES AND FLACEMENT, EGISWAND STRUCTURAL OFFICE AND STRUCTURAL	<ol> <li>IN JEES SUBJECT TO WIND EROSION, APPROPRIATE BMPS MUST BE USED WHICH MAY INCLUDE THE APPLICATION OF FINE WATER SPRAYING.</li> </ol>	LOWER POOL AREA	1288 SQ FT		REG	RAWING INDEX REPRESENTS A COMPLETE SET OF SHEETS UURED FOR PERMITTING AND CONSTRUCTION OF THIS INCE, AND MAY REFLECT DRAWINGS NOT YET ISSUED IN PROGRESS SETS.

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A NEW CUSTOM RESIDENCE FOR

JIM & DARLEEN LEBARON

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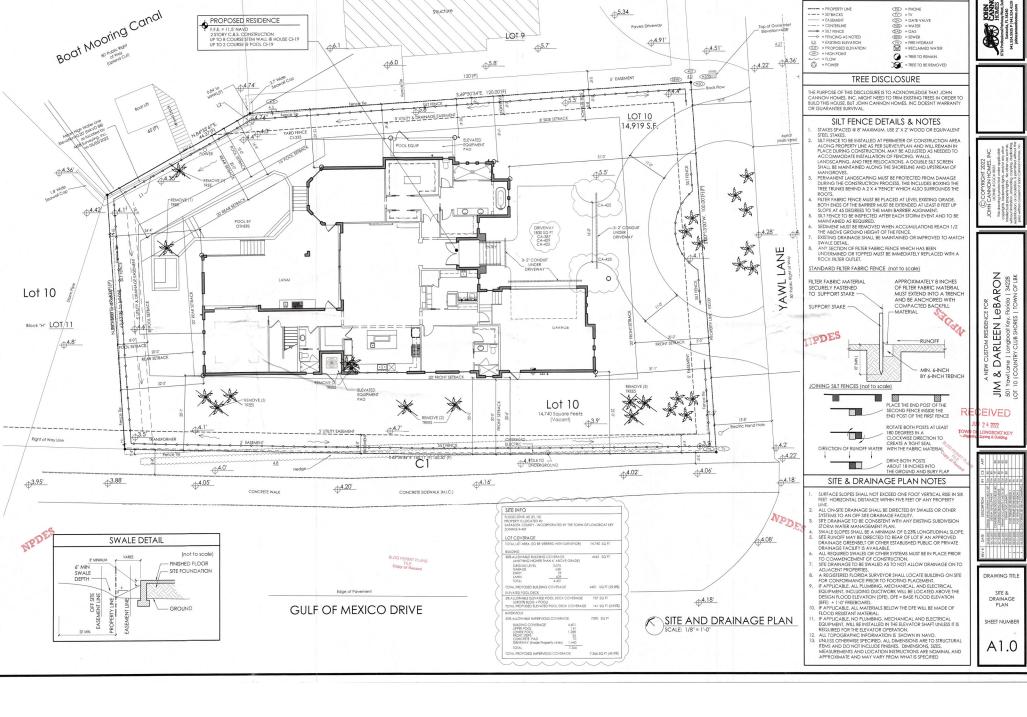
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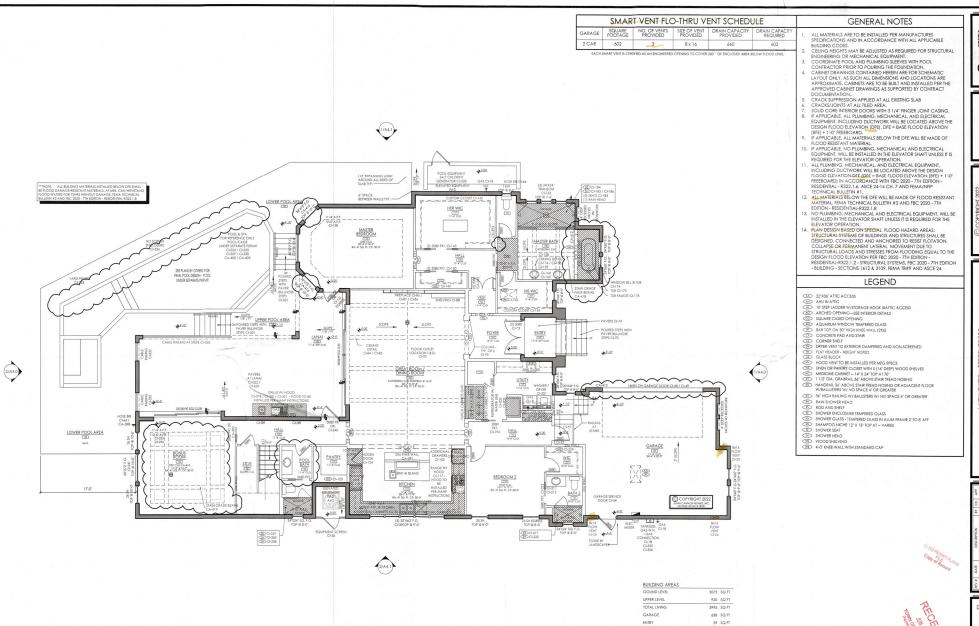
DRAWING TITLE

HEET NUMBER

A0.0



LEGEND



LANAI

UPPER LANA

TOTAL UNDER ROOF

UPPER POOL AREA

LOWER POOL AREA

629 SQ FT

298 SQ FT

5619 SQ FT

141 SQ FT

CANNON
CANNON
HOMES
TO Present Substantial
Supports, 13,44,125
John Cannonhomes.com



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DARLEEN LEBARON

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JIM &

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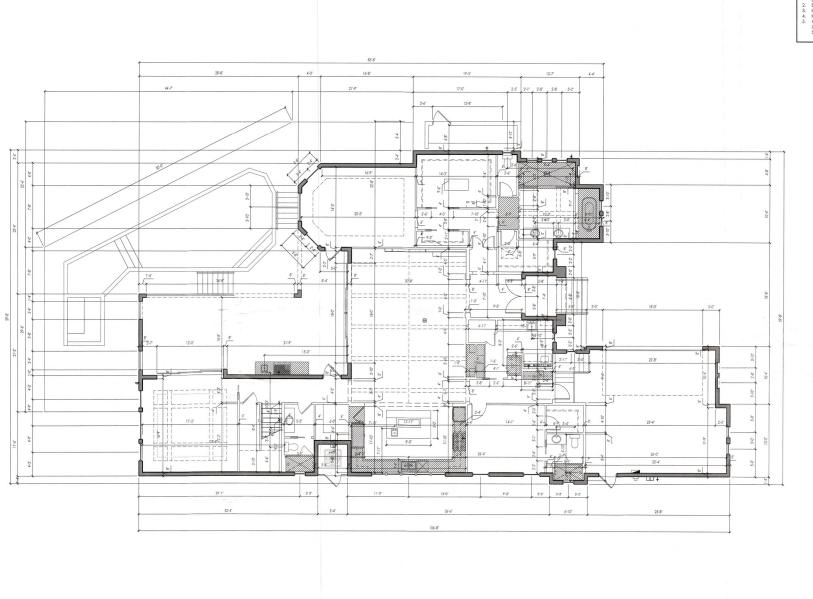
DRAWING TITLE

MAIN LEVEL FLOOR PLAN

SHEET NUMBER

A2.1

MAIN LEVEL FLOOR PLAN



# DIMENSION NOTES

- DRAWINGS ARE NOT TO BE SCALED. CONTACT BUILDER FOR ANY
  DIMERSION NOT SHOWN

  DISTRIBUTION BUILDINGS ARE TO APPROXIMATE FACE OF BLOCK

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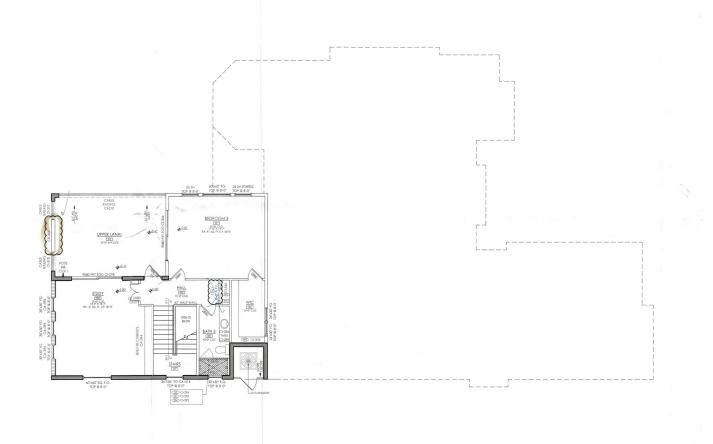
JIM & DARLEEN LEBARON
501 You'll Long booth Ray, Finded 1 34228
LOT 10 I COUNTRY CLUB SHCRES 1 TOWN OF LBK

DRAWING TITLE MAIN LEVEL DIMENSION PLAN

SHEET NUMBER

A2.1d

MAIN LEVEL DIMENSION PLAN
SCALE: 3/16" = 1'-0"



## **GENERAL NOTES**

- GENERAL NOTES

  1. ALL MATERIAS ARE TO BE INSTALLED PRE MANIFACTURES SPECIFICATIONS AND IN ACCORDANCE WITH ALL APPLICABLE BUILDING CODES.

  2. CELLING HEROM AND IN ACCORDANCE WITH ALL APPLICABLE BUILDING CODES.

  3. COORDANATE POOL AND FLUMBING SERVES WITH POOL CONTRACTOR PROFIT OF DOWNS THE FOOL AND FLUMBING ABOVE THE POOL AND FLUMBING ABOVE THE POOL AND FLUMBING AND FOR CANDISA ARE APPROXIMATE. CARBIESTS ARE TO SE BUILT AND INSTALLED PER THE APPROXIMATE. CARBIESTS ARE TO SE BUILT AND INSTALLED PER THE APPROXIMATE. CARBIESTS ARE TO SE BUILT AND INSTALLED PER THE APPROXIMATE. CARBIESTS AND SUPPORTED AT COMPACT.

  5. CRACK SUPPRESSION APPLIED AT ALL EXISTING SLAB.

  6. CRACK SUPPRESSION APPLIED AT ALL EXISTING SLAB.

  7. SOLID CORE INTERIOR DOORS WITH 31/4 FINGER JOINT CASING.

  8. FAPPLICABLE ALL PLUMBINGS, MECHANICAL AND EECTRICAL EQUIPMENT. INCLUDING DUCTYONER WILL SELECTATED AND STATE OF THE PROVIDED AND STATE OF THE P

## LEGEND

- LEGEND

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REVIEWED FOR CODE COMPLIANCE
LONGBOAT KEY BUILDING DEPT.

MAR 23 2023 APPROVED .

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MAR 22 2673

TOWN OF LONGBOAT KEY
Pastering, Zoring & Building

UPPER LEVEL FLOOR PLAN

HOMES


DARLEEN LeBARON JIM & DARLEEN LEBARON 501 Yaw Lane | Longboat Key, Figirda | 34228 LOT 10 | COUNTRY CLUB SHORES | TOWN OF LBK

DRAWING TITLE

UPPER LEVEL FLOOR PLAN

SHEET NUMBER A2.2

BLDG PE

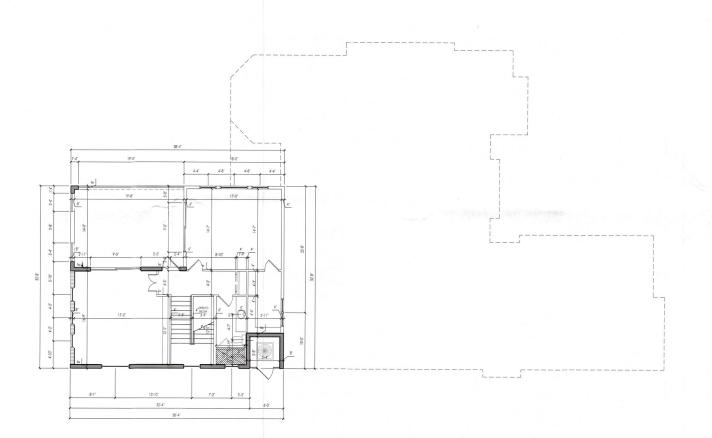

# DIMENSION NOTES

- DRAWINGS ARE NOT TO BE SCALED. CONTACT BUILDER FOR ANY DIMENSION NOT SHOWN.

  DIMENSION NOT SHOWN.

  EXTERIOR DIMENSIONS ARE TO APPROXIMATE FACE OF BLOCK.

  INTERIOR DIMENSIONS ARE TO APPROXIMATE FACE OF WALL.

  INTERIOR DOOR OFFERST TO BE FOR WILL MILESS OTHERWE NOTED.

  WINDOW OPENINGS ARE DIMENSIONED TO THE CENTER OF THE OPENING. WINDOW SIZES PROVIDED BE ARE APPROXIMATE AND SHOULD BE VERRIED WITH WINDOW MANUFACTURERS.



A NEW CUSTOM RESIDENCE FOR

JIM & DARLEEN LEBARON
SOI YOMLONE | LONGBOOT KRY, FIORD | 34228
LOT 10 | COUNTRY CLUB SHORES | TOWN OF LBK

DRAWING TITLE

UPPER LEVEL DIMENSION PLAN

SHEET NUMBER


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TOWN OF LONGBOAT KEY

Penting, Zoning & Budding UPPER LEVEL DIMENSION PLAN
SCALE: 3/16" = 1'-0"



# ROOF VENTS

GARAGE: 654 SF ROOF VENT: 313 SI EVE VENT: 313 SI VENTS REQUIRED: 3 ENTRY: 59 SF ROOF VENT: 28 SI EVE VENT: 28 SI VENTS REQUIRED: 1

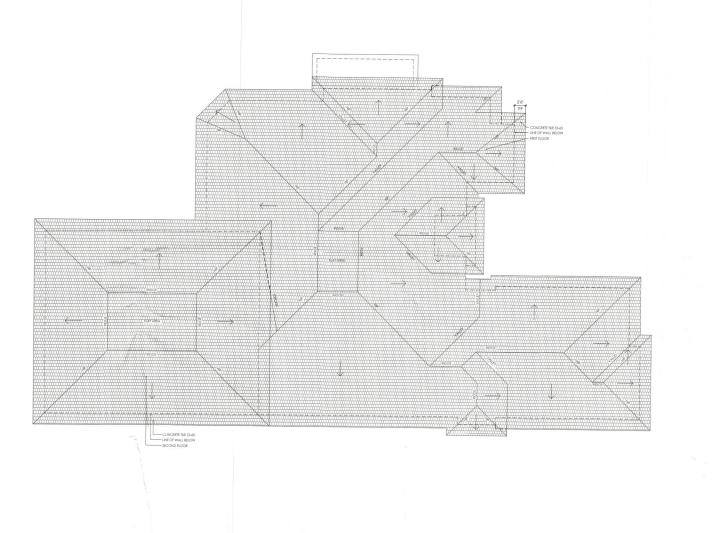UPPER LANAI: 298 SF ROOF VENT: 143 SI EVE VENT: 143 SI VENTS REQUIRED: 3



ANNON HOMES, INC.
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A NEW CLISTOM RESIDENCE FOR

JIM & DARLEEN LEBARON
501 Yow/Lone | Longboot Rey, Feridel 34228
107 10 | COUNTRY CLUB SHORES | TOWN OF LBK

| DATE | COLONIA | COLONIA


DRAWING TITLE

ROOF PLAN

SHEET NUMBER

ROOF PLAN SCALE: 3/16" = 1'-0"

A3.0

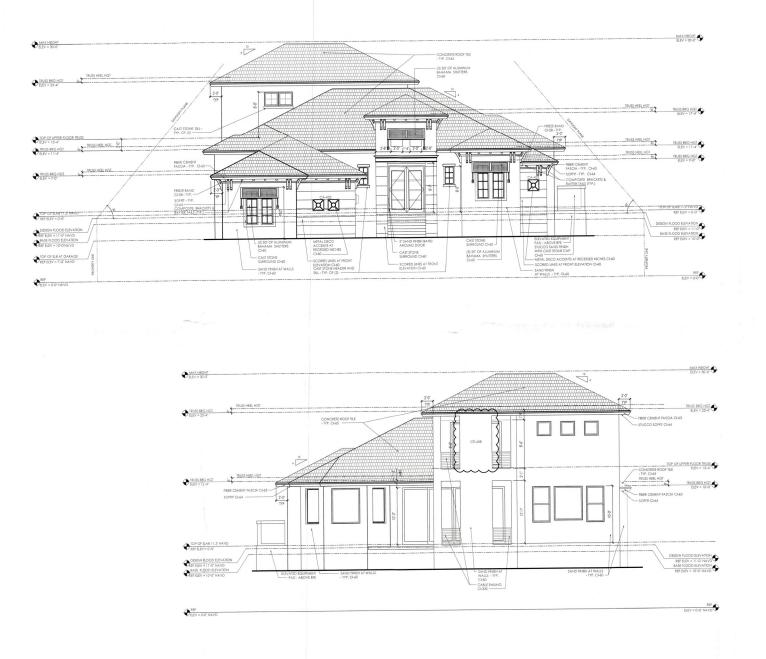

# **ELEVATION NOTES**

- S/8" SAND INISH CEMENTIOUS FARGE COAT OVER CONCRETE MASONY UNIST OR 7/8" SAND FINISH CEMENTITIOUS FARGE COAT OVER CONCRETE MASONY UNIST OR 7/8" SAND FINISH CEMENTITIOUS FARGE COAT OVER PAYERBACK WIRE LAIT OVER HOUSE WAP AND 1/2" SHEATHING, U.N.O.

  PARGE COAT TO FINISH 4" SELOW FINISH GRADE.

  ENTRY CELLINGS TO BE FARGE COAT OVER EVPANDED RIB METAL

  LAIT SHIP ON ALL BANDS, TIRM DEFAULS, AND WINDOW RETURNS FROM BANDS, U.N.O.

  FAD NALERS AS REQUIRED FOR FIBER CEMENT SOFFTIS.


  NO EXPOSED CONDUIT IN GARAGE OR ON EXTERIOR OF HOME.

  NO MECHANICAL HELETICAL GUIVINENT ON FROM TELEVATION.

  F. APPLICABLE, ALL MATERIALS BELOW THE DEF WILL BE MADE OF THE CONTROL OF THE CO

- REQUIRED FOR THE ELEVATOR OPERATION.

# TYPICAL COMPOSITE BRACKET DETAILS

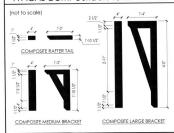

FRONT ELEVATION 1 FRONT ELE A4 SCALE: 3/16" = 1'-0"



A NEW CUSTOM RESIDENCE FOR JIM & DARLEEN LEBARON SOI YOW LONE | LONGBOOT Key, Florida | 34228-LOT 10 | COUNTRY CLUB SHORES | TOWN OF LBK



DRAWING TITLE EXTERIOR ELEVATIONS

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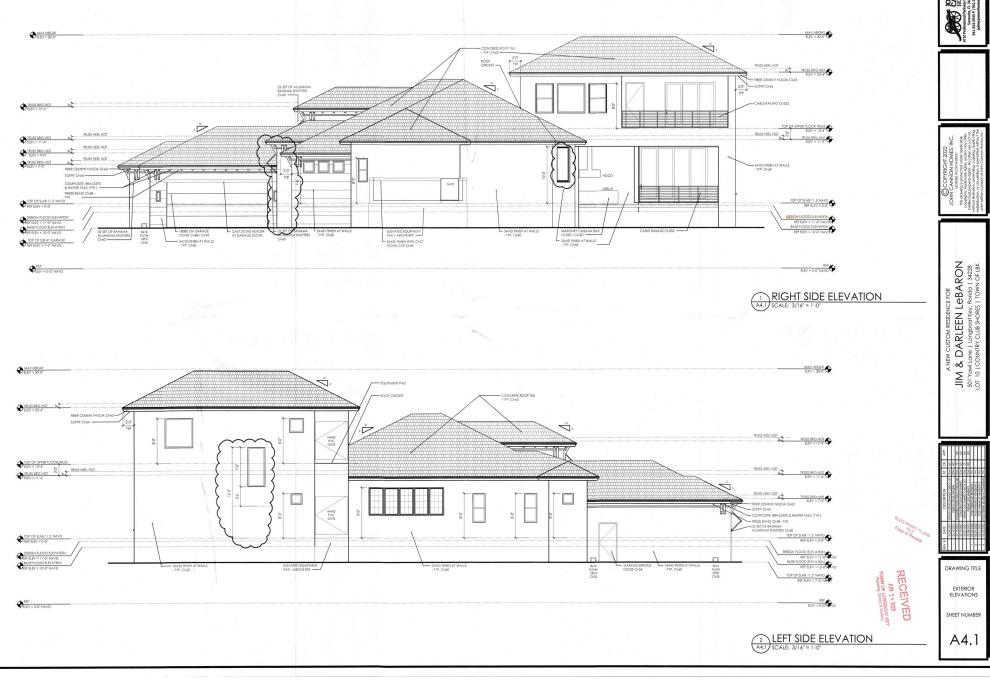
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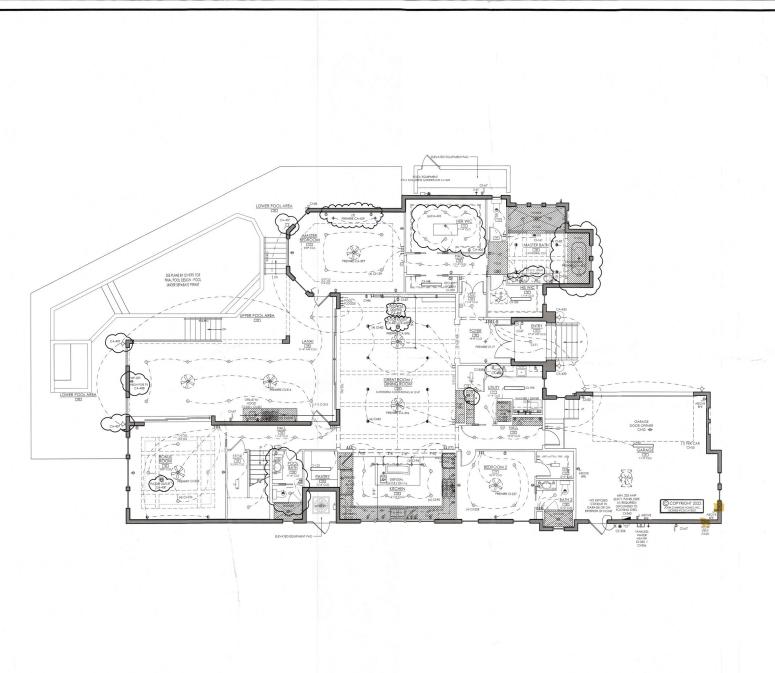
TO

A4.0 BLDG. PERMIT

REAR ELEVATION 2 REAR ELEV A4 SCALE: 3/16" = 1'-0"



CANNON
CANNON
HOMES
Dividence parket, Suite 100
Sensoda, Fl. 34240
941.924.935.9 | 941.924.135 F





# **ELECTRICAL NOTES**

- ELECTRICAL NOTES

  J. STRUCTURED WINNS SYSTEM, J. ACTIVE DULL PORT JACOS IS TWO DATA WITH STRUCTURED WINE ENCLOSIBRE AND 110 OUTLET, ONE MIN HOUSE CONTROLLER.

  2. ALL BECTRICAL TO BE RISTALLED AND SPEE UNLESS OTHERWISE ROCKETED, IS SHALL SWITCHES AND RECEPTACLES HERE POLICIAL TO SHALL SWITCHES AND RECEPTACLES HERE POLICIAL THE FOLICIAL SWITCHES.

  SWITCHES. 167 [UNLESS ABV COUNTERHOP]

  TELEPHONE: 167 [UNLESS ABV COUNTERHOP]

  AS NOICATED ON PLANS, TO INCLUDE GRAZGES, UTILITY ROOMS, STITCHES, MAIST, DOCK, AND LALT ERROID-UTILIEST REPORTED AND ROCKETS OF THE SWITCHES AND POLICIES AND ROCKETS OF THE SWITCHES AND POLICIES AND ROCKETS OF THE SWITCHES AND POLICIES AND ROCKETS AND ROCKETS OF THE SWITCHES AND POLICIES AND ROCKETS OF THE SWITCHES AND POLICIES AND ROCKETS AND ROCKETS OF THE SWITCHES AND POLICIES AND ROCKETS AND ROCKETS OF THE SWITCHES AND POLICIES AND ROCKETS AND RO
- Veden ALL APPLIANCE AND EQUIPMENT BECTIFICAL BEQUIPMENTS WITH ANALYSE MERIES AND DIOCESS SECTION TO WORKER ELECTRICAL OLD ANALYSE AND EACH AND ANALYSE AND ANALYSE AND ANALYSE AN



MAIN LEVEL ELECTRICAL PLAN SCALE: 3/16" = 1'-0"

DRAWING TITLE

MAIN ELECTRICAL

PLAN SHEET NUMBER

A6.1






DARLEEN LeBARON

**≈** Lou

JIM 8 501 Yaw LOT 10 J

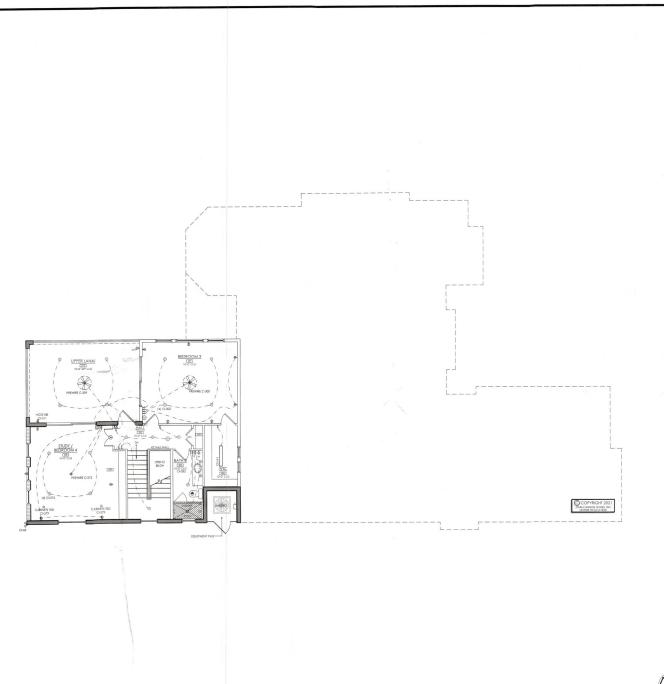



# ELECTRICAL NOTES

- STRUCTURED WIRING SYSTEM: (6) ACTIVE DUAL PORT JACKS (6 TV/6 DATA) WITH STRUCTURED WIRE ENCLOSURE AND 110 OUTLET, ONE

- 1. STRUCTURED WIRING SYSTEM. (6) ACTIVE DUAL PORT JACES (61Y/6) DATA) WIRIS RESUCTUBLE WIRE ENCLOSURE AND ITO OUTLET, ONE MINIHOUSE CONTROLLER.

  ALL RECEIVED AND SERVICE AS OVER SET, UNLESS OTHERWISE BY ALL RECEIVED AND RESULTED AND RESUL



RECEIVED

APR 0 8 2022 TOWN OF LONGBOAT KEY Planning, Zoping & Building

UPPER LEVEL ELECTRICAL PLAN



DARLEEN LEBARON
ane | Longboat Key, Florida | 34228
buntry CLUB SHORES | TOWN OF LBK JIM & DA 501 Yaw Lane 1 LOT 10 I COUNTR

DRAWING TITLE

UPPER LEVEL ELECTRICAL PLAN

SHEET NUMBER

A6.2

					V	VIND Z	ONE C	5			STATE OF FL.	
	LOCATION	QTY.	UNIT CALLOUT	SQ. FT.	SIGI	N PSI	MFF	R. PSI	MFG.	NOTES	APPROVAL #	EXPIRATION
					POSIT.	NEG.	POSIT.	NEG.			OR NOA #	DATE
П	ENTRY	1	6'-0" x 8'-0" IN-SWING DOOR	48	28.8	36.4	50.0	55.0		IMPACT		
2 0	MASTER BEDROOM	1	3080 1-LITE FRENCH DOOR	24	32.1	41.1	50.0	55.0	THERMATRU	IMPACT	FL-20470.12	12-31-21
< 18	GREAT ROOM	1	180100 PKT SGD	144	30.9	33.8	90.0	90.0	PGT	IMPACT	20-0401.03	07-30-25
	HALL 122	1	3080 1-LITE FRENCH DOOR	24	32.1	41.1	50.0	55.0	THERMATRU	IMPACT	FL-20470.12	(12-31-21
3	BONUS ROOM	1	120100 PKT SGD	120	28.3	33.9	60.0	60.0	PGT	IMPACT	20-0401.03	07-30-25
٦ [ ٔ	GARAGE 2	1	18080 OVERHEAD GARAGE DOOR	144	26.6	31.8	54.0	60.0	CLOPAY	IMPACT	20 0 10 1100	0. 00 20
$\perp$	GARAGE 2	1	2880 SERVICE DOOR	24	32.1	41.1	50.0	55.0	THERMATRU	IMPACT		
т.	STUDY	1	9080 SGD	72	27.4	33.5	60.0	60.0	PGT	IMPACT	20-0401.03	07-30-25
2 3	BED ROOM #3	1	9080 SGD	72	27.4	33.5	60.0	60.0	PGT	IMPACT	20-0401.03	07-30-25
	HALL 202	1	3080 1-LITE FRENCH DOOR	24	32.1	41.1	50.0	55.0	THERMATRU	IMPACT	FL-20470.12 /	12-31-21
3   5	5											

		LOCATION	QTY.	UNIT CALLOUT	SQ. FT.		VIND Z	ONE C	5 P. PSI	MFG.	NOTES	STATE OF FL. APPROVAL #	
		LOCATION	Q.II.	UNII CALLOUI	300.11.	POSIT.	NEG.	POSIT.		MrG.	NOIES	OR NOA #	EXPIRATIO DATE
		HIS WIC	1	20" x 36" FG	5	32.3	43.2	50.0	50.0	PGT	IMPACT	1921126,10	04-30-25
- 1		MASTER BATH	2	24" x 60" FG	10	30.8	40.2	50.0	50.0	PGT	IMPACT	(9)1126,10	04-30-25
		MASTER BATH	3	24" x 24" FG	4	32.3	43.2	50.0	50.0	PGT	IMPACT	19/1126.10	04-30-25
		MASTER BATH	1	14 SH	7	32.3	43.2	50.0	50.0	PGT	IMPACT	19 1126,10	04-30-25
S		MASTER BEDROOM	1	60" x 72" FG	30	31,2	40.0	50.0	50.0	PGT	IMPACT	19/1126,10	04-30-25
šΊ	œ	MASTER BEDROOM	2	26 SH	20	30.8	40.2	50.0	50.0	PGT	IMPACT	19/1126.10	04-30-25
ÓΙ	8	BONUS ROOM	1	60" x 72" FG	30	32.1	41.1	50.0	50.0	PGT	IMPACT	19-1126.10	04-30-25
۵Ι	F	BONUS ROOM	2	26 SH	20	30.8	40.2	50.0	50.0	PGT	IMPACT	19-1126.10	04-30-25
Z∥	S	POOL BATH	1	24" x 24" FG	4	32.3	43.2	50.0	50.0	PGT	IMPACT	121126.10	04-30-25
≥		KITCHEN	5	32" x 60" FG	13.3	30.8	40.2	50.0	50.0	PGT	IMPACT	19-1126.10	04-30-25
		BEDROOM #2	1	25 SH	16.5	30.8	40.2	50.0	50.0	PGT	IMPACT	19-1126.10	04-30-25
		BEDROOM #2	1	25 SH EGRESS	16.5	32.8	40.2	50.0	50.0	PGT	IMPACT	19 1126.10	04-30-2
		BATH #2	1	24" x 24" FG	4	32.3	43.2	50.0	50.0	PGT	IMPACT	19/1126,10	04-30-2
		GARAGE	2	24" x 60" FG	10	30.8	40.2	50.0	50.0	PGT	IMPACT	(19,1126,10	04-30-2
		GARAGE	1	20" x 36" FG	5	32.3	43.2	50.0	50.0	PGT	IMPACT	19 1126.10	04-30-2
		UTILITY	1	20" x 36" FG	5	32.3	43.2	50.0	50.0	PGT	IMPACT	19-1126.10	04-30-25
	П	WIC	2	30" x 30" FG	6.25	32.3	43.2	50.0	50.0	PGT	IMPACT	19-1126.10	04-30-2
0		BEDROOM #3	1	25 SH	16.5	30.8	40.2	50.0	50.0	PGT	IMPACT	1991126,10	04-30-2
ŠΙ	S	BEDROOM #3	1	25 SH EGRESS	16.5	30.8	40.2	50.0	50.0	PGT	IMPACT	19-1126.10	04-30-2
01	ŏ	BEDROOM #3	1	60" x 60" FG	25	32.1	41.1	50.0	50.0	PGT	IMPACT	12 1126.10	04-30-25
	F	STUDY	3	30" x 30" FG	6.25	32.3	43.2	50.0	50.0	PGT	IMPACT	19-1126.10	04-30-25
Z ≷	Z	STUDY	1	60" x 60" FG	25	32.1	41.1	50.0	50.0	PGT	IMPACT	19 1126.10	04-30-25
≥	CA	STAIRS	1	36" x 72" FG	18	30.8	40.2	50.0	50.0	PGT	IMPACT	19-1126.10	04-30-25
		BATH #3	1	30" x 30" FG	6.25	32.3	43.2	50.0	50.0	PGT	IMPACT	19-1126.10	04-30-25

CATEGORY	SUB CATEGORY	PRODUCT DESCRIPTION	MANUFACTURER	STATE OF FL. APPROVAL # OR NOA #	EXPIRATION DATE
WINDOWS					
	FIXED	SERIES PW-5520 VINYL FIXED WINDOWS	PGT	19-1126.10	04-30-25
	CASEMENT	SERIES CA-5540 VINYL CASEMENT WINDOW	PGT	20-0402.03	09-17-25
	SINGLE HUNG	SERIES SH-5500 VINYL SINGLE HUNG WINDOW	PGT	20-0401.03	07-30-25
EXT. DOORS					
	SERVICE	THERMATRU I/S O/S IMPACT SINGLE SERVICE DOOR	THERMATRU	FL-21142.4	12-31-21
	SINGLE	THERMATRU I/S O/S IMPACT SINGLE GLAZED	THERMATRU	FL-21142.10	12-31-21
	DOUBLE	THERMATRU I/S O/S IMPACT DOUBLE GLAZED	THERMATRU	FL-20470.12	12-31-21
	SGD	SERIES 770HP ALUMINIUM SLIDING GLASS DOORS	PGT	19-1126.04	03-24-25
	SGD CORNER	SERIES SGD-770 ALUMINIUM SLIDING GLASS DOORS 90 & 135 DEGREE	PGT	20-0401.03	07-30-25
	SGD	SERIES 5570/2770 VINYL SLIDING GLASS DOOR	PGT	17-0420.06	04-14-21
	GARAGE OHD	W8 SECTIONAL GARAGE DOOR UP TO 9'	CLOPAY	0 - 120100	011121
	GARAGE OHD	W6 DP37 STEEL SECTIONAL GARAGE DOOR UP TO 20'	CLOPAY		
	GARAGE OHD	CANYON RIDGE W8 DP54 STEEL SECTIONAL GARAGE DOOR UP TO 9'	CLOPAY		
	GARAGE OHD	CANYON RIDGE W8 DP46T STEEL SECTIONAL GARAGE DOOR UP TO 16"	CLOPAY		
MISC.					
	ROOFING TILE	CONCRETE ROOF TILE	EAGLE ROOFING	(18-0509.18	10-05-21
	UNDERLAYMENT	BORAL TILESEAL	BORAL	18-0502.03	08-02-23
	ROOF VENTS	O'HAGINS CLOAKED VENT TILE	O'HAGINS	19-0109.02	04-04-24
	SIDING/SOFFIT	FIBER CEMENT SIDING/SOFFIT	JAMES HARDIE	(17-0406.06	05-01-22

y heavested current testing of current North purificate times.

DRAWING TITLE


NOTES & SCHEDULES


SHEET NUMBER


A7.0





A NEW CUSTOM RESIDENCE FOR JIM & DARLEEN LEBARON SD Yorwitone | Longood Yey, Roided | 34228 LOT 10 | COUNTRY CLUB SHORES | TOWN OF LBK

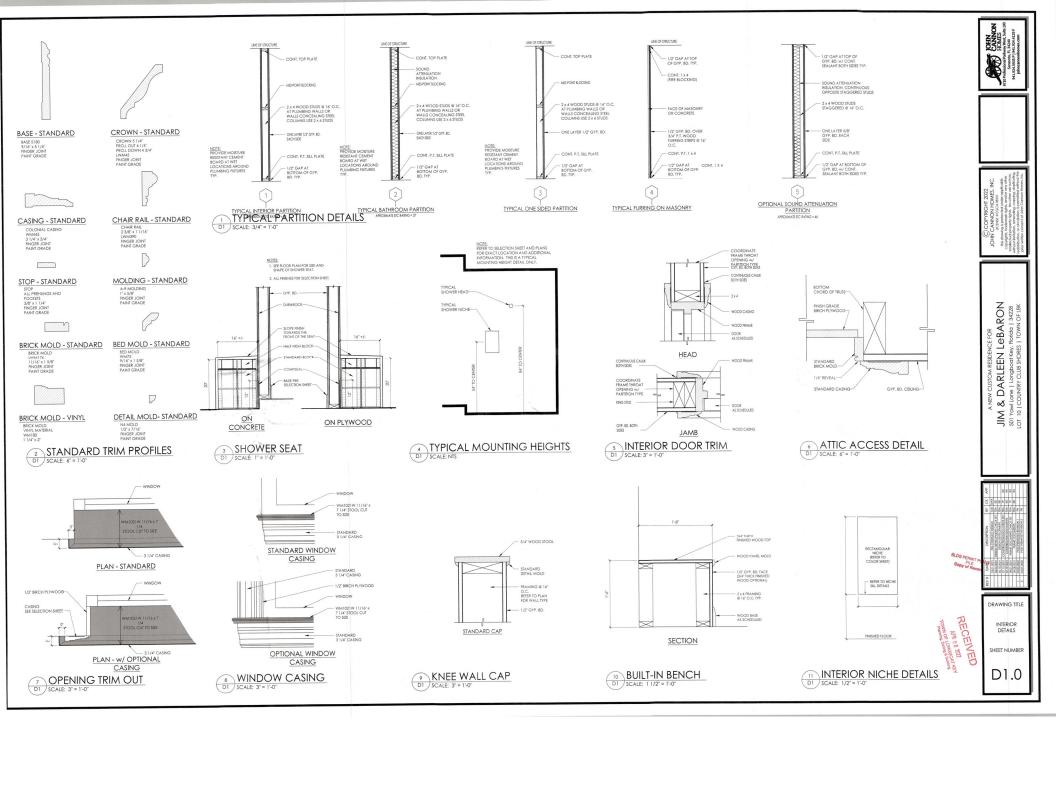


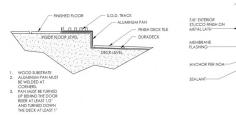

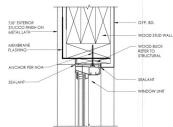

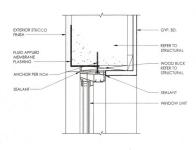

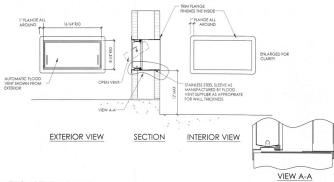

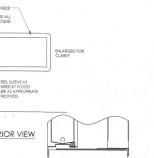

2 HEAD @ FRAME WALL D2 SCALE: 3" = 1'-0" SILL @ SGD - UPPER LANAI

3 HEAD @ CMU WALL D2 SCALE: 3" = 1'-0"


FLOW THRU VENT

A NEW CUSTOM RESIDENCE FOR

JIM & DARLEEN LEBARON

501 Youkling | Longboot key, Florida | 34228


LOT 10 | COUNIRY CLUB SHORES | TOWN OF LBK

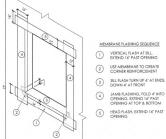



MEMBRANE FLASHING SEQUENCE

2 USE MEMBRANE TO CREATE CORNER REINFORCEMENT


3 SILL FLASH TURN UP 6" AT ENDS, DOWN 4" AT FRONT

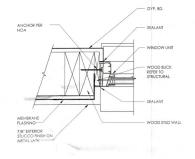

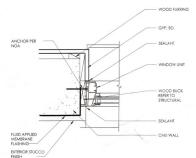

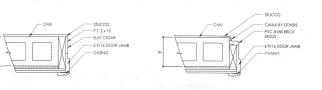

5 FRAME WALL FLASHING

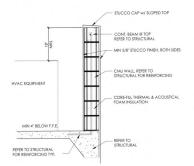



6 JAMB @ FRAME WALL SCALE: 3" = 1'-0"





DOOR JAMB @ CMU WALL

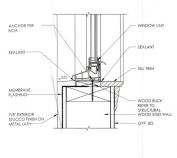

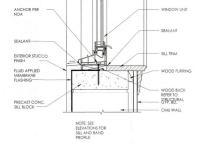



RECEIVED
APR 18 707 APR
TO MARIA SERVICE SERVICE
TO MARIA SERVICE SERVICE
TO MARIA SERVICE

SOUND SCREEN WALL
D2 SCALE: 3/4" = 1'-0"

SILL @ FRAME WALL

12 SILL @ CMU WALL D2 SCALE: 3" = 1'-0"

SHEET NUMBER


DRAWING TITLE

EXTERIOR DETAILS

D2.0

08.24.2021

S1.0

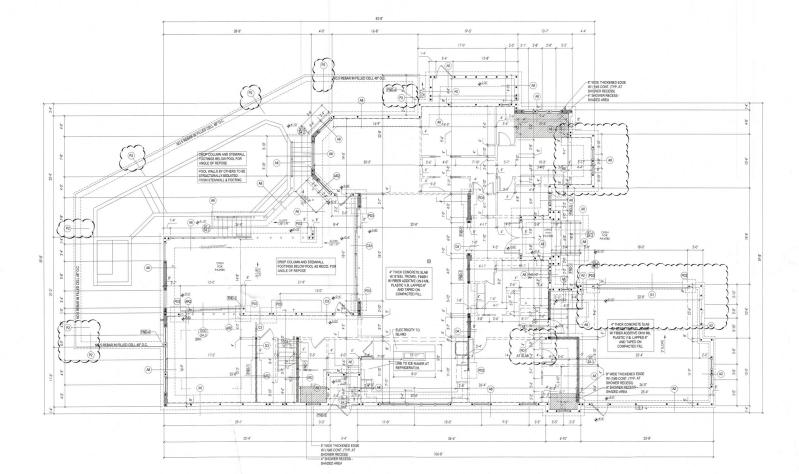

## GENERAL NOTES

# STRUCTURAL SCHEDULE

DESCRIPTION

DESCR

FND-2 TOP OF FOOTING MIN. 6" BELOW GRADE

INCREASE FOOTING WIDTH MIN, 6" PAST CMU ON EACH SIDE, ADD 1 NO. 5 REBAR 8" O.C. EACH WAY 3" FROM BOTTOM.

FND-4 INTERLACE HOUSE AND POOL STEMWALLS

FND-5 6" THICK 3000PSI CONCRETE SLAB WITH NO. 5 REBAR 12" O.C. EACH WAY AT MIDHEIGHT - SLOPE TOP [1/FT FOR DRAINAGE

# FILLED CELLS


- INDICATES FILLED CELL WI(1) REBAR FROM FOOTING OR LOWER TIE BEAM TO TIE BEAM STEEL
- ☐ INDICATES FILLED CELL W/(1) #5 REBAR FROM FOOTING TO TOP OF STEMWALL
- INDICATES FILLED CELL wi(2)#5 OR (1)#7 REBAR FROM FOOTING OR LOWER TIE BEAM TO TIE BEAM STEEL
- | X | INDICATES FILLED CELL POURED TO 1' ABOVE HOSE BIB WI'I #5 AT ALL HOSE BIB LOCATIONS


# DIMENSION NOTES

SEE ARCHITECTURAL PLANS FOR DIMENSIONS NOT SHOWN ON STRUCTURAL SHEETS.

- 4" THICK 3000 PSI CONCRETE SLAB WI STEEL TROWEL FINISH WI FIBER ADDITIVE ON 6 MIL VAPOR BARRIER LAPPED & TAPED
   SEE \$4.0"GENERAL NOTES' FOR COMPACTION REQUIREMENTS



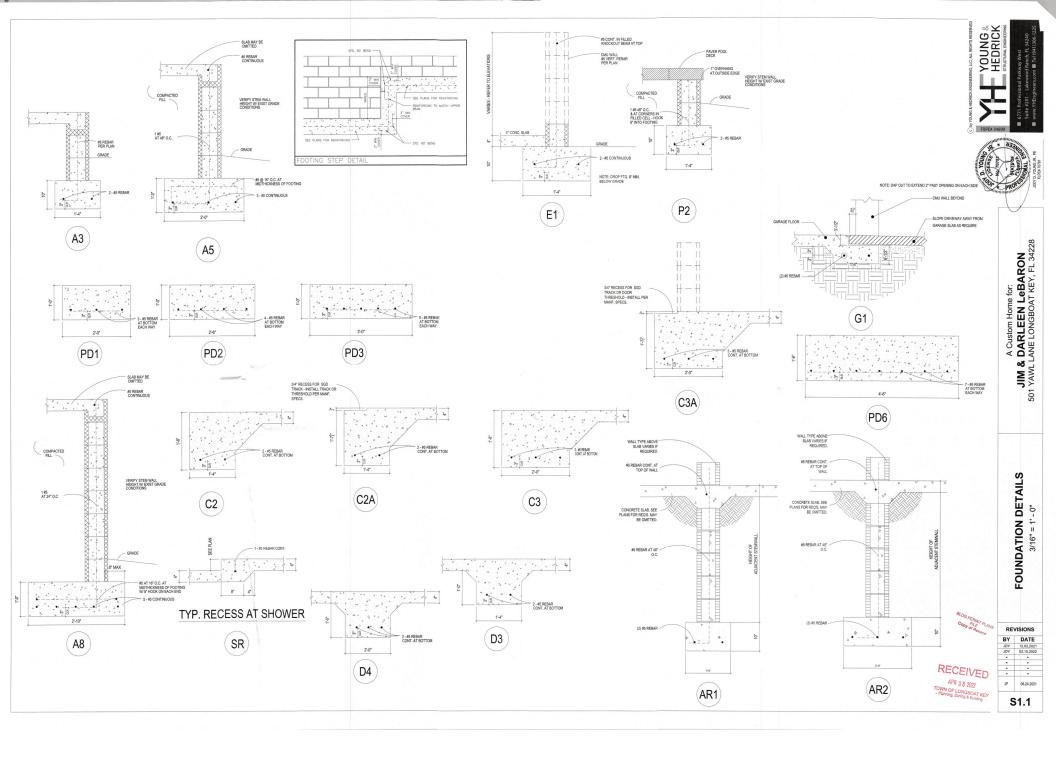

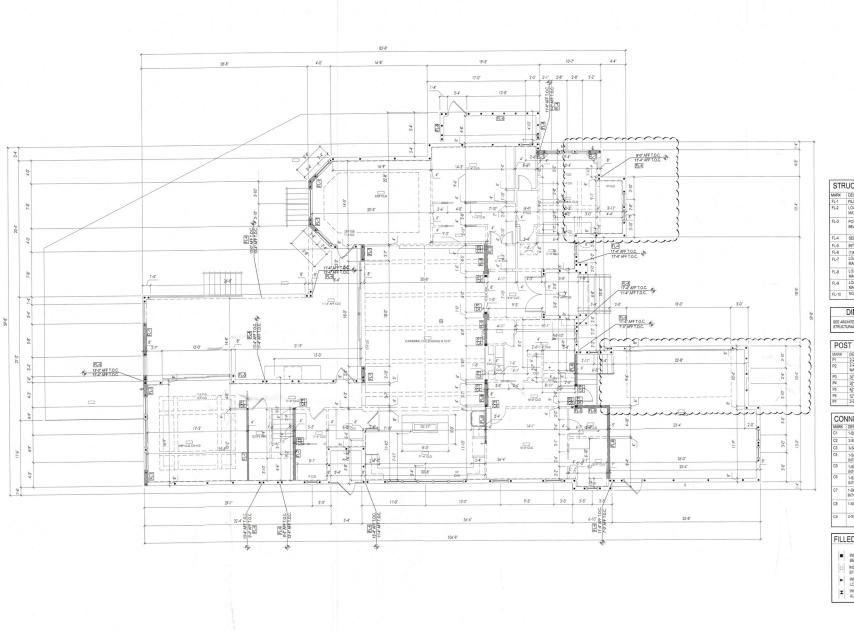



A Custom Home for:

JIM & DARLEEN LeBARON
501 YAWL LANE LONGBOAT KEY, FL 34228

511	RUCTURAL SCHEDULE
MARK	DESCRIPTION
FL-1	FILL ALL CELLS
FL-2	LOAD BEARING WALL - 2X SPF STUDS 16" O.C. MATCH WALL THICKNESS, TOP AT 12:0"
FL-3	POST SHALL NOT BEAR ON BOTTOM PLATE USE STEEL SHIM OF BEAR ON SLAB WI MOISTURE PROTECTION
FL-4	SEE TIE-BEAM STEP DETAIL ON SHEET \$4.2
FL-5	INTERLACE MASONRY UNITS WITH WALL
FL-6	(1)#5 CONT. IN FILLED COURSE AT TOP OF WALL
FL-7	LOAD BEARING WALL - 2X SPF STUDS 16" O.C. MATCH WALL THICKNESS. TOP AT 13"-4"
FL-8	LOAD BEARING WALL - 2X SPF STUDS 16" O.C. MATCH WALL THICKNESS, TOP AT 11"-4"
FL-9	LOAD BEARING WALL - 2X SPF STUDS 16" O.C. MATCH WALL THICKNESS. TOP AT 10"-0"
FL-10	NO.5 REBAR CONT. IN FILLED COURSE BELOW WINDOW

# DIMENSION NOTES

SEE ARCHITECTURAL PLANS FOR DIMENSIONS NOT SHOWN ON STRUCTURAL SHEETS.

POS	ST SCHEDULE	[
MARK	DESCRIPTION	
P1	2-2X SPF STUDS - MATCH WALL THICKNESS	
P2	2-2X SPF STUDS PLUS ADD'L. JACK STUD MATCH WALL THICKNESS	
P3	3]* X 3]* VERSALAM 1.8 2750 COLUMN	
P4	3]* X 5]* VERSALAM 1.8 2750 COLUMN	
P5	5[* X 5]* VERSALAM 1.8 2750 COLUMN	
P6	5[* X 7* VERSALAM 1.8 2750 COLUMN	
D7	2,2YR GVD STLIDS DLUG ADDI. GVD JACK STLID	

MARK	DESCRIPTION
C1	1-SIMPSON CS16 TO BEAMWALL BELOW
C2	2-SIMPSON CS16 TO BEAMWALL BELOW
C3	3-SIMPSON CS14 TO BEAMWALL BELOW
C4	1-SIMPSON LTT19 W §* DIA. ALL-THREAD DRILLED & EPOXIED 4* INTO FOOTING WITH SIMPSON SET EPOXY (T=1310W)
C5	1-SIMPSON HTT4 W/ (* DIA. ALL-THREAD DRILLED & EPOXIED 4* INTO FOOTING WITH SIMPSON SET EPOXY (T=3810#)
C6	1-SIMPSON HTTSKT W \$ DIA. ALL-THREAD DRILLED & EPOXIED 5 INTO FOOTING WITH SIMPSON SET EPOXY (T=5445#)
C7	1-SIMPSON HD7B W/ 7/8 * ALL-THREAD DRILLED AND EPOXIED 6* INTO FOOTING BELOW WITH SIMPSON SET EPOXY
C8	1-SIMPSON MSTAM36 TO CONCRETE BEAM BELOW
C9	2-SIMPSON MSTAM36 TO CONCRETE BEAM BELOW

## FILLED CELLS

- INDICATES FILLED CELL WI(1) REBAR FROM FOOTING OR LOWER THE BEAM TO THE BEAM STEEL

  INDICATES FILLED CELL WI(1) #5 REBAR FROM FOOTING TO TOP OF STEMMALL
- INDICATES FILLED CELL w(2)#5 OR (1)#7 REBAR FROM FOOTING OR OWNER TIE BEAM TO TIE BEAM STEEL

  MIDICATES FILLED CELL POURED TO 1' ABOVE HOSE BIB WI1 #S AT ALL HOSE BIB LOCATIONS

RECEIVED APR n 8 2022

Planning, Zoning & building

BY DATE
JDY 12.02.2021
JDY 03.15.2022
- - - -JP 08.24.2021

REVISIONS

FIRST FLOOR STRUCTURAL PLAN 3/16" = 1' - 0"

S2.0





STRUCTURAL SCHEDULE FL-1 MARK DESCRIPTION
FL-1 FILL ALL CELLS
FL-2 LOAD BEARING WALL - 2X SPF STUDS 16" O.C.
MATCH WALL THICKNESS. TOP AT 12-0" POST SHALL NOT BEAR ON BOTTOM PLATE USE STEEL SHIM OR BEAR ON SLAB W/ MOISTURE PROTECTION FL-4 SEE TIE-BEAM STEP DETAIL ON SHEET \$4.2 FL-5 INTERLACE MASONRY UNITS WITH WALL
FL-6 (1)#S CONT. IN FILLED COURSE AT TOP OF WALL
FL-7 LOAD BEARING WALL - 2X SPF STUDS 16" O.C.
MATCH WALL THICKNESS, TOP AT 13"-4" MATCH WALL THICKNESS. TOP AT 15-4\*

FL-8 LOAD BEARING WALL - 2X SPF STUDS 16" O.C.
MATCH WALL THICKNESS. TOP AT 11-4\*

FL-9 LOAD BEARING WALL - 2X SPF STUDS 16" O.C.
MATCH WALL THICKNESS. TOP AT 10"

FL-10 NO.5 REBAR CONT. IN FILLED COURSE BELOW WINDOW

# DIMENSION NOTES

SEE ARCHITECTURAL PLANS FOR DIMENSIONS NOT SHOWN ON STRUCTURAL SHEETS.

POS	ST SCHEDULE	
MARK	DESCRIPTION	
P1	2-2X SPF STUDS - MATCH WALL THICKNESS	
P2	2-2X SPF STUDS PLUS ADD'L, JACK STUD MATCH WALL THICKNESS	
P3	3)* X 3)* VERSALAM 1.8 2750 COLUMN	
P4	3]* X 5]* VERSALAM 1.8 2750 COLUMN	
P5	5[" X 5]" VERSALAM 1.8 2750 COLUMN	
P6	5]* X 7* VERSALAM 1.8 2750 COLUMN	
P7	2-2X6 SYP STUDS PLUS ADD L. SYP JACK STUD	

MARK	DESCRIPTION
C1	1-SIMPSON CS16 TO BEAM/WALL BELOW
C2	2-SIMPSON CS16 TO BEAMWALL BELOW
C3	3-SIMPSON CS14 TO BEAMWALL BELOW
C4	1-SIMPSON LTT19 W/ (* DIA. ALL-THREAD DRILLED & EPOXIED 4" INTO FOOTING WITH SIMPSON SET EPOXY (T=1310#)
C5	1-SIMPSON HTT4 W \$" DIA. ALL-THREAD DRILLED & EPOXIED 4" INTO FOOTING WITH SIMPSON SET EPOXY (T=36108)
C6	1-SIMPSON HTTSKT W/ [* DIA. ALL-THREAD DRILLED & EPOXIED 5" INTO FOOTING WITH SIMPSON SET EPOXY (T=5445#)
C7	1-SIMPSON HD7B WI 7/8 " ALL-THREAD DRILLED AND EPOXIED 6" INTO FOOTING BELOW WITH SIMPSON SET EPOXY
C8	1-SIMPSON MSTAM36 TO CONCRETE BEAM BELOW
C9	2-SIMPSON MSTAM36 TO CONCRETE BEAM BELOW

# FILLED CELLS

1	•	INDICATES FILLED CE BEAM TO TIE BEAM ST
- 1	1_1	INDIOLYTES SHARE OF

- ELL W/(1) REBAR FROM FOOTING OR LOWER TIE TEEL STEMWALL
- INDICATES FILLED CELL wi(2)#5 OR (1)#7 REBAR FROM FOOTING OR LOWER THE BEAM TO THE BEAM STEEL
   INDICATES FILLED CELL POURD TO 1" ABOVE HOSE BIB WI1 #5 AT ALL HOSE BIB LOCATIONS

RECEIVED

APR n 8 2022 FOWN OF LONGBOAT KEY.
4. Planning, Zoring & Building JDY 12.02.2021 JDY 03.15.2022 JP 08.24.2021

4'-8" P3 PT UNDER C2 GIRDER 4" SHOWER RECESS -3'-3" 32-4"


A Custom Home for:

JIM & DARLEEN LeBARON
501 YAWL LANE LONGBOAT KEY, FL 34228

SECOND FLOOR STRUCTURAL PLAN 3/16" = 1' - 0"

REVISIONS

S2.1

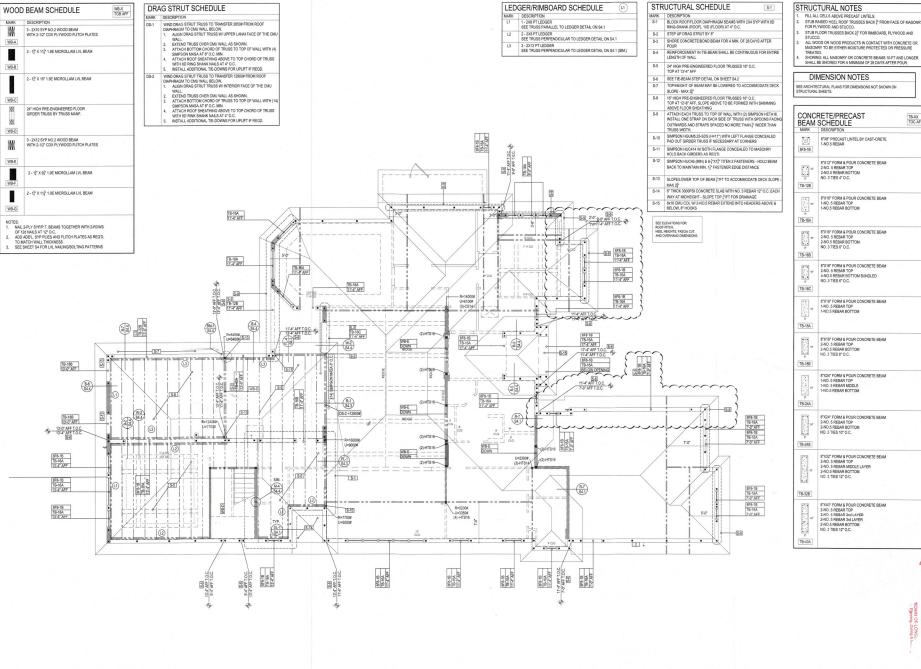

FILL ALL CELLS ABOVE PRECAST LINTELS.

STUB RAISED HEEL ROOF TRUSSES BACK (\*FROM FACE OF MASONRY FOR PLYWOOD AND STUCCO.

STUB FLOOR TRUSSES BACK 21 FOR RIMBOARD, PLYWOOD AND STUCCO.

SEE ARCHITECTURAL PLANS FOR DIMENSIONS NOT SHOWN ON STRUCTURAL SHEETS.

MARK	DESCRIPTION	
[] 8F8-1B	8"X8" PRECAST LINTEL BY CAST-CRETE 1-NO.5 REBAR	
E 02	8"X12" FORM & POUR CONCRETE BEAM 2-NO. 5 REBAR TOP 2-NO. 5 REBAR BOTTOM NO. 3 TIES 4" O.C.	
TB-12B		
1 m	8"X16" FORM & POUR CONCRETE BEAM 1-NO. 5 REBAR TOP 1-NO.5 REBAR BOTTOM	
TB-16A		
TB-16B	8"X16" FORM & POUR CONCRETE BEAM 2-NO. 5 REBAR TOP 2-NO.5 REBAR BOTTOM NO. 3 TIES 6" O.C.	
TB-16C	8"X16" FORM & POUR CONCRETE BEAM 2-NO.5 REBAR TOP 4-NO.5 REBAR BOTTOM BUNDLED NO. 3 TIES 6" O.C.	
TB-18A	8"X18" FORM & POUR CONCRETE BEAM 1-NO. 5 REBAR TOP 1-NO. 5 REBAR BOTTOM	
TB-188	8"X18" FORM & POUR CONCRETE BEAM 2-NO. 5 REBAR TOP 2-NO. 5 REBAR BOTTOM NO. 3 TIES 8" O.C.	
TB-24A	8"X24" FORM & POUR CONCRETE BEAM 1-NO. 5 REBAR TIOP 1-NO. 5 REBAR MIDDLE 1-NO.5 REBAR BOTTOM	
7B-24B	8"X24" FORM & POUR CONCRETE BEAM 2-NO. 5 REBAR TOP 2-NO. 5 REBAR BOTTOM NO. 3 TIES 10" O.C.	
	8°X32° FORM & POUR CONCRETE BEAM 2-NO. 5 REBAR TOP 2-NO. 5 REBAR MIDDLE LAYER 2-NO. 5 REBAR BOTTOM NO. 3 TIES 12° O.C.	
TB-32B		
	8"X40" FORM & POUR CONCRETE BEAM 2-NO. 5. REBAR TOP 2-NO. 5. REBAR 2nd LAYER 2-NO. 5. REBAR 3nd LAYER 2-NO. 5. REBAR 80 TITOM NO. 3. TIES 12" O.C.	

YOUNG & HEDRICK

A Custom Home for:

JIM & DARLEEN LEBARON

501 YAWL LANE LONGBOAT KEY, FL 34228


FIRST FLOOR FRAMING PLAN

REVISIONS

BY DATE JDY 12.02.2021 JDY 03.15.2022 08.24.2021

APR () 8 7077
TOWN OF LONG.
Plymining, Zoning & Summer

S3.0

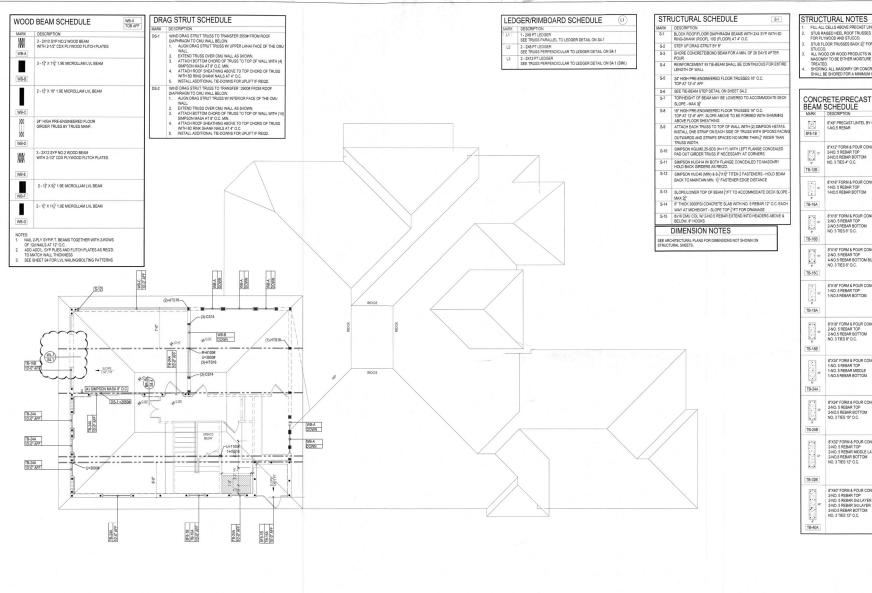

STRUCTURAL NOTES

FILL ALL CELLS ABOVE PRECAST LINTELS.
STUB RAISED HEEL ROOF TRUSSES BACK (\*FROM FACE OF MASONRY

FOR PLYWOOD AND STUCCO.
STUB FLOOR TRUSSES BACK 2]\* FOR RIMBOARD, PLYWOOD AND

STUCEO.
ALL WOOD OR WOOD PRODUCTS IN CONTACT WITH CONCRETE OR
ALL WOOD OR WOOD PRODUCTS IN CONTACT WITH CONCRETE OR
MASONRY TO BE EITHER MOISTURE PROTECTED OR PRESSURE
TREATED.
SHORING: ALL MASONRY OR CONCRETE BEAMS 10-FT AND LONGER
SHALL BE SHORED FOR A MINIMUM OF 28 DAYS AFTER POUR.

BEAM	RETE/PRECAST SCHEDULE	TB-XX TOC A
MARK  SF8-1B	DESCRIPTION  8'X8' PRECAST LINTEL BY CAST-CRETE 1-NO.5 REBAR	
TB-128	8"X12" FORM & POUR CONCRETE BEAM 2-NO. S REBAR TOT 2-NO. S REBAR BOTTOM NO. 3 TIES 4" O.C.	
TB-16A	8"X16" FORM & POUR CONCRETE BEAM 1-NO.5 REBAR TOP 1-NO.5 REBAR BOTTOM	
TB-16B	8"X16" FORM & POUR CONCRETE BEAM 2-NO. 5 REBAR TOP 2-NO.5 REBAR BOTTOM NO. 3 TIES 6" O.C.	
15 16C	8"X16" FORM 8 POUR CONCRETE BEAM 2-NO.5 REBAR TOP 4-NO.5 REBAR BOTTOM BUNDLED NO. 3 TIES 6" O.C.	
18°	8"X18" FORM & POUR CONCRETE BEAM 1-NO.5 REBAR TOP 1-NO.5 REBAR BOTTOM	
TB-18B	8"X18" FORM & POUR CONCRETE BEAM 2-NO. 5 REBAR TOP 2-NO.5 REBAR BOTTOM NO. 3 TIES 8" O.C.	
TB-24A	8"X24" FORM & POUR CONCRETE BEAM 1-NO. 5 REBAR TOP 1-NO. 5 REBAR MIDILE 1-NO.5 REBAR BOTTOM	
i se	8"X24" FORM & POUR CONCRETE BEAM 2-NO. 5 REBAR TOP 2-NO. 5 REBAR BOTTOM NO. 3 TIES 10" O.C.	
TB-24B	8"X32" FORM & POUR CONCRETE BEAM 2-NO. 5 REBAR TOP 2-NO. 5 REBAR MIDDLE LAYER 2-NO.5 REBAR BOTTOM NO. 3 TIES 12" O.C.	
TB-32B		
FB-40A	8"X40" FORM & POUR CONCRETE BEAM 2-NO. 5 REBAR TOP 2-NO. 5 REBAR 2014 LAYER 2-NO. 5 REBAR 2014 LAYER 2-NO. 5 REBAR BOTTOM NO. 3 TIES 12" O.C.	

YOUNG & HEDRICK

A Custom Home for:

JIM & DARLEEN LeBARON

501 YAWL LANE LONGBOAT KEY, FL 34228

ROOF FRAMING PLAN 3/16" = 1' - 0"

REVISIONS

MAR 2 2 2023
TOWN OF LONGBOAT KEY
Planting, Zoning & Building BY DATE JP 08.24.2021

RECEIVED

THESE DRAWINGS/LETTERS HAVE BEEN

DATE SEALED: March 10, 2023

I HESSE LIFAMINISSILE I I HERS HAVE BEEN JODY D. YOUNG JR., PE, USING A DIGITAL SIGNATURE. PRINTED COPIES OF THIS DOCUMENT ARE NOT CONSIDERED SIGNED AND SEALED. THE SIGNATURE MUST BE VERIFIED ON ANY ELECTRONIC COPIES. SIGNED: STRUCTURAL ONLY S3.1

- 1. ILEGENERAL MOLES
  1. PRO PRESENT DO SON GOING BUCKNO CODE THI ESTITON.
  1. PRO REFERS TO SON FORMS BUCKNO CODE. THI ESTITON.
  1. PRO REFERS TO SON FORMS BUCKNO CODE. THE ESTITON.
  1. CORRECT SON FOR 1. SOF FORMS THE THIS BUCKNO SHE PARK PLAYS A MARGIN OF 26° AFF OF DUSING PRIME THE MUCH SON SHE PARK PLAYS A MARGIN OF 26° AFF OF THE MUCH PRIME PRIME PROPERTY OF THE MUCH PRIME PROPERTY OF THE MUCH PRIME PROPERTY OF THE MUCH PRIME PRIME

#### 2. CONCRETE/MASONRY NOTES

- ALL COORDETS PALL SE PA-SOURCE
  MANDARY SOLL LIST PER SOUTHER, TO-HISDOPS,
  REMPORCHS STELL SHALL STATEY ASTEM MASS, GO 66, FOOTING MAY USE
  06 STEEL.
  WITH REMPORCHOS STELL FROM FOOTING TO THE SEAR MICHORED STELL
  WITH REMPORCHOS STELL FROM FOOTING TO THE SEAR MICHORED STELL
  FROM REMPORCHOS STELL FROM FOOTING TO THE SEAR MICHORED FROM FOOTING TO THE SEAR MICHORED STELL STATE AND THE SEAR MICHORED STELL STATE AND THE SEAR MICHORED FROM FOOTING THE SEAR MICHORED STELL STATE AND THE SEAR MICHORED STATE AND T 2.4
- POUNDATION STEEL.

  2.8 FOUNDATION DOWELS AND VERTICAL REINFORCING SPACES AS SHOWN ON FLOOR PLANS. IN THE EVENT OF CONFLICTS, THE FLOOR PLANS SHALL TAKE PRECEDENCE OVER THE FOUNDATION PLAN.
- ALL FOOTINGS TO BE SMOOTH AND LEVEL.
  REINFORCING STEEL LAP LENGTH IN CONCRETE AND/OR MASONRY SHALL.
- BE: #5 REBAR -30"
- SE SERIAR OV 16 SERIAR OV 17 SERIAR OV 18 SE

- THISSES WITH UPLIFE DICEDING 2003.85 U.M.

  21 MINIMAN CONCRETE COVERY OF LAND AND STOM AND YELSE UN D.

  ANDMAN CONCRETE COVERY OF U.M.

  213 BERECORD THISS ANCHORS SHOULD RESTALLED IN ACCORDANCE WITH

  MANUFACTURES REQUIREMENTS.

  244 MANUFACTURES REQUIREMENTS.

  245 MANUFACTURES REQUIREMENTS.

  246 MANUFACTURES REQUIREMENTS.

  247 MANUFACTURES REQUIREMENTS.

  248 MANUFACTURES SHALL BE REPORT ANCORDANCE WITH STANDARD

  PRACTICE FOR BRACKING MASCHIEF WALLS INFORC CONSTRUCTION

  MANUFACTURES ASSOCIATION OF MERCEN, AUX 2005.
- PRACTICE FOR BRADING MADONEY WALLS WICER CONSTRUCTION MADON CONTRACTION AS MORE CONTRACTION OF AMERICA, JULY 2011.

  18 THE CONCRETE THE BEAM AT TOP OF ALL WALLS SHALL BE AN SYSTE WITH (1) NO. S CONTRIBUTIONS FOR AND BOTTOM LIVE.

  1.17 BEAM SIZES SHOWN ON DRAWINGS ARE MINIMUM NORMAL CIMENSIONS BEAM SIZES WHO WE NO REASHED BY TO TO IT OT ACCOMMICDATE ON SITE BEAM REQUIREMENTS PROVIDED THAT THE DISTANCE BETWEEN TOF AND BOTTOM REPROCROKES STEEL REMAINS THE SEAM OF SIX INCREASED.

#### 3. FRAMING NOTES

- 3.1 ALL DOOR HEADERS AT BEARING WALLS TO BE (2) 2X10 SYP OR BETTER, U.N.O.
  3.2 EXTERIOR FRAME WALLS, BEARING OR NON BEARING, SHALL BE SHEATHED
- WITH #F PLYWOOD OR EQUAL, BLOCKED AND NAILED WITH 8d AT 4" O.C. EDGES, 8" O.C. FIELD.
  SHEAR WALL AND EXTERIOR WALL PLYWOOD SHEATHING SHALL BE BLOCKED.

- 33 SERVING MAD EXTENSIVE MULTI-VINUOUS DESIGNATIONS CONTINUED.

  TRUSSES AND EMBAS SHALL BEAR DESCRIPT VOI PISCO RES PROSTS UN D.

  WHERE REQUIRED, PRIEST DE RAS STEEL ULA.

  15 PAG. OR STP POSTS SHALL BEAR DEFECTIVE VOI DOUGRETE SLAS OR ON STP

  16 FEBRUAR DESCRIPTIONS SHOWN ON MANUFACTURED TRUSS FLASS SHALL

  16 EKESTU NO. ON DIRAMENTES SHEED ROOFF,FOOR LAND FLAST

  17 BILD OUTS SHALL BE ATTACHED TO THE MASCHINCHONCRETE WITH AT

  18 FEBRUAR TO G. WITH HANNIAU MEREDIRATIO F. ST

  18 FEORS SHEATHING SHALL BE \$7 FED FLYWOOD OR EQUILAL, PASTEMED WITH

  19 MINISTRATION OF COLDEDS AND CO. FRED UNIO.

# 4, WOOD NOTES

- 4.1 PSL: 1.8E PARALLEL STRAND LUMBER, Fbr-2400psi
  4.2 LVL: 1.5E LAMINATED VENEER LUMBER, Fbr-2600psi
  4.3 PT. PRESSURE THEATED SOUTHERN PINE 'E GRADE OR BETTER
  4.4 SPF: SPRIUCE PINE FIR #2 GRADE OR BETTER

#### 5. ROOF FRAMING NOTES

- THE DESIGN OF ROOF FRAMING SHALL BE BASED ON THE REQUIREMENTS OF THE FBC-R.

- 15 THE DEBING OF ROOF FRAMING SHALL BE BASED OF THE RECURRENMENTS
  OF THE PROPERTY OF THE PROPE

#### 6. DESIGN LOADS AND NOTES

- ROOF TRUSSES D+L
   SEPSF WI 1.33 STRESS INCREASE FACTOR, OR
   45PSF WI 1.25 STRESS INCREASE FACTOR, OR
   41PSF WI 1.00 STRESS INCREASE FACTOR.

- ASPER VILLS STRESS RECREASE FACTOR, OR
  ADDRESS RECREASE FACTOR.

  SEPER VILLS STRESS RECREASE FACTOR.

  DESPER VILLS STRESS RECREASE FACTOR.

  SEPER VILLS STRESS RECREASE FACTOR.

  SEPER VILLS STRESS RECREASE FACTOR.

  MINE STRESS RECREASE FACTOR.

  MI

#### 7. WIND NOTES

- 7.1 WIND LOADS ARE BASED ON A WIND VELOCITY OF 150 MPH APPLIED FOR A
- 7.1 WIND LOADS ARE BASED ON A VIMOV BUILDOTTY OF 150 JMPH APPLIED FORA .
  PILLY FROLED STRICTIONS.
  7.1 THE PROPERTY OF THE PROP

#### 8. PEST/DECAY PROTECTION NOTES

- ALL PLANTINGS AND IRRIGATIONSPRINKLER SYSTEMS AND RISERS FOR SPRAY HEADS SHALL BE AT LEAST 1-0" FROM BUILDING SIDEWALLS.
   IN WALL PEST TUBING AND BORA CAPE TREATMENT ON ALL TREFING WOOD PROVIDES SUBTERFANEAN TERNITE ABATEMENT AS WELL AS
- PROVIDES SUBTERANIEAN TERMITE ANATEMENT AS WELL AS PROTECTION AGAINST WOOD CESTROWNS ORGANISMS.

  8.3 WOOD GRADE STAKES SHALL NOT BE USED.

  8.4 PROTECTION AGAINST DECAY AND TERMITES SHALL BE PROVIDED IN ACCORDANCE WITH THE DECTIONS B317 AND R318.

  8.5 RODE FLASHING SHALL BE PROVIDED IN ACCORDANCE WITH THE REQUIREMENTS OF FIG. SECTIONS R703.7.5, R703.8, R003.2 AND R805.

#### 9, GARAGE NOTES

- 11 OPENIOS FROM GARAGE NTO LIVING SPACE OF RESIDENCE SHALL MEET THE REQUIREMENTS OF THE SECTION NUMBER.

  10 BE ROUMENED TO SECTION NUMBER.

  11 SEPARATION FOR DECLILIAR FROM THE ROUMENED SECTION NUMBER.

  12 FRANCISCO TO DECLILIAR FROM THE ROUMENED SHALL SECTION NUMBER.

  13 GARAGE, AND LIVING SPACE SERVANTION SHALL MEET THE REQUIREMENTS OF THE SECTION NUMBER.

  14 GARAGE TOOKS SHALL STATETY THE REQUIREMENTS OF FED FOR THIS OF THE SECTION NUMBER.

  15 LOADS AS DEEDED IN THOS FERMING NOW MON TONTES.

## 10. GENERAL CONNECTIONS NOTES

- 10.1 CONNECTIONS SHOWN ARE RECOMMENDED, BUT OTHER CONNECTIORS MAY BE SUBSTITUTED AS LONG AS THEY WEET OR EXCEPT UPINES AND ALL ATTUME. CANCHIT OF THE ARKNOWS SECTIONS MAY SETTLY THE ASSET OF THE ARKNOWS AND ALL AND

# 11, TRUSS TO FRAME CONNECTION NOTES

- 111 ROOT TRUSES USE SURFOUNT OR WHICH AT SECT TRUSS WHERE PROVIDE ACCIDING. TECHNICA FECUN SIZE WHERE PROVIDE ACCIDINAL TECHNICA FECUN SIZE ACCIDINAL TRUSS WHERE PLEASE SIZE ACCIDINATE SIZ

#### 12. EXTERIOR CEILING NOTES

12.1 ENTRY LANAICABANA CREINDS (AREAS EXPOSED TO WIND): PROVIDE 2XA BLOCKING AT 4T O. AT THE BOTTOM CHORD OF ALL TRUSSES. PROVIDE FUTERORS GRADE BRYWIALL OF § EXTERIOR GRADE PLYWOOD WITH 86 MAILS 5" O.C. PRIEDRY O.C. EDGES.

#### 13. WALL SECTION NOTES

- 13.1 INSTALLATION OF LATH SMALL MEET THE REQUIREMENTS OF SECTION RY03.7.1 OF THE FBC 7TH EDITION (2002) RESIDENTIAL.

  12.2 PLASTERING WITH PORTAINS CREMENT PLASTER MEET SMALL MEET THE REQUIREMENTS OF SECTION RY03.7.2 OF THE FBC 7TH EDITION (2020) RESIDENTIAL.
- RESIDENTIAL

  13.3 INSTALLATION OF WEEP SCREEDS SHALL MEET THE REQUIREMENTS OF SECTION R703.7.2.1 OF THE FBC 7TH EDITION (2020) RESIDENTIAL.

  13.4 INSTALLATION OF WATER RESIDENTS BARRIER SHALL MEET THE RECUIREMENTS OF SECTION R703.7.3 OF THE FBC 7TH EDITION (2020)
- 13.5 INSTALLATION OF FLASHING SHALL MEET THE REQUIREMENTS OF SECTION RYDA OF THE FBC 7TH EDITION (2020) RESIDENTIAL.

#### 14. WATER PROOFING NOTES

14.1 ALL WATER-PROOFING AND MOISTURE PROTECTION IS THE RESPONSIBILITY OF THE BUILDER.

#### TRUSS UPLIFT ANCHORS - MASONRY/CONCRETE

TRUSS ANCHORS TO MASONRY OR CONCRETE SHALL BE AS FOLLOWS
[REFER TO SMPSON 2020 CATALOS IS-2020]
OTHER REAMING FOR CONNECTIONS MAY ES RUSHITUTIED IF BOTH UPLET AND LATERAL LOAD CAPACITIES ARE EQUIAL OR GREATER THAN CONNECTIORS SPECIFIED

TYPE MEMBER	NOMINAL UPLIFT CAPACITY	CONNECTOR TYPE	NAILS TO TRUSS FOR NOMINAL UPLIFT	NOTES AND COMMENTS
SINGLE PLY, CMU 595#		SIMPSON HM9KT	(4) SDS ½'x1½' LONG TO TRUSS AND (5) ½'x2½' SIMPSON TITEN SCREW TO CMU	POST-INSTALLED
SINGLE PLY, CONCRETE	595#	SIMPSON HM9KT	(4) SDS ½x½ LONG TO TRUSS AND (5) ½x½ SIMPSON TITEN SCREW TO CMU	POST-INSTALLED
	1065#	SIMPSON H10S	(8) 8dx1∮* LONG TO TRUSS AND (2) ∯*x4* SIMPSON TITEN SCREW TO CMU	POST-INSTALLED
	1450#	SIMPSON META12	(7) 10dx12 LONG	
SINGLE PLY	1520#	SIMPSON HETA12	(7) 10dx1½" LONG	
	1810#	SIMPSON HETA16	(9) 10dx1½" LONG	
	1985#	(2) SIMPSON META12	(10) 10dx1½" LONG	NOTE 1
	2035#	(2) SIMPSON HETA12	(10) 10dx1 <sup>2</sup> LONG	NOTE 1
SINGLE OR MULTI PLY,	890s	SIMPSON MTSM16 EA TRUSS + SIMPSON HGAM AT 48°O.C.	(7) 10d TO TRUSS AND (4) (1/2)(1 SIMPSON TITEN SCREW TO CMU	POST-INSTALLED, MISSING EMBEDS.
CMU	1175#	SIMPSON HTSM16 EA TRUSS + SIMPSON HGAM AT 48°O.C.	(8) 10d TO TRUSS AND (4) (**\times\) SIMPSON TITEN SCREW TO CMU	POST-INSTALLED, MISSING EMBEDS.
	860#	SIMPSON MTSM16 EA TRUSS + SIMPSON HGAM AT 48°O.C.	(7) 10d TO TRUSS AND (4) (*x1)* SIMPSON TITEN SCREW TO CONCRETE	POST-INSTALLED, MISSING EMBEDS.
IGLE OR MULTI PLY, CONCRETE	1175#	SIMPSON HTSM16 EA TRUSS + SIMPSON HGAM AT 48'O.C.	(8) 10d TO TRUSS AND (4) (1/21) SIMPSON TITEN SCREW TO CONCRETE	POST-INSTALLED, MISSING EMBEDS.
SINGLE OR MULTI PLY	3330#	SIMPSON MGT	(22) 10dx1- LONG	NOTE 2
	2150#	SIMPSON LGT2	(16) 1Gd SINKERS	POST-INSTALLED, NOTE
DBL PLY	10980#	SIMPSON HGT-2	(16) 10d	NOTE 3
DBL OR TPL PLY.	1900#	(2) SIMPSON META12	(14) 16d	NOTE 1
CMU	2500#	(2) SIMPSON HETA12	(12) 16d	NOTE 1
	2565#	(2) SIMPSON META12	(14) 16d	NOTE 1
DBL OR TPL PLY, CONCRETE	2700#	(2) SIMPSON HETA12	(12) 18d	NOTE 1
	3350#	(2) SIMPSON HHETA12	(14) 16d	NOTE 1
TPL PLY	3285#	SIMPSON LGT3-SDS2.5	(12) SDS (1×2) LONG	POST-INSTALLED, NOTE
	10530#	SIMPSON HGT-3	(16) 10d	NOTE 3
QUAD PLY	9250#	SIMPSON HGT-4	(16) 10d	NOTE 3
	1450#	SIMPSON META12	(6) 16d	
MULTI PLY	1520#	SIMPSON HETA12	(7) 16d	
	1810#	SIMPSON HETA16	(8) 16d	

- NOTES:
  1. FOR (2) CONNECTORS: (4) THE NAILS SHALL NOT BE DRIVEN IN CONFLICT WITH EACH OTHER OR THE SECOND CONNECTOR, AND (8) STRAPS SHALL NOT OVERLAP THE 2ND CONNECTOR.
  - 2ND CONNECTOR.

    FASTENER TO CMUICONCRETE: (1) If ALL-THREAD BOLT W/ SIMPSON SET EPOXY-TIE ADHESIVE W/ 12" MIN. EMBED DEPTH
  - FASTENER TO CMUICONCRETE: (2) Y ALL-THREAD BOLT W/ SIMPSON SET EPOXY-TIE ADHESIVE W/ 12\* MIN. EMBED DEF
- FASTENER TO CMU WALL: (?) \*\*X\*\*\* LONG SIMPSON TITEN SCREW FASTENER TO CONCRETE WALL: (?) \*\*X\*\*\* SIMPSON TITEN SCREW FASTENER TO WALL: (4) \*\*X\*\*\* LONG SIMPSON TITEN HD

#### POST UPLIFT ANCHORS - MASONRY/CONCRETE

POST ANCHORS TO MASONRY OR CONCRETE SHALL BE AS FOLLOWS (REFER TO SIMPSON 2020 CATALOG #C-2020)

(RETER 10 30895UN 2023 CATALORS ID-2028)
OTHER BRANDS OF CONNECTORS MAY BE SUBSTITUTED IF BOTH UPLIFT AND LATERAL LOAD CAPACITIES ARE EQUAL OR GREATER THAN CONNECS
SPECIFIED

IINIMUM POST THICKNESS	NOMINAL UPLIET CAPACITY FOR	CONNECTOR	FASTENER TO POST FOR NOMINAL UPLIFT	ANCHOR BOLT DIAMETER
	SYP OR BTR	TYPE		
¥	1310#	SIMPSON LTT19	(8) 10dx1½" LONG NAILS	1.1 OR1
	1350#	SIMPSON LTTI31	(18) 10th/12" LONG NAILS	ř
	3610#	SIMPSON HTT4	(18) 10dx1½ LONG NAILS	8
	4350#	SIMPSON HTT5	(26) 10dx1∮* LONG NAILS	ŕ
	2405#	SIMPSON HD5	(2) TO DIAM STUD BOLTS	(r or ir
Ħ	3955#	SIMPSON HTT16	(18) 16dx2 <sup>3</sup> LONG NAILS	f
	4235#	SIMPSON HTT4	(18) 16dx2½* LONG NAILS	î
	5090#	SIMPSON HTT5	(26) 16dx2 <sup>3</sup> LONG NAILS	t
	3835#	SIMPSON HDS	(2) T DIAM STUD BOLTS	å oRå*
3*	4165#	SIMPSON HTT22	(32) 10d NAILS	i
	4670W	SIMPSON HTT5	(26) 10d NAILS	ê*
	6480W	SIMPSON HD5	(3) § DIAM STUD BOLTS	₹* OR 1*
эř	5010W	SIMPSON HD5	(2) <sup>3</sup> DIAM STUD BOLTS	ì
	6480#	SIMPSON HD7	(3) ₹ DIAM STUD BOLTS	₹ OR 1*
	10330#	SIMPSON HD9	(3) 1" DIAM STUD BOLTS	∦ OR 1*
	11350#	SIMPSON HD12	(4) 1" DIAM STUD BOLTS	1*


- 1 PNAMETER A307 ALL THREAD SET IN 2 DIAMETER HOLE W/SIMPSON SET EPOXY, MIN EMBED 5
- § DUMETER A307 ALL THREAD SET IN § DUMETER HOLE W SIMPSON SET EPOXY, MIN EMBED 8\*

  § DUMETER A307 ALL THREAD SET IN § DUMETER HOLE W SIMPSON SET OR EQUAL, MIN EMBED 6\*

  1\* DUMETER A307 ALL THREAD SET IN § DUMETER HOLE W SIMPSON SET OR EQUAL, MIN EMBED 6\*

  1\* DUMETER A307 ALL THREAD SET IN § DUMETER HOLE W SIMPSON SET OR EQUAL, MIN EMBED 9\*

MULTIPLE ME	EMBER CONNECT BE	IONS FOR 1.9E AMS	MICROLLAM	LVL
			→ -	-
2 TW.		•	+ +	-
<ul> <li>MEMBERS LES</li> <li>MINIMUM (3) R</li> </ul>	OWS OF 12d NAILS AT IS THAN 14" DEEP OWS OF 12d NAILS AT EATER THAN 14" DEEP	12" O.C. FOR		
<ul> <li>(2) ROWS OF ½</li> </ul>	2d NAILS AT 12" O.C.; I BOLTS AT 12" O.C.; O " X 3}" LAG SCREWS A	R		
	BOLTS AT 12" O.C.; O			
MAXIMUM.  SCREWS MUS STRENGTH OF 6" LONG SCRE	WITH WASHERS REQUI T HAVE SELF-DRILLING 217,000PSI. WAS REQUIRED. INSTRUCTIONS ON PL	G TIP AND MINIMUM	BENDING YIELD	

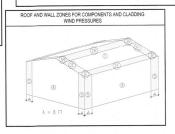

ZONE	DESCRIPTION	TRIBUTARY AREA (SQ. FT.)	POSITIVE (+ PSF)	NEGATIVE (+ PSF)
1	ROOF - INTERIOR ZONE	LESS THAN 20	30.0	57.6
		20 - 100	20.6	48.6
		GREATER THAN 100	16.6	42.2
	OVERHANG	LESS THAN 20		
28	ROOF - INTERIOR EDGE ZONE	LESS THAN 20	30.0	74.5
		20 - 100	20.6	56.1
	EDOL EONE	GREATER THAN 100	16.6	48.1
	OVERHANG	LESS THAN 20		
2n, 2r 3e	ROOF - INTERIOR	LESS THAN 20	30.0	91.5
	END, RIDGE ZONES CORNER ZONES	20 - 100	20.6	66.6
		GREATER THAN 100	16.6	53.8
	OVERHANG	LESS THAN 20		
3r RO	ROOF - END RIDGE ZONE	LESS THAN 20	24.4	118.0
		20 - 100	18.7	67.6
		GREATER THAN 100	16.6	67.6
	OVERHANG	LESS THAN 20		
4		LESS THAN 20	40.3	38.0
	WALL, INTERIOR ZONE	20 - 100	36.0	34.5
		GREATER THAN 100	34.2	32.9
5	WALL, CORNER ZONE	LESS THAN 20	40.3	47
		20 - 100	36.0	39.7
		GREATER THAN 100	34.2	36.5

WIND LOAD SCHEDULE

TO THE BEST OF MY KNOWLEDGE, THE PLANS AND SPECIFICATIONS FOR THIS RESIDENCE COMPLY WITH THE APPLICABLE STRUCTURAL PROVISIONS OF THE 2020 EDITION OF THE FLORIDA BUILDING CODE, RESIDENTIAL (FBC-R), 7TH

RECEIVED

APR 0.8 2022

TOWN OF LONGBOAT KEY
Planning, Zoning & Bullsing

REVISIONS BY DATE JP 08 24 2021

YOUNG RHEDRICK

S4.0

A Custom Home for:

• DARLEEN LeBARON

LANE LONGBOAT KEY, FL 34228


JIM &


NOTES/SPECS

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STRUCTURAL 1
3/16" =

501




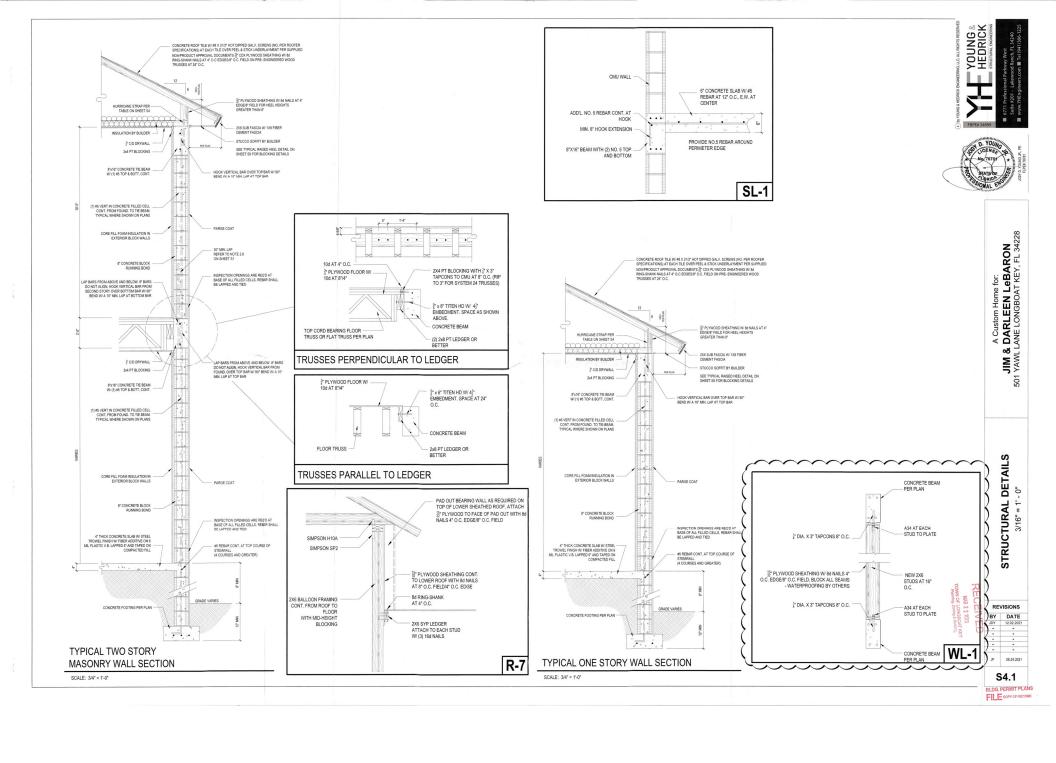

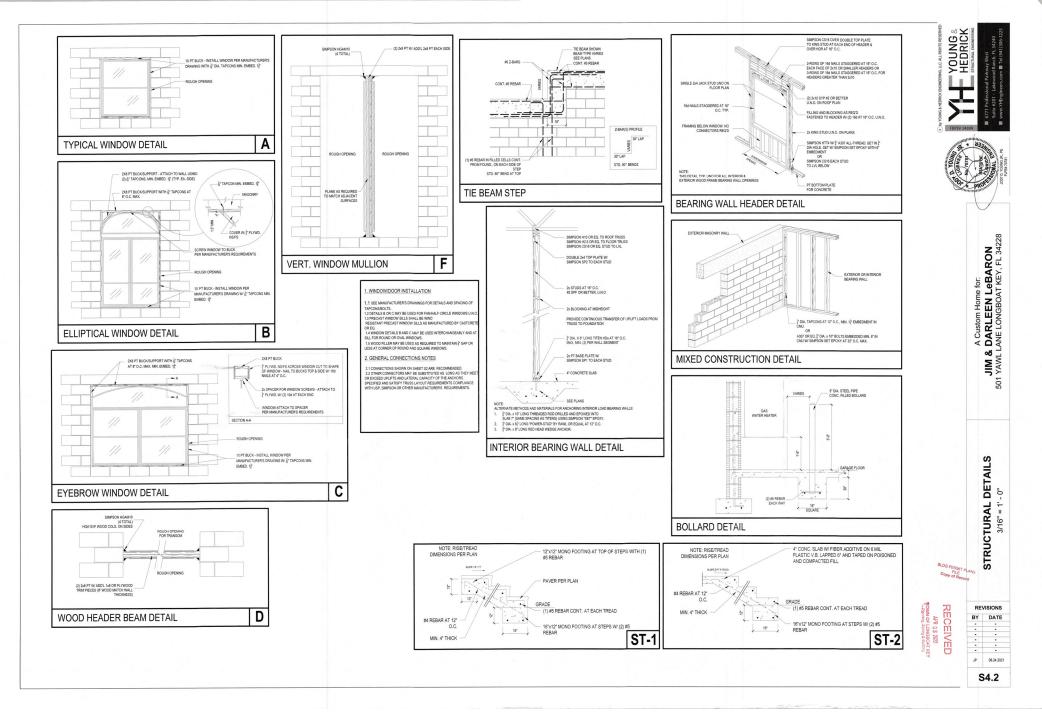

S4.3



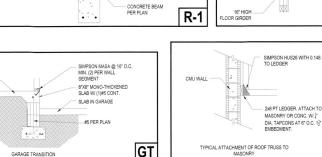

8d RING-SHANK AT 4" O.C.

ATTACH TO EA VERT. W/ (3) 16d NAILS

19° PLYWOOD


ROOF TRUSSES


HANGER PER TRUSS MANF


SIMPSON MASA


SHEATHING 8d RING-SHANK AT 4" EDGE/8" FIELD


2X6 SYP LEDGER

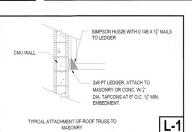

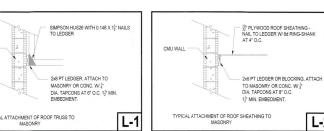

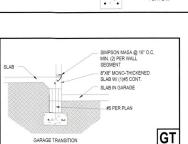

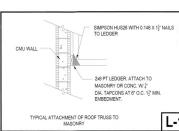

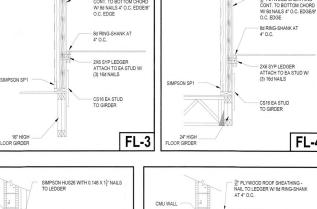



5 PLYWOOD SHEATHING CONT. TO BOTTOM CHORD

W/ 8d NAILS 4" O.C. EDGE/8

SIMPSON H10A

SIMPSON SP2

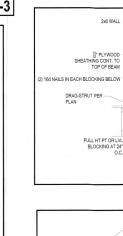

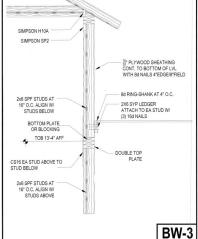

2v4 PT BLOCKING

₽ PLYWOOD SHEATHING CONT. TO LOWER ROOF,

ATTACH WITH 8d NAILS AT

4" O.C. EDGE/8" O.C. FIELD

SIMPSON HTS16

TO BELOW EA. SIDE

BW-2

2x4 SYP BLOCKING NOTE: BLOCKING IS NOT REQ'D FOR RAISED HEELS LESS THAN 18"

SIMPSON HTS10A

2v4 SPF STUDS AT


16" O.C. ALIGN W/ STUDS BELOW 2X BLOCKING


DOUBLE TOP


2v4 SDE STUDS AT 16" O.C. ALIGN W/ STUDS ABOVE

PLATE

SIMPSON SP2

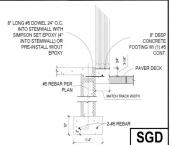


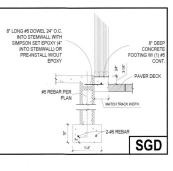

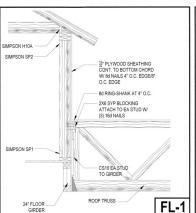

IMPSON H10A

SIMPSON SP2

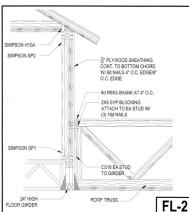

§\* PLYWOOD SHEATHING


FL-4





YOUNG MHEDRICK



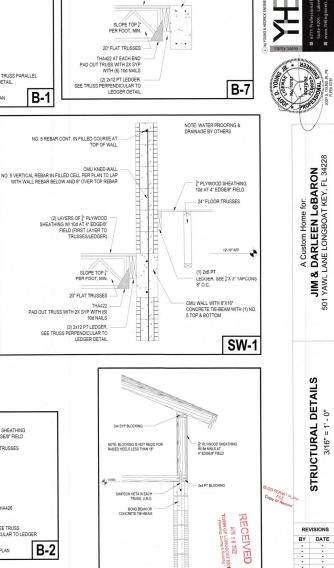

TYPICAL RAISED HEEL DETAIL

JP 08.24.2021 **S4.4** 

(2) LAYERS OF 3" PLYWOOD SHEATHING W/ 10d AT 4" EDGE/8" FIELD (FIRST LAYER TO

TRUSSES/LEDGER)

PLYWOOD SHEATHING 10d AT 4" EDGE/8" FIELD

(1) 2x8 PT

BEAM PER PLAN

B-8

BM-1

TOP REBAR STD. 90° BEND

LEDGER SEE TRUSS PARALLEL


**B-1** 


TO LEDGER DETAIL.

REAM PER PLAN

YOUNG R HEDRICK

BEAM PER PLAN

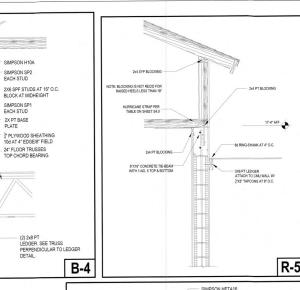

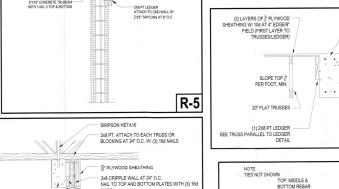

2x6 CONT. AT UPPER TRACK W/ 16d

(2) LAYERS OF <sup>3+</sup><sub>4</sub> PLYWOOD SHEATHING W/ 10d AT 4\* EDGE/8\*

THA422 PAD OUT TRUSS WITH 2X SYP WITH

SEE TRUSS PERPENDICULAR TO

FIELD (FIRST LAYER TO

TRUSSES/LEDGER)


SLOPE TOP 1\* PER FOOT, MIN.

20" FLAT TRUSSES


(2) 2x12 PT LEDGER.


LEDGER DETAIL


EXTEND TO ENDS

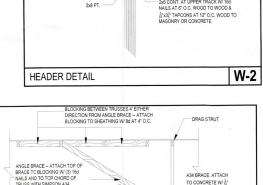


CONCRETE BEAM PER PLAN

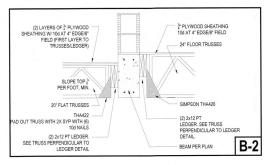

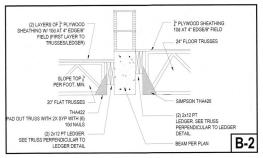

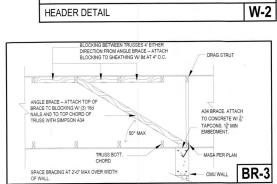

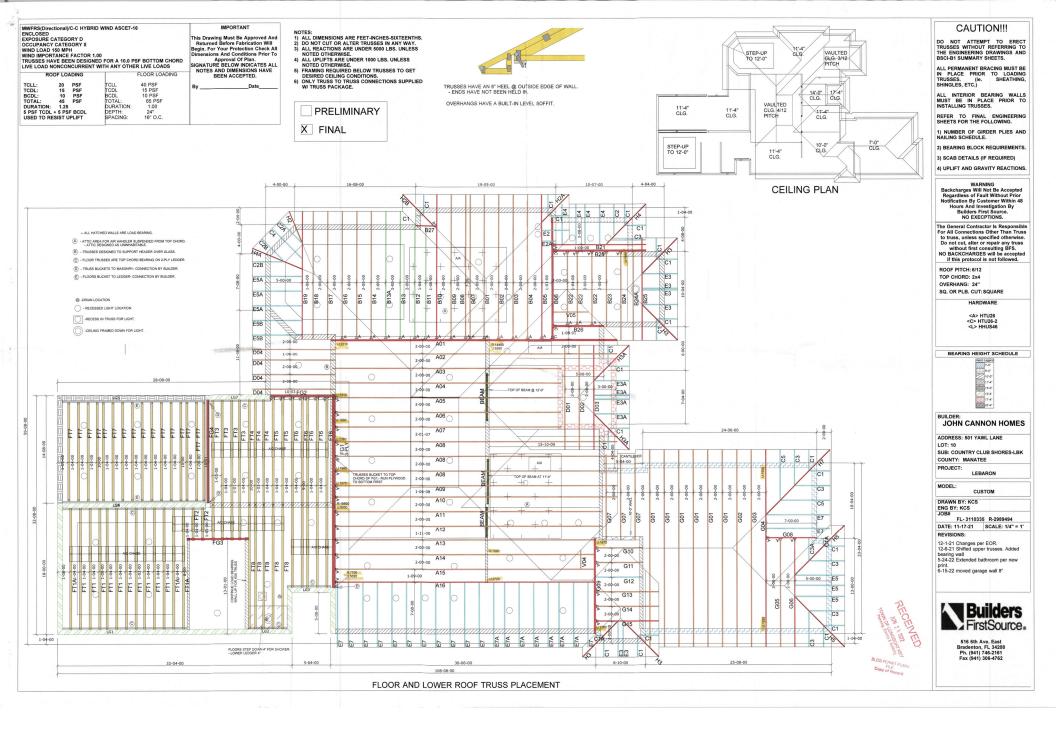

IMFRS(Directional)/C-C HYBRI INCLOSED IXPOSURE CATEGORY D IXPOSURE CATEGORY II IVIND LOAD 150 MPH IVIND IMPORTANCE FACTOR 1 RUSSES HAVE BEEN DESIGN IVE LOAD NONCONCURRENT	This Drawing Must Be Approved And Returned Before Fabrication Will Begin. For Your Protection Check All Dimensions And Conditions Prior To Japproval Of Plan. SIGNATURE BELOW INDICATES ALL NOTES AND DIMENSIONS HAVE			
ROOF LOADING	FLOOR LOADING	BEEN ACCEPTED.		
TCLL: 20 PSF TCDL: 15 PSF BCDL: 10 PSF TOTAL: 45 PSF DURATION: 1.25 5 PSF TCDL +5 PSF BCDL USED TO RESIST UPLIFT	TCLL 40 PSF TCDL 15 PSF BCDL 10 PSF TOTAL: 65 PSF DURATION: 1.00 DEPTH: 24" SPACING: 16" O.C.	ByDate		

C1 C3

C5

C5

- RECESS IN TRUSS FOR LIGHT - CEILING FRAMED DOWN FOR LIGHT.

NOTES:

1) ALL DIMENSIONS ARE FEET-INCHES-SIXTEENTHS.
2) DO NOT CUT OR ALTER TRUSSES IN ANY WAY.
3) ALL REACTIONS ARE UNDER 5000 LBS. UNLESS NOTEO OTHERWISE.
4) ALL UPLIFTS ARE UNDER 1000 LBS. UNLESS NOTEO OTHERWISE.
50 ESIFED CELLING CONDITIONS.
50 ONLY TRUSS TO TRUSS CONNECTIONS SUPPLIED W/ TRUSS PACKAGE.



TRUSSES HAVE AN 8" HEEL @ OUTSIDE EDGE OF WALL. - ENDS HAVE NOT BEEN HELD IN.

OVERHANGS HAVE A BUILT-IN LEVEL SOFFIT.

C5

6-00-00



2-00-00

2-00-00

1-08-00

1-00-08

1-01-00

2-00-00

UPPER ROOF TRUSS PLACEMENT

K04A

K03A

K02


K01


K01 KU3

K04

32-04-00

5 8 8 8 8 8 8 8 8 8 8 8 8 8 8 8

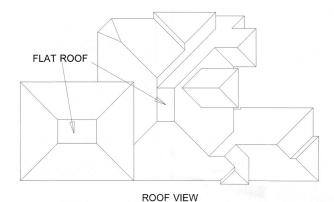

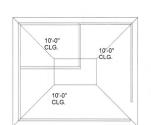

**CEILING PLAN** 

# CAUTION!!!

DO NOT ATTEMPT TO ERECT TRUSSES WITHOUT REFERRING TO THE ENGINEERING DRAWINGS AND BSCI-B1 SUMMARY SHEETS.

ALL PERMANENT BRACING MUST BE IN PLACE PRIOR TO LOADING TRUSSES. (ie. SHEATHING, SHINGLES, ETC.)

ALL INTERIOR BEARING WALLS MUST BE IN PLACE PRIOR TO INSTALLING TRUSSES.

1) NUMBER OF GIRDER PLIES AND NAILING SCHEDULE.

2) BEARING BLOCK REQUIREMENTS

3) SCAB DETAILS (IF REQUIRED)

4) UPLIFT AND GRAVITY REACTIONS.

WARNING
Backcharges Will Not Be Accepted
Regardless of Fault Without Prior
Notification By Customer Within 48
Hours And Investigation By
Builders First Source.
NO EXECPTIONS.

The General Contractor is Responsible For All Connections Other Than Truss to truss, unless specified otherwise. Do not cut, after or repair any truss without first consulting BFS. NO BACKCHARGES will be accepted if this protocol is not followed.

ROOF PITCH: 6/12 TOP CHORD: 2x4 OVERHANG: 24"

SQ. OR PLB. CUT: SQUARE

HARDWARE

<A> HTU26 <C> HTU26-2 <L> HHUS46

BEARING HEIGHT SCHEDULE



# JOHN CANNON HOMES

ADDRESS: 501 YAWL LANE LOT: 10 SUB: COUNTRY CLUB SHORES-LBK

COUNTY: MANATEE PROJECT:

LEBARON

MODEL:

сиѕтом DRAWN BY: KCS

DATE: 11-17-21 SCALE: 1/4" = 1' REVISIONS:

12-1-21 Changes per EOR. 12-6-21 Shifted upper trusses. Added bearing wall. 5-24-22 Extended bathroom. 6-15-22 moved garage wall 8"



Bradenton, FL 34208 Ph. (941) 746-2161 Fax (941) 306-4762