

	WII	NDOW S	CHEDUL	.E		
TYPE MARK	LEVEL	TYPE	HEAD HEIGHT	SILL	WIDTH	HEIGH'
W100	STORAGE/DECK - T.O SLAB	FIXED	8'-0"	FFL	60.	8'-0"
W101	STORAGE/DECK - T.O SLAB	FIXED	80.	FFL	2'-6"	80.
TOTAL:	2	•				

VERIFY ALL DOOR AND WINDOW SIZES / REQUIRED ROUGH OPENINGS W/MANUFACTURER AND STRUCTURAL DESIGN AND SPECIFICATIONS.

### CCCL STRUCTURE NOTES:

STRUCTURES SEAWARD OF THE COASTAL CONSTRUCTION CONTROL LINE SHALL BE DESIGNED TO RESIST THE PREDICTED FORCES OF A 100-YEAR STORM EVENT IN ACCORDANCE WITH SECTION R3109 OF FBC 2020 - 7TH EDITION RESIDENTIAL - R322.2.2




### **ELEVATOR NOTE:**

ALL ELEVATOR COMPONENTS SHALL BE CONSTRUCTED OF FLOOD

DAMAGE-RESISTANT MATERIALS AND DESIGNED TO RESIST PHYSICAL DAMAGE

DURING FLOODING; AND IF ELEVATOR CABS DESIGNED TO ACCESS TO AREAS BELOW DFE, IT MUST BE EQUIPPED W/ CONTROLS THAT PREVENT THE CAB FROM DESCENDING INTO FLOODWATERS. (PER FEMA TB-4, FBC 2020 - 7TH EDITION • RESIDENTIAL • R322.1.6)

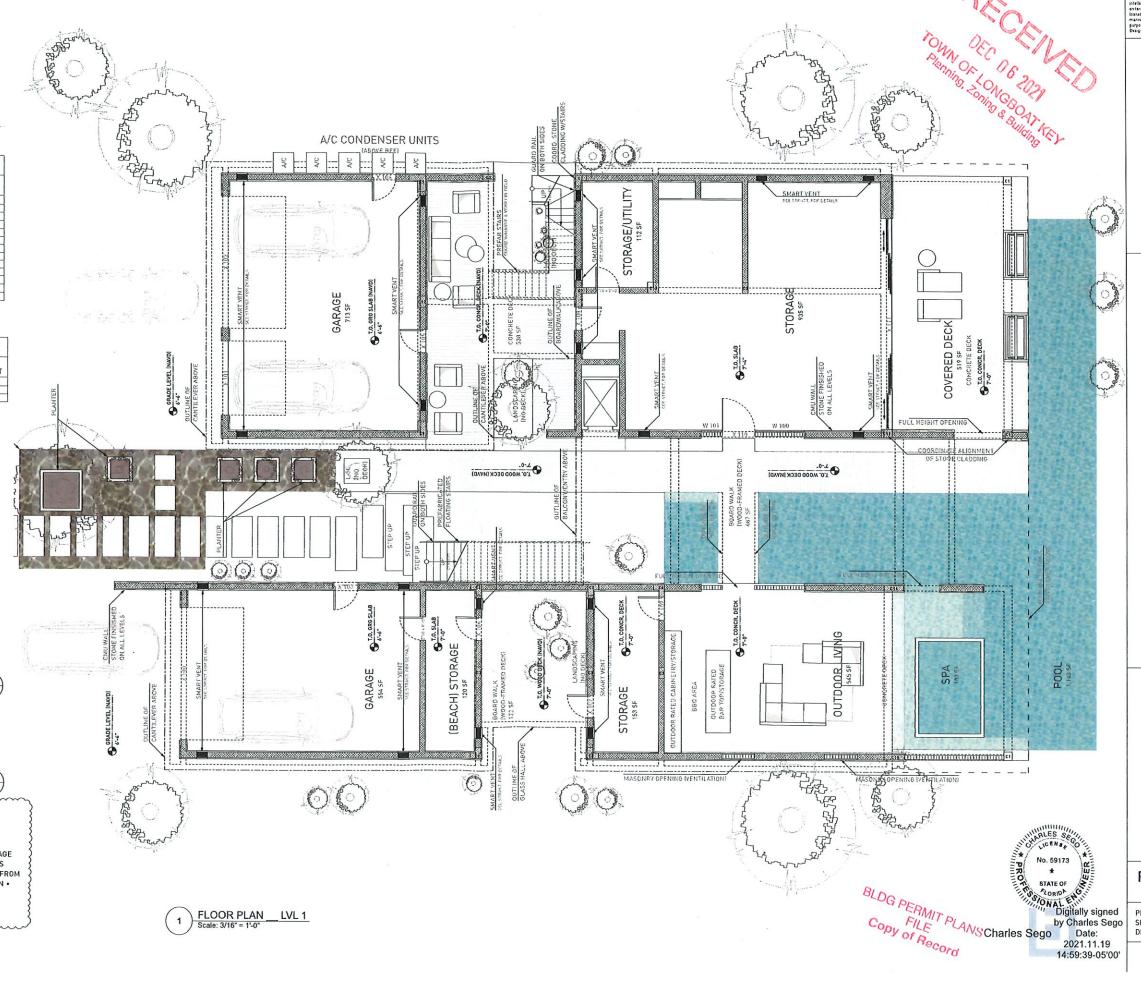

DesignMarket

RTIN MASON MA

Date BUIDLING DEP. C ė 6


5861 GULF OF MEXICO DR LONGBOAT KEY, FL 34228


## **FLOOR PLAN NOTES**

PROJECT #: 2020/17 SHEET DATE: 11/18/21 DRAWN BY: MV

14:59:39-05'00'


A 2.1

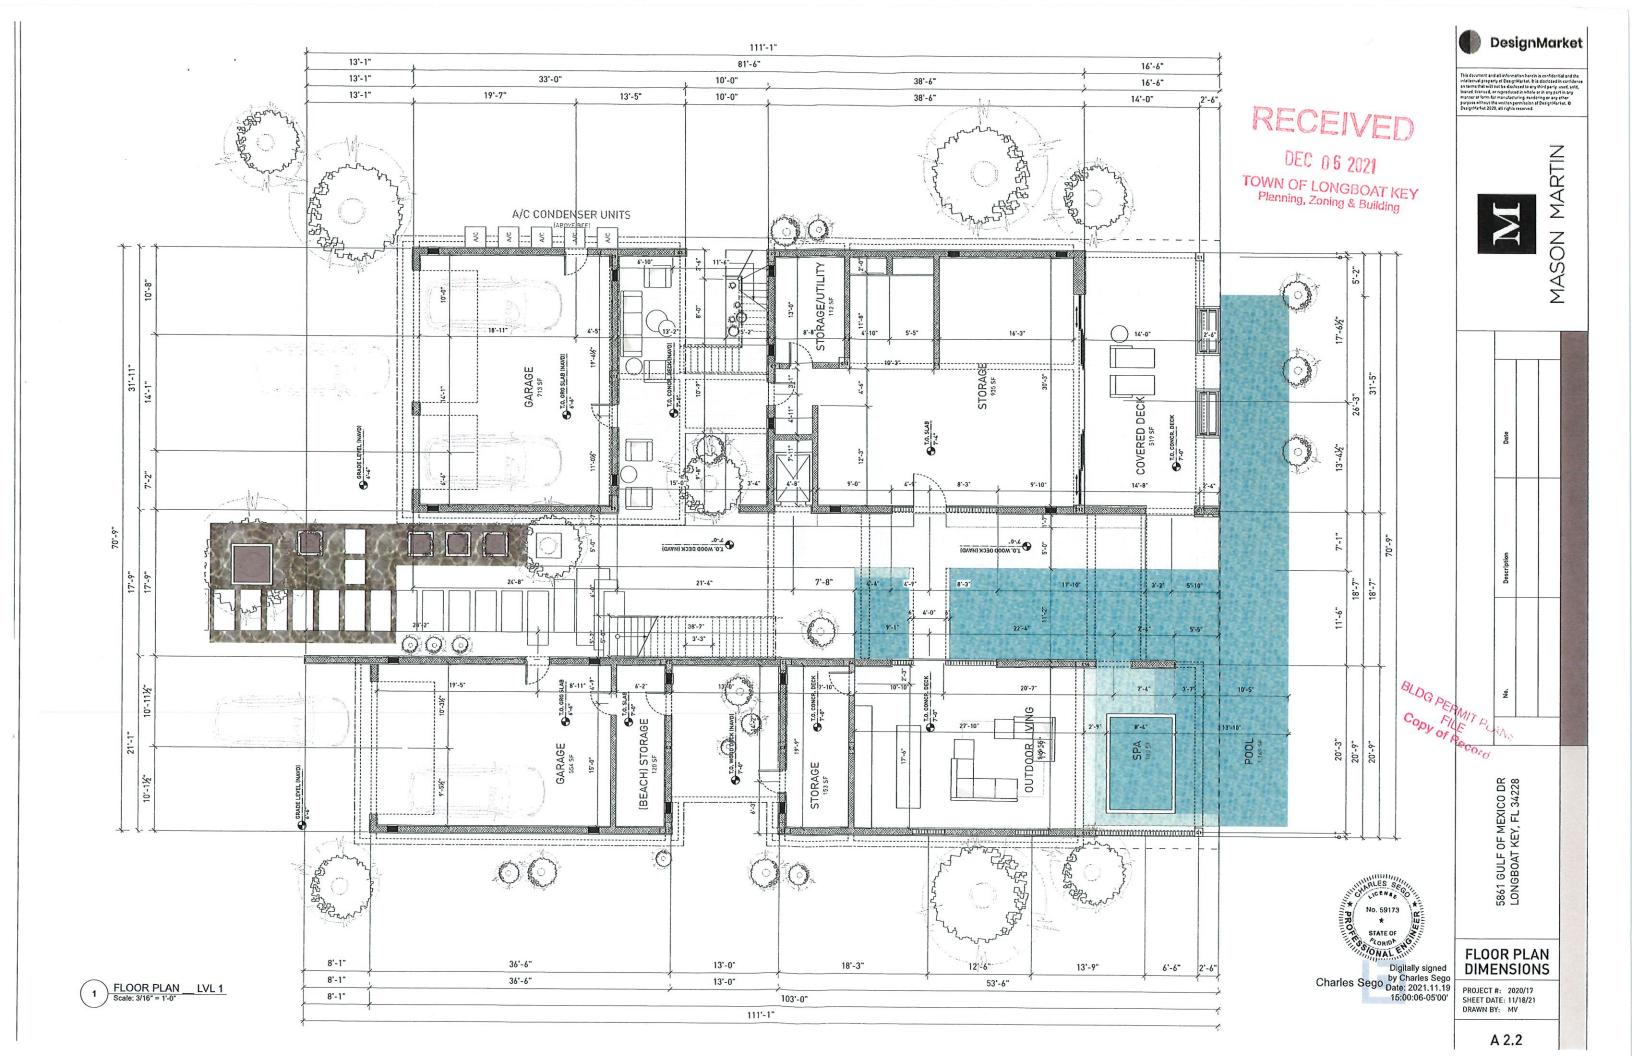

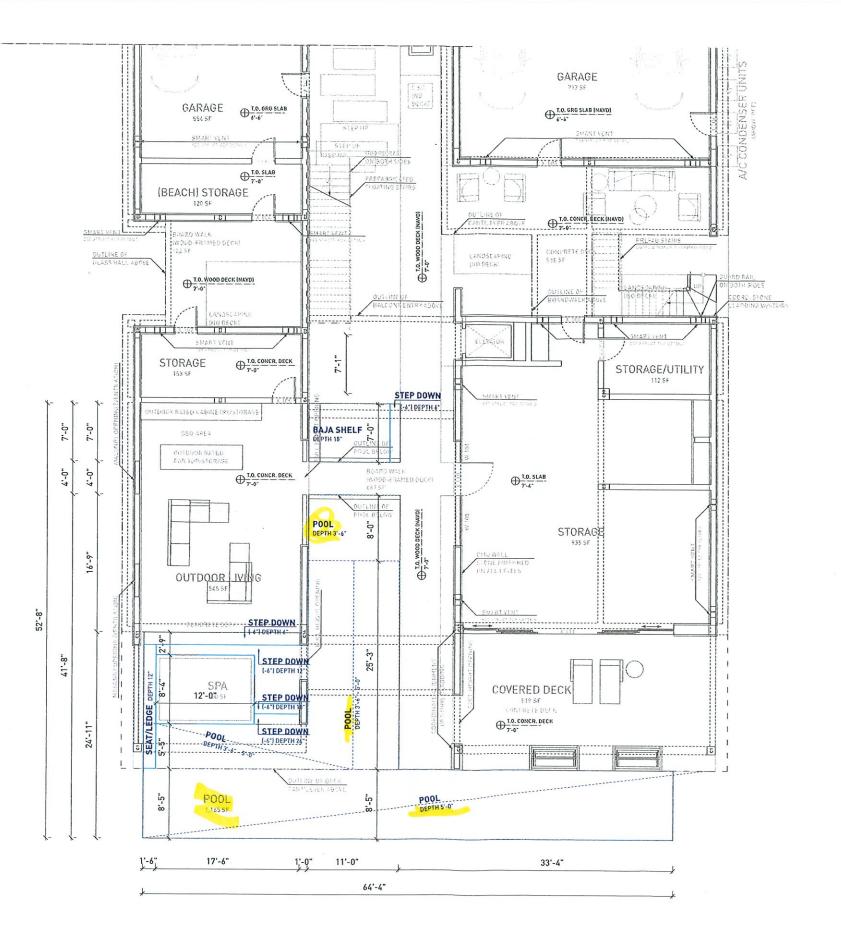

DesignMarket

MASON MARTIN

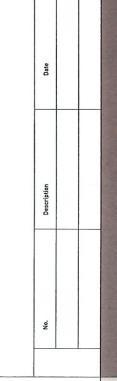

RECEIVED
DEC 06 2021

TOWN OF LONGBOAT KEY
Planning, Zoning & Building

No. 59173

STATE OF

Control

Charles Sego

Date: 2021.11.19

15:03:04-05:001 15:03:04-05'00'

5861 GULF OF MEXICO DR LONGBOAT KEY, FL 34228

**POOL PLAN** 

PROJECT #: 2020/17 SHEET DATE: 11/18/21

A 4.0

POOL LVL 1 Scale: 3/16" = 1'-0"

### **GENERAL NOTES:**

ALL POOLS, AND SPAS SHALL CONFORM WITH THE 2017 FLORIDA BUILDING CODE, THE 2017 FLORIDA STATUTES, CHAPTER 515 RESIDENTIAL SWIMMING POOL SAFETY ACT, THE 'VIRGINIA GRAEME BACKER POOL & SPA SAFETY ACT' ALONG WITH ALL APPLICABLE COUNTY OR CITY CODES AND ORDINANCES.

ALL SUCTION OUTLETS SHALL BE PROVIDED WITH A COVER THAT HAS BEEN TESTED AND ACCEPTED BY A RECOGNIZED TESTING FACILITY AND COMPLYING WITH ANSI/ASME A112.19.8 PERFORMANCE STANDARD.

ALL POOLS AND SPAS SHALL BE REQUIRED TO HAVE A BACKUP SYSTEM WHICH SHALL PROVIDE VACUUM RELIEF SHOULD THE GRATE COVERS BE MISSING. ALTERNATE VACUUM DEVICES INCLUDE:

APPROVED VENT PIPING.

APPROVED VACUUM RELEASE SYSTEM.

OTHER APPROVED MEANS OR DEVICES.

ALL POOL PIPING SHALL BE TESTED AND PROVED TIGHT TO THE SATISFACTION OF THE ADMINISTRATIVE AUTHORITY, UNDER A STATIC WATER OR PRESSURE TEST OF NOT LESS THAN 35 PSI FOR 15 MIN.

OUTDOOR SWIMMING POOLS SHALL BE PROVIDED WITH A BARRIER COMPLYING WITH THE 2017 FLORIDA STATUTES CHAPTER 515, RESIDENTIAL POOL AND SAFETY ACT, AND SECTION R4101.17 OF THE 2017 RESIDENTIAL FLORIDA

APPROVED MANUFACTURED INLET FITTINGS FOR THE RETURN OF RECIRCULATING POOL WATER SHALL BE PROVIDED ON THE BASIS OF AT LEAST ONE PER 300 SOLIARE FEET OF SURFACE AREA AND ONE FOR EVERY 20 GPM OF THE RECIRCULATED RATE, SUCH INLET FITTINGS SHALL BE DESIGNED AND CONSTRUCTED TO INSURE THE ADEQUATE SEAL TO THE POOL STRUCTURE AND SHALL INCORPORATE A CONVENIENT MEANS OF SEALING FOR PRESSURE TESTING OF THE PIPING. WHERE MORE THAN ONE INLET IS REQUIRED, THE SHORTEST DISTANCE BETWEEN ANY TWO REQUIRED INLETS SHALL BE AT

ALL MATERIALS, PIPING, VALVES, EQUIPMENT OR APPLIANCES ENTERING INTO THE CONSTRUCTION OF SWIMMING POOLS OR PORTIONS THEREOF SHALL BE A TYPE COMPLYING WITH THE BUILDING CODE OR OF A TYPE RECOMENDED AND APPROVED BY A NATIONALLY RECOGNIZED TESTING AGENCY OR CONFROMING TO OTHER RECOGNIZED STANDARDS ACCEPTABLE TO THE ADMINASTRATIVE

ALL DIMENSIONS SHOWN FOR THE NEW POOL ARE TO THE EXTERIOR OF THE POOL CONSTRUCTION

CONTRACTOR SHALL OBTAIN AND COMPLY WITH APPROVED C.C.C.L. PERMIT FINAL ORDER FROM THE F.D.E.P. FOR SWIMMING POOL CONSTRUCTION. AS

NO VEGETATION IS EXISTING IN THE AREA OF THE PROPOSED SWIMMING POOL THIS CONSTRUCTION WILL NOT RESULT IN THE LOSS OF STABILIZING NATIVE

FILL FROM POOL EXCAVATION TO BE USED FOR THE PAVER DECK AND PAVER DRIVEWAY OR BE RELOCATED ON NEARBY PROPERTY SEAWARD OF THE COASTAL CONSTRUCTION CONTROL LINE.

### **CONSTRUCTION NOTES:**

ALL SUCTION OUTLET COVERS SHALL BE COMPLIANT WITH ASME/ANSI A112.19-2007. IF DUAL MAIN DRAINS ARE USED EA. DRAIN COVER SHALL BE RATED FOR 100% OF THE SYSTEM FLOW RATE. IF UN-BLOCKABLE CHANNEL DRAINS ARE USED THE MANUFACTURERS LISTED SUMP MUST BE USED.

ALL POOL PIPING SHALL BE SCH. 40 PVC WITH NSF APPROVED STAMP FOR

ALL REINFORCING STEEL SHALL BE GRADE 60 DEFORMED BARS. SPLICE LOCATIONS SHALL BE STAGGERED WITH BARS LAPPED 15" MINIMUM.

ALL ELECTRICAL WIRING AND EQUIPMENT SHALL COMPLY WITH CHAPTER 27 OF THE FBC 2017 AND NFPA 70 2014, ARTICLE 680 (N.E.C.). PROVIDE BONDING OF ALL EQUIPMENT, HANDRAILS AND LIGHTS TO POOL REINFORCING.

### **ADDITIONAL NOTES**

POOL INSTALLATION SHALL BE BY A QUALIFIED AND LICENSED (APPROVED BY LOCAL BUILDING DEPARTMENT) POOL CONTRACTOR, THE INSTALLATION SHALL CONFORM TO A LOCAL BUILDING CODES, ie, PERMITS SPECIFICATIONS, CODES, RULES, RULES, INSPECTION, WORKMANSHIP, ETC.

STEPS OR A LADDER SHALL BE PROVIDED AT THE SHALLOW END OF THE POOL.

FINAL ELECTRICAL AND BARRIER CODE INSPECTIONS SHALL BE COMPLETED PRIOR TO FILLING THE POOL WITH WATER.

### **ELECTRICAL REQUIREMENTS:**

INSTALL LOW VOLTAGE LIGHT AS PER NEC 680.

WIRING AND BONDING AND ALL ELECTRICAL TO COMPLY WITH CHAPTER 27, FLORIDA BUILDING CODE FBC 2017.

NO OUTLET OR OVERHEAD POWER WITHIN 10' IF WITHIN 15' PROTECT BY GFI, TRANSFORMER MIN. 10' FROM POOL, 8" ABOVE WATER, J BOX 4' FROM POOL, BRASS TO J BOX OR TRANSFORMER WHICH EVER IS FIRST EXCEPT WHERE PVC

AN EQUIPOTENTIAL BONDING GRID MUST COVER THE CONTOUR OF THE PERMINATELY INSTALLED POOL AND SPA UNDER THE DECK. AN UNDERGROUND BONDING CONDUCTOR MADE OF A SINGLE #8 AWG BARE COPPER WIRE BURIED TO A MINIMUM DEPTH OF 4 TO 6 INCHES BELOW SUBGRADE, AND 18 TO 24 INCHES FROM THE INSIDE OF THE WALL OF A SWIMMING POOL OR SPA, AND BONDED TO THE POOL STEEL WITH #8 AWG BARE COPPER WIRE AT FOUR EQUAL PLACES ALONG THE PERIMETER OF THE POOL. FOR POOL WATER

ALL PUMPS AND ALL METALLIC PARTS WITHIN 5 FEET OF POOL MUST BE GROUNDED TO THE POOL STEEL WITH #8 COPPER GROUND WIRE.

TIME CLOCKS SHALL BE INSTALLED ON PRIVATE POOLS SO THAT THE PUMP CAN BE SET TO RUN DURING OFF-PEAK ELECTRICAL DEMAND PERIODS AND CAN BE SET FOR THE MAXIMUM TIME NECESSARY TO MAINTAIN THE WATER IN A CLEAR AND SANITARY CONDITION IN KEEPING WITH APPLICABLE HEALTH STANDARDS

ALL POOL AND SPA HEATERS SHALL BE EQUIPPED WITH AN ON/OFF SWITCH MOUNTED FOR EASY ACCESS TO ALLOW THE HEATERS TO BE SHUT OFF WITHOUT ADJUSTING THE THERMOSTAT SETTING, AND TO ALLOW RESTARTING WITHOUT RELIGHTING THE PILOT LIGHT

	LIGHTIN	G SCHEDI	II C	Aller to the second
	LIGITIIN	G SCITED	JLL	
FIXTURE	QUANTITY	BULB TYPE & LUMENS	MOUNT	MOUNTING HEIGHT
PENTAIR AMERILITE, #78438100, 300 WATT, 12 VOLT UNDERWATER LIGHT, WITH STAINLESS STEEL RIM	1	300 WATT, 12 VOLT, INCANDESCENT FLOODLAMP (5,000 LUMENS)	PENTAIR LARGE STAINLESS STEEL NICHE FOR FIBERGLASS INSTALLATION	18" MINIMUM BELOW POOL WATER LEVER

INTERIOR SWIMMING POOL LIGHTS SHALL BE TURNED OFF WHILE THE POOL IS NOT IN USE DURING SEA TURTLE NESTING SEASON (MAY 1 THROUGH OCTOBER 31). THE USE OF AN AUTOMATIC TIMER IS ACCEPTABLE.

DIRECT OR INDIRECT CONNECTIONS SHALL NOT BE MADE BETWEEN ANY STORM DRAIN, SEWER, DRAINAGE SYSTEM, SEEPAGE PIT, UNDERGROUND LEECHING PIT, OR SUBSOIL DRAINAGE LINE, AND ANY LINE CONNECTED TO THE SWIMMING POOL, UNLESS APPROVED BY THE ADMINISTRATIVE AUTHORITY

THE ENGINEER SHALL NOT BE HELD LIABLE FOR:

- FAULTY MATERIALS AND CONSTRUCTION
- INADEQUATE OR IMPROPER SUPERVISION OF CONSTRUCTION
- IMPROPER POOL MAINTENANCE AFTER CONSTRUCTION.


#### PIPE FLOW AT GIVEN VELOCITY (GPM) PIPE 6 FPS 8 FPS 10 FPS 16 22 27 38 51 1.5" 64 63 84 105 2.5" 90 119 149 138 184 230 238 317 397

720

900

540

6"

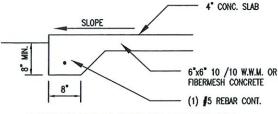


- · IF FIBERMESH CONCRETE IS USED FOR POOL DECK THEN A DECK TOPPING IS REQUIRED
- ALL REINFORCING STEEL TO COMPLY WITH ASTM 615 GRADE 40
- FOOTER SIZE MAY VARY FOR SCREEN ENCLOSURES

## DECK FOOTER DETAIL

NOT TO SCALE




Digitally signed by Derek W Newcomer DN: c=US, o=APEX CONSULTING ENGINEERS, ou=A01410C0000016FEC C0651C0000D155, cn=Derek W Newcomer Date: 2021.10.22 14:47:06 -04'00'

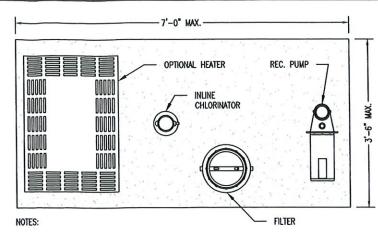


- CONCRETE PAD TO BE 4" THICK (2,500 PSI MIN.)
  POOL EQUIPMENT SHALL NOT BE WITHIN A 4 FOOT RADIUS OF POOL BARRIER FENCE TOP.
- ALL EQUIPMENT SHALL COMPLY WITH ANSI/NSF 50.
- HEATER SHALL HAVE A READILY ACCESSIBLE ON-OFF SWITCH, MOUNTED ON THE OUTSIDE AND CAN BE USED WITHOUT CHANGING THE THERMOSTAT SETTING.

### TYPICAL FILTER LAYOUT

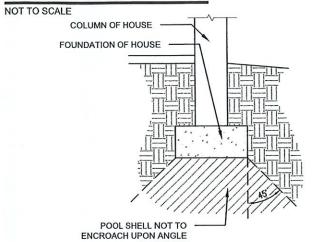


# ANGLE OF REPOSE DETAIL

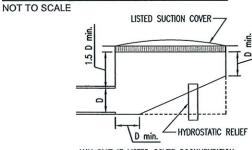


MAY OMIT IF LISTED COVER DOCUMENTATION SPECIFICALLY STATES NO CLEARANCE TO SUCTION PIPE REQUIRED


FIELD BUILD SUMPS MEETING THESE CRITERIA REQUIRED WHEN MANUFACTURED

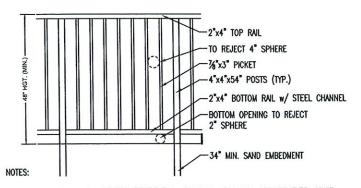


- COVERS USED TO SATISFY RESIDENTIAL SWIMMING BARRIER REQUIREMENTS MUST COMPLY WITH ASTM F 1346
- THE OUTSIDE BARRIER SHALL NOT CONTAIN ANY PROTRUSIONS, HAND AND FOOTHOLDS OR ANY OTHER DISTINGUISHING FEATURE TO ALLOW OR AID IN CLIMBING.
- ACCESS GATES SHALL BE SELF CLOSING AND EQUIPPED WITH A SELF LATCHING LOCKING DEVICE AT A HEIGHT OF MINIMUM 54'
- ACCESS GATE SHALL OPEN OUTWARD AWAY FROM POOL
- ALL FIRST FLOOR DOORS AND WINDOWS LESS THAN 48" ABOVE FINISHED FLOOR PROVIDING DIRECT ACCESS TO THE POOL FROM HOME SHALL BE EQUIPPED WITH AN EXIT ALARM

## TYPICAL BARRIER DETAIL

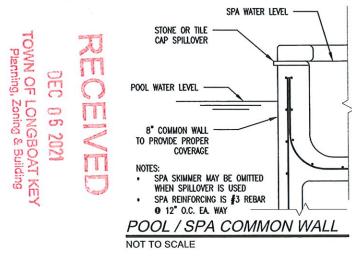

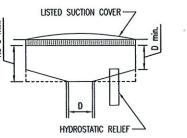

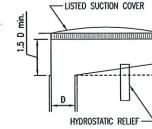


FIELD BUILT SUMP DETAILS


Copy of Record

THIS ITEM HAS BEEN ELECTRONICALLY SIGNED AND SEALED BY DEREK NEWCOMER, PE USING A SHA-1 AUTHENTICATION CODE FOR STRUCTURAL COMPONENTS ONLY. PRINTED COPIES OF THIS DOCUMENT ARE NOT CONSIDERED SIGNED AND SEALED AND THE SHA-1 AUTHENTICATION CODE MUST BE VERIFIED ON ANY ELECTRONIC COPY.





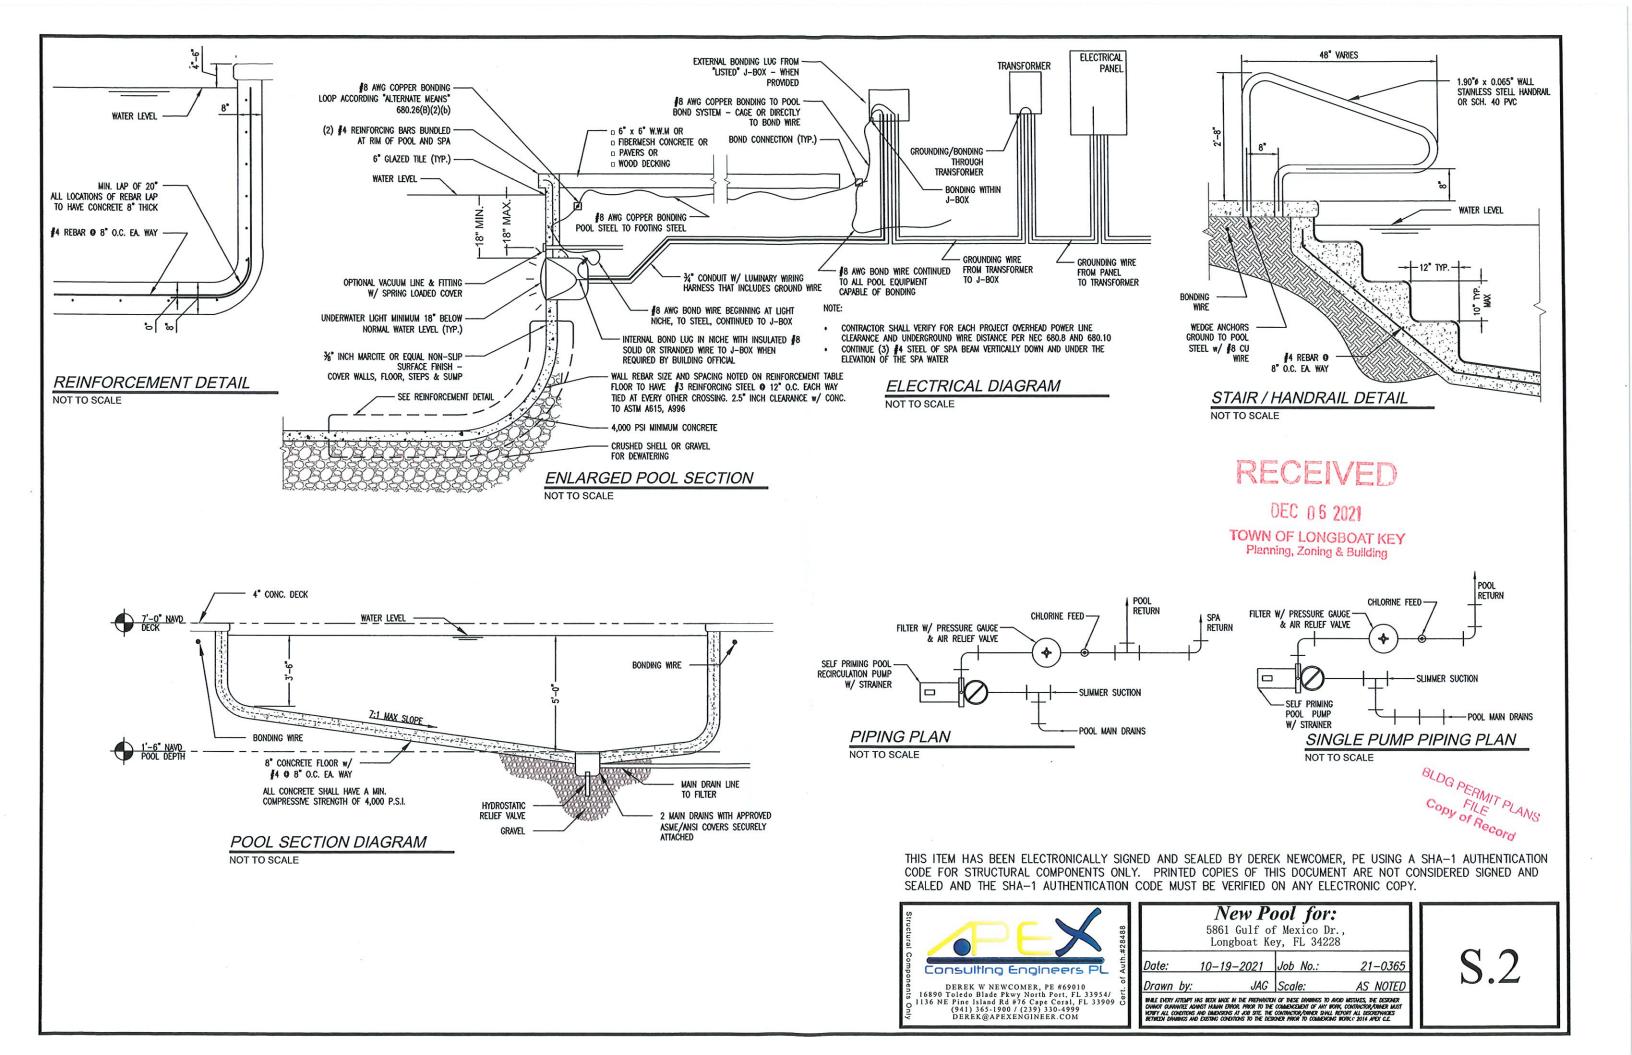

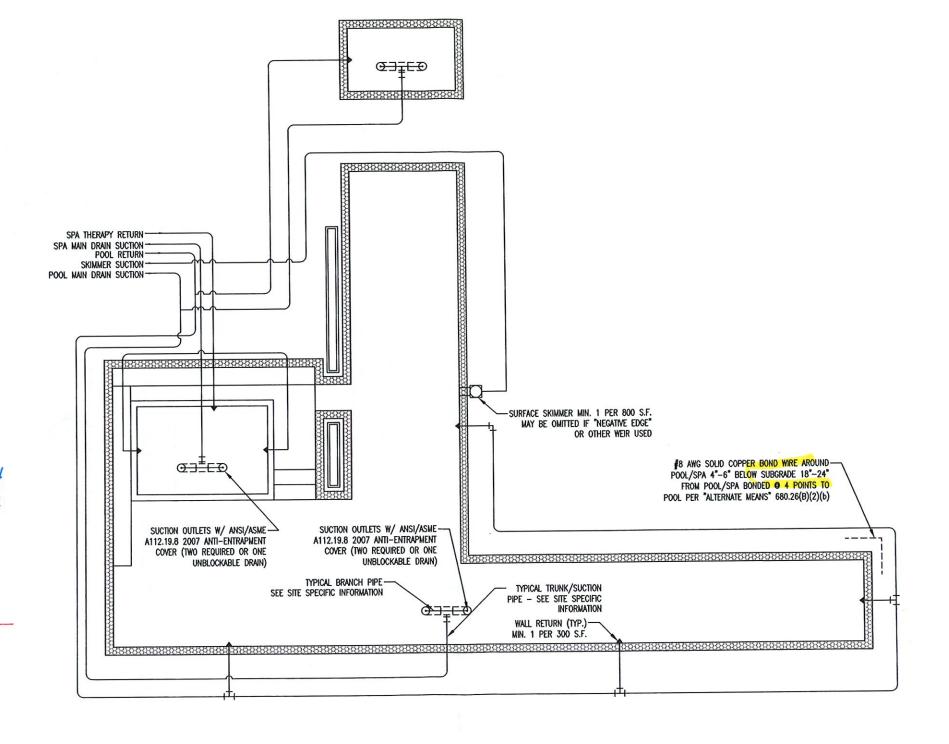

Copy of Record

Plenning, Zoning & Bluin KE

Permit # P5 P5 21 - 2084
REVIEWED FOR CODE COMPLIANCE
LONGBOAT KEY BUILDING DEPT.

DEC 14 2021

APPROVED


POOL LAYOUT
SCALE: 1/8" = 1'-0"


THIS ITEM HAS BEEN ELECTRONICALLY SIGNED AND SEALED BY DEREK NEWCOMER, PE USING A SHA-1 AUTHENTICATION CODE FOR STRUCTURAL COMPONENTS ONLY. PRINTED COPIES OF THIS DOCUMENT ARE NOT CONSIDERED SIGNED AND SEALED AND THE SHA-1 AUTHENTICATION CODE MUST BE VERIFIED ON ANY ELECTRONIC COPY.



New Pool for: 5861 Gulf of Mexico Dr., Longboat Key, FL 34228				
Date:	10-19-2021	Job No.:	21-0365	
Drawn by:	JAG	Scale:	AS NOTED	
WHE EVERY ATTEMPT HIS BEEN MICE IN THE PREPARATION OF THESE DIMINIST TO ACID MISTINES, THE DESIDER				

**S.3** 

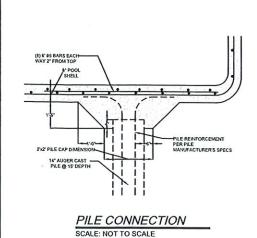

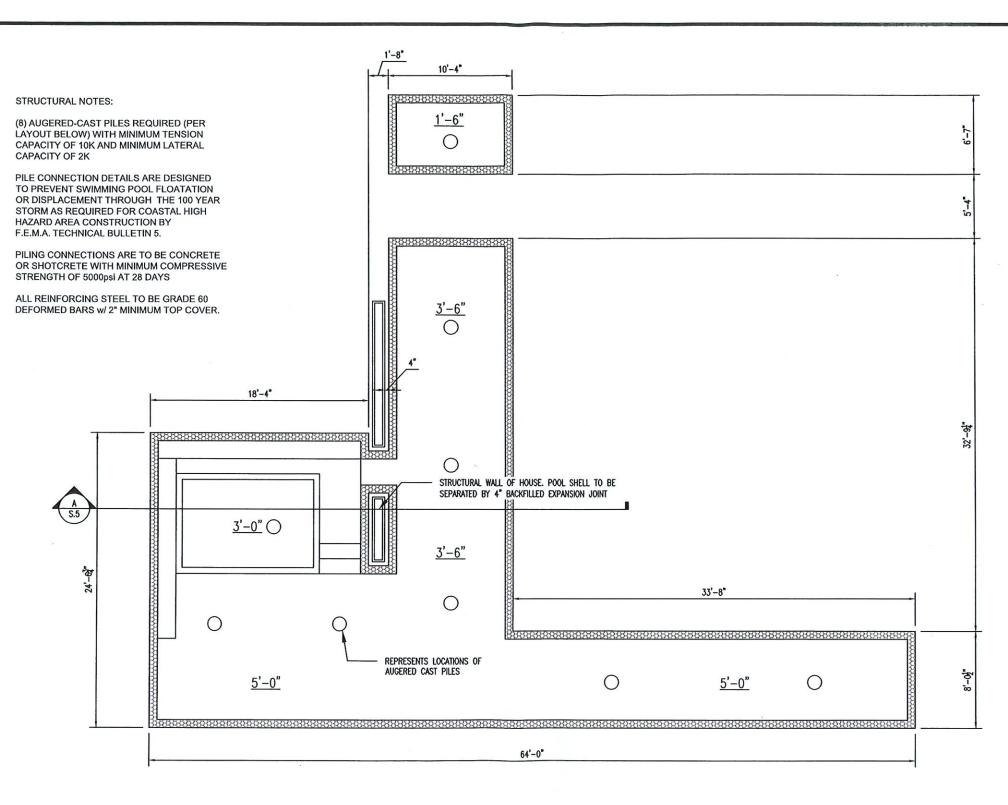

DEC 0 6 2021
TOWN OF LONGBOAT KEY
Planning, Zoning & Building

POOL LAYOUT


SCALE: 1/8" = 1'-0"

THIS ITEM HAS BEEN ELECTRONICALLY SIGNED AND SEALED BY DEREK NEWCOMER, PE USING A SHA-1 AUTHENTICATION CODE FOR STRUCTURAL COMPONENTS ONLY. PRINTED COPIES OF THIS DOCUMENT ARE NOT CONSIDERED SIGNED AND SEALED AND THE SHA-1 AUTHENTICATION CODE MUST BE VERIFIED ON ANY ELECTRONIC COPY.



5861 Gulf of Mexico Dr., Longboat Key, FL 34228				
Date:	10-19-2021	Job No.:	21-0365	
Drawn by:	JAG	Scale:	AS NOTED	

**S.4** 

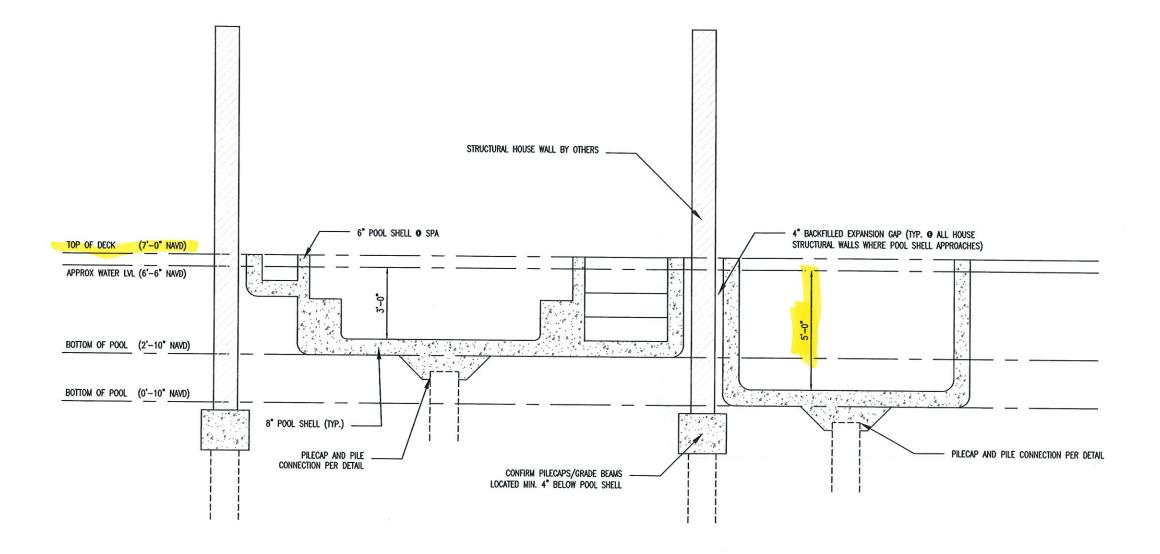

Copy of Record

RECEIVED

DEC 06 2021
TOWN OF LONGBOAT KEY
Planning, Zoning & Building

POOL SECTION


SCALE: 1/4" = 1'-0"


THIS ITEM HAS BEEN ELECTRONICALLY SIGNED AND SEALED BY DEREK NEWCOMER, PE USING A SHA-1 AUTHENTICATION CODE FOR STRUCTURAL COMPONENTS ONLY. PRINTED COPIES OF THIS DOCUMENT ARE NOT CONSIDERED SIGNED AND SEALED AND THE SHA-1 AUTHENTICATION CODE MUST BE VERIFIED ON ANY ELECTRONIC COPY.



New Pool for: 5861 Gulf of Mexico Dr., Longboat Key, FL 34228				
Date:	10-19-2021	Job No.:	21-0365	
Drawn by	: JAG	Scale:	AS NOTED	

S.5

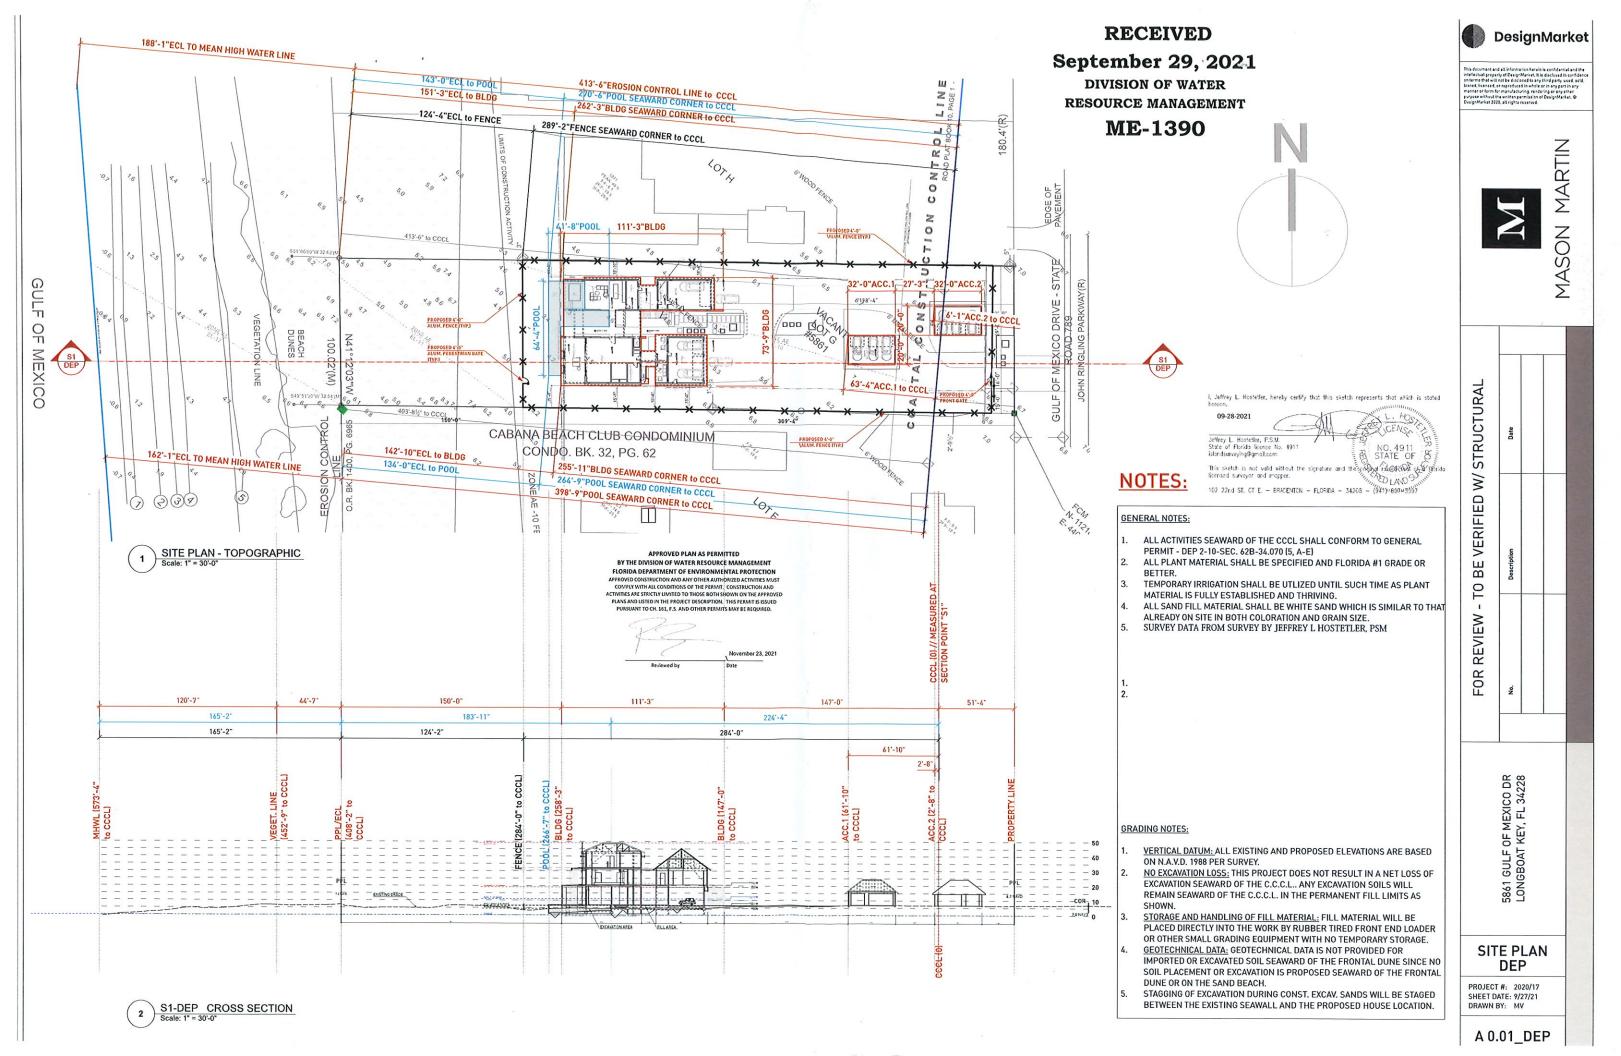

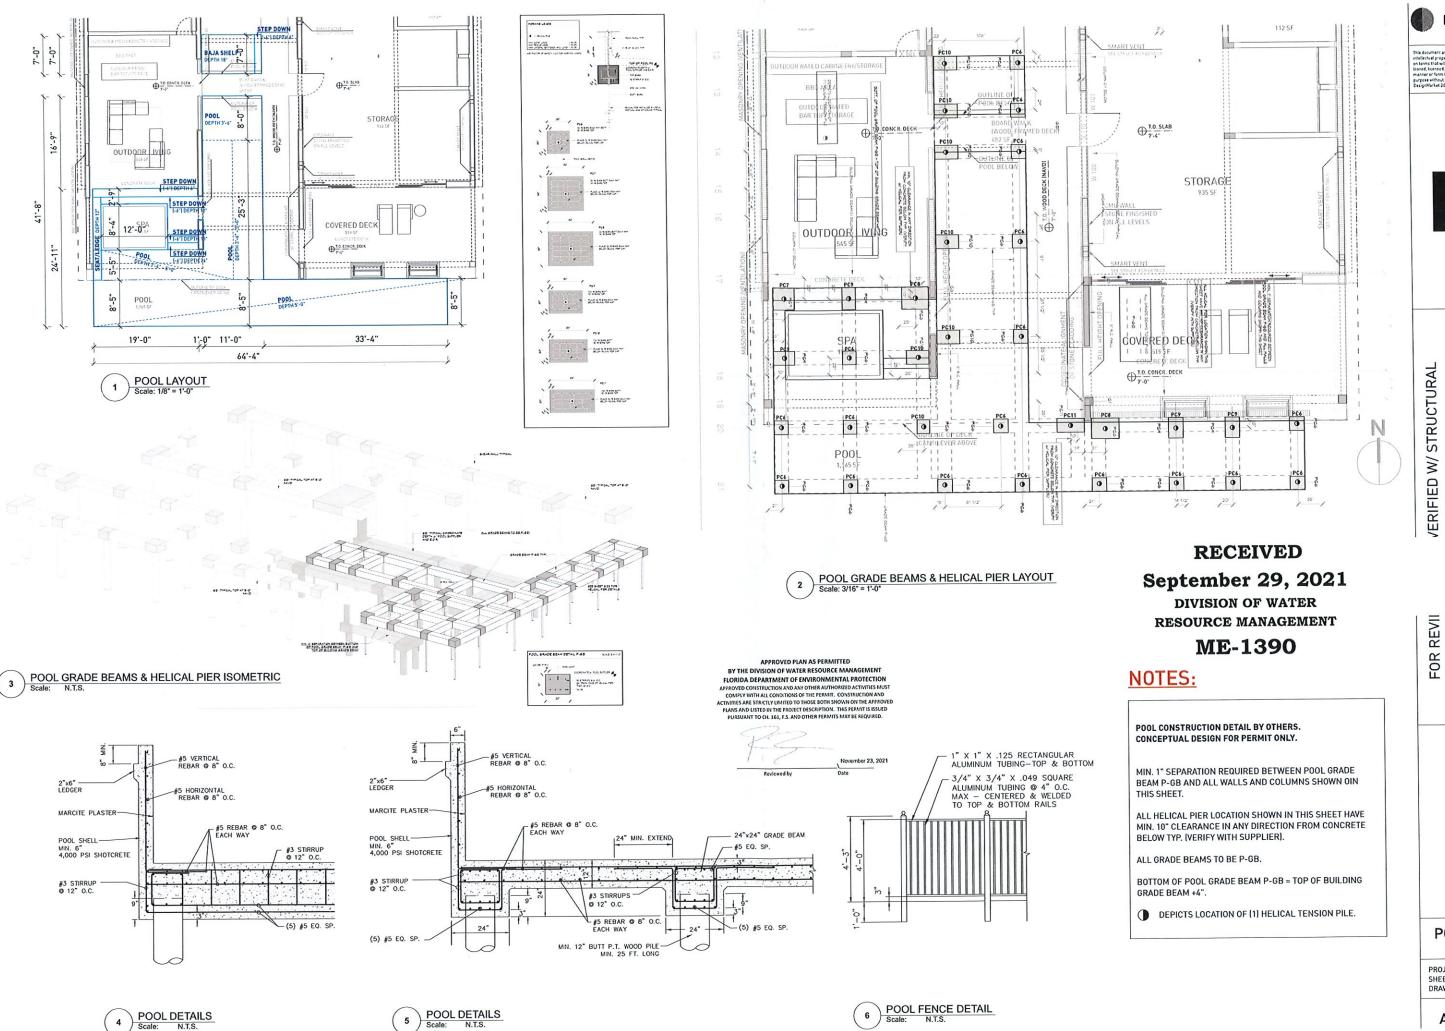

DesignMar

MASON MARTIN

VERIFIED W/ STRUCTURAL

5861 GULF OF MEXICO DR LONGBOAT KEY, FL 34228

**POOL PLAN** DEP

SHEET DATE: 9/29/21 DRAWN BY: MV

A 0.2\_DEP

# ENTRY GATE 0 0 DRIVEWAY - PERMEABLE PAVER SYSTEM 72'-0"

SCHEMATIC SITE PLAN

# RECEIVED

# September 29, 2021


DIVISION OF WATER RESOURCE MANAGEMENT

ME-1390

TURTLE LIGHT LEGEND					
SYMBOL	FIXTURE TYPE	QTY	MOUNT / HEIGHT	LEVEL	LOCATION
	CEILING FAN W/LIGHT, PREPARE FOR 75LB WEIGHT	4	CLG / 12'-6"	LVL 1	3 x BEACH SIDE (1 x in Courtyard)
H-Q	WALL MOUNT CYLINDER TURTLE LIGHT /AMBER BULB	4	WALL / 5'-0"	LVL 1	BEACH SIDE / LANDWARD
(R) <sub>C</sub>	5" REC. LIGHT W/ BLACK BAFFLE & TURTLE BULB	11	CLG / 12'-6"	LVL 1	BEACH SIDE / LANDWARD
⊢ <del></del> B	LOW VOLTAGE PATH LIGHT W/ AMBER FILM	95	FLOOR / GRADE LVL ALONG FENCE PORTIONS	GRADE	BEACH SIDE / LANDWARD
	CEILING FAN W/LIGHT, PREPARE FOR 75LB WEIGHT	5	CLG / 9'-10"	LVL 2	BEACH SIDE
H-	WALL MOUNT CYLINDER TURTLE LIGHT /AMBER BULB	1	WALL / 5'-0"	LVL 2	BEACH SIDE
	CEILING FAN W/LIGHT, PREPARE FOR 75LB WEIGHT	6	CLG / 9'-8-	LVL 3	BEACH SIDE
H-A	WALL MOUNT CYLINDER TURTLE LIGHT /AMBER BULB	4	WALL / 5'-0"	LVL 3	BEACH SIDE

### APPROVED PLAN AS PERMITTED

BY THE DIVISION OF WATER RESOURCE MANAGEMENT FLORIDA DEPARTMENT OF ENVIRONMENTAL PROTECTION OMAZY WITH ALL CONDITIONS OF THE PERMIT. CONSTRUCTION AND CITIVITIES MOST INCIDENCE OF THE PERMIT. CONSTRUCTION AND CITIVITIES ARE STRICTLY LIMITED TO THOSE BOTH SHOWN ON THE APPROVED PLAIS AND USTED IN THE PROJECT DESCRIPTION. THIS FERMIT IS ISSUED PURSUANT TO CH. 161, F.S. AND OTHER PERMITS MAY BE REQUIRED.

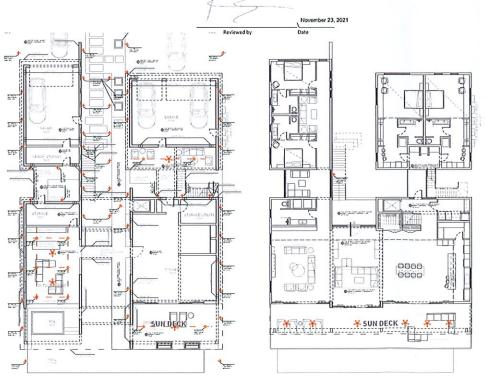

FLOOR PLAN \_\_ LVL 1



## TURTLE LIGHT SPECS

### TOPAZ **LED Retrofit** RTL/620WH/ECO/D



Product Code





70687




Model	CL-7W-E26-590
Rate Power	7W15%
input Voltage	AC85-265Y 50/60Hz
Light Color	Amber
Wavelength	590nM
Power Factor	>0.95
Lumens	80fm±5%
ghting Source	LED 2835SMD
perating Temp.	-40-60°C
Mounting	£26
Rated Life	Up to \$0,000 Hrs.
LED LMS0	Yes



OMNI DIRECTIONAL LED BULB CAT. NO .: CL-7W-E26-590 MANUF.: CYPRESS LIGHTING


APPROVED LIGHTING PLAN
This approval is limited to the exterior lights depicted
on the stamped plans. This approval does not relieve the applicant of the responsibility to obtain any other ovals or permits which may be required by Federa



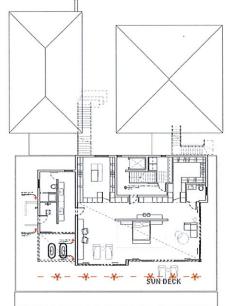

# FLOOR PLAN \_\_ LVL 3

### TURTLE LIGHT SPECS

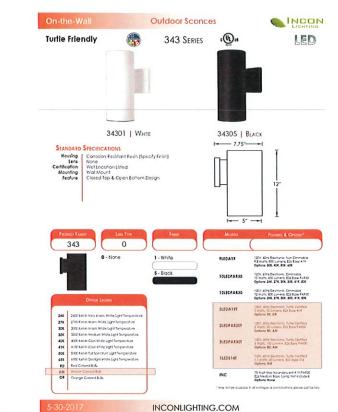

# NOTES:

### **TURTLE LIGHT NOTES:**

- NO LIGHT EMITTED ABOVE 90° ANGLE.
- ALL EXTERIOR LIGHTS TO BE SHIELDED, FULL CUT-OFF FIXTURES.
- ALL BULBS TO BE RED, ORANGE, AMBER LED, OR LOW-E PRESSURE SODIUM (LPS).
- MAX. VISIBLE LIGHT TRANSMITTANCE FROM INSIDE TO OUTSIDE IS LIMITED TO 45% (.45) FOR ANY BEACH FACING GLAZED OPENINGS.
- NOAS AND PRODUCT SPECIFICATIONS TO BE PROVIDED TO THE CITY FOR WINDOWS AND DOORS INDICATING COMPLIANCE WITH TURTLE LIGHTING TRANSMITTANCE ORDINANCE, SHOULD WINDOW AND DOOR SELECTIONS NOT MEET TURTLE LIGHTING TRANSMITTANCE ORDINANCE UPON INSPECTION, APPROVED GLASS FILM WILL BE APPLIED TO ALL APPLICABLE GLASS OPENINGS.
- APPLICABLE PROPOSED EXTERIOR LIGHTING FIXTURES SHALL BE COMPLIANT W/CITY CODE OF ORDINANCE, WHEN SELECTIONS ARE MADE BY THE OWNER. MAX. VISIBLE LIGHT TRANSMITTANCE FROM THE INSIDE TO OUTSIDE IS LIMITED TO 45% (.45) FOR ANY BEACH FACING GLAZED OPENINGS W/TURTLE
- APPROVED GLASS FILM WILL BE APPLIED TO ALL APPLICABLE GLASS OPENING(S) AND THAT PROPOSED EXTERIOR LIGHTING 'OWNER-SELECTED-OPTIONS' WILL BE LIMITED TO ONLY THOSE COMPLIANT TO TOWN'S AND STATE'S CODE OR ORDINANCE.

ALL ELEVATIONS REFER TO THE NORTH AMERICA VERTICAL DATUM OF 1988 [NAVD88]



MASON MARTIN

STRUCTURAL ⋛ VERIFIED ш B 2 REVIEW FOR

> OF MEXICO DR T KEY, FL 34228 5861 GULF C LONGBOAT

**TURTLE** LIGHTS

PROJECT #: 2020/17 SHEET DATE: 9/27/21

A 0.3

