


672 DREAM Island Rd. Longboat KEY

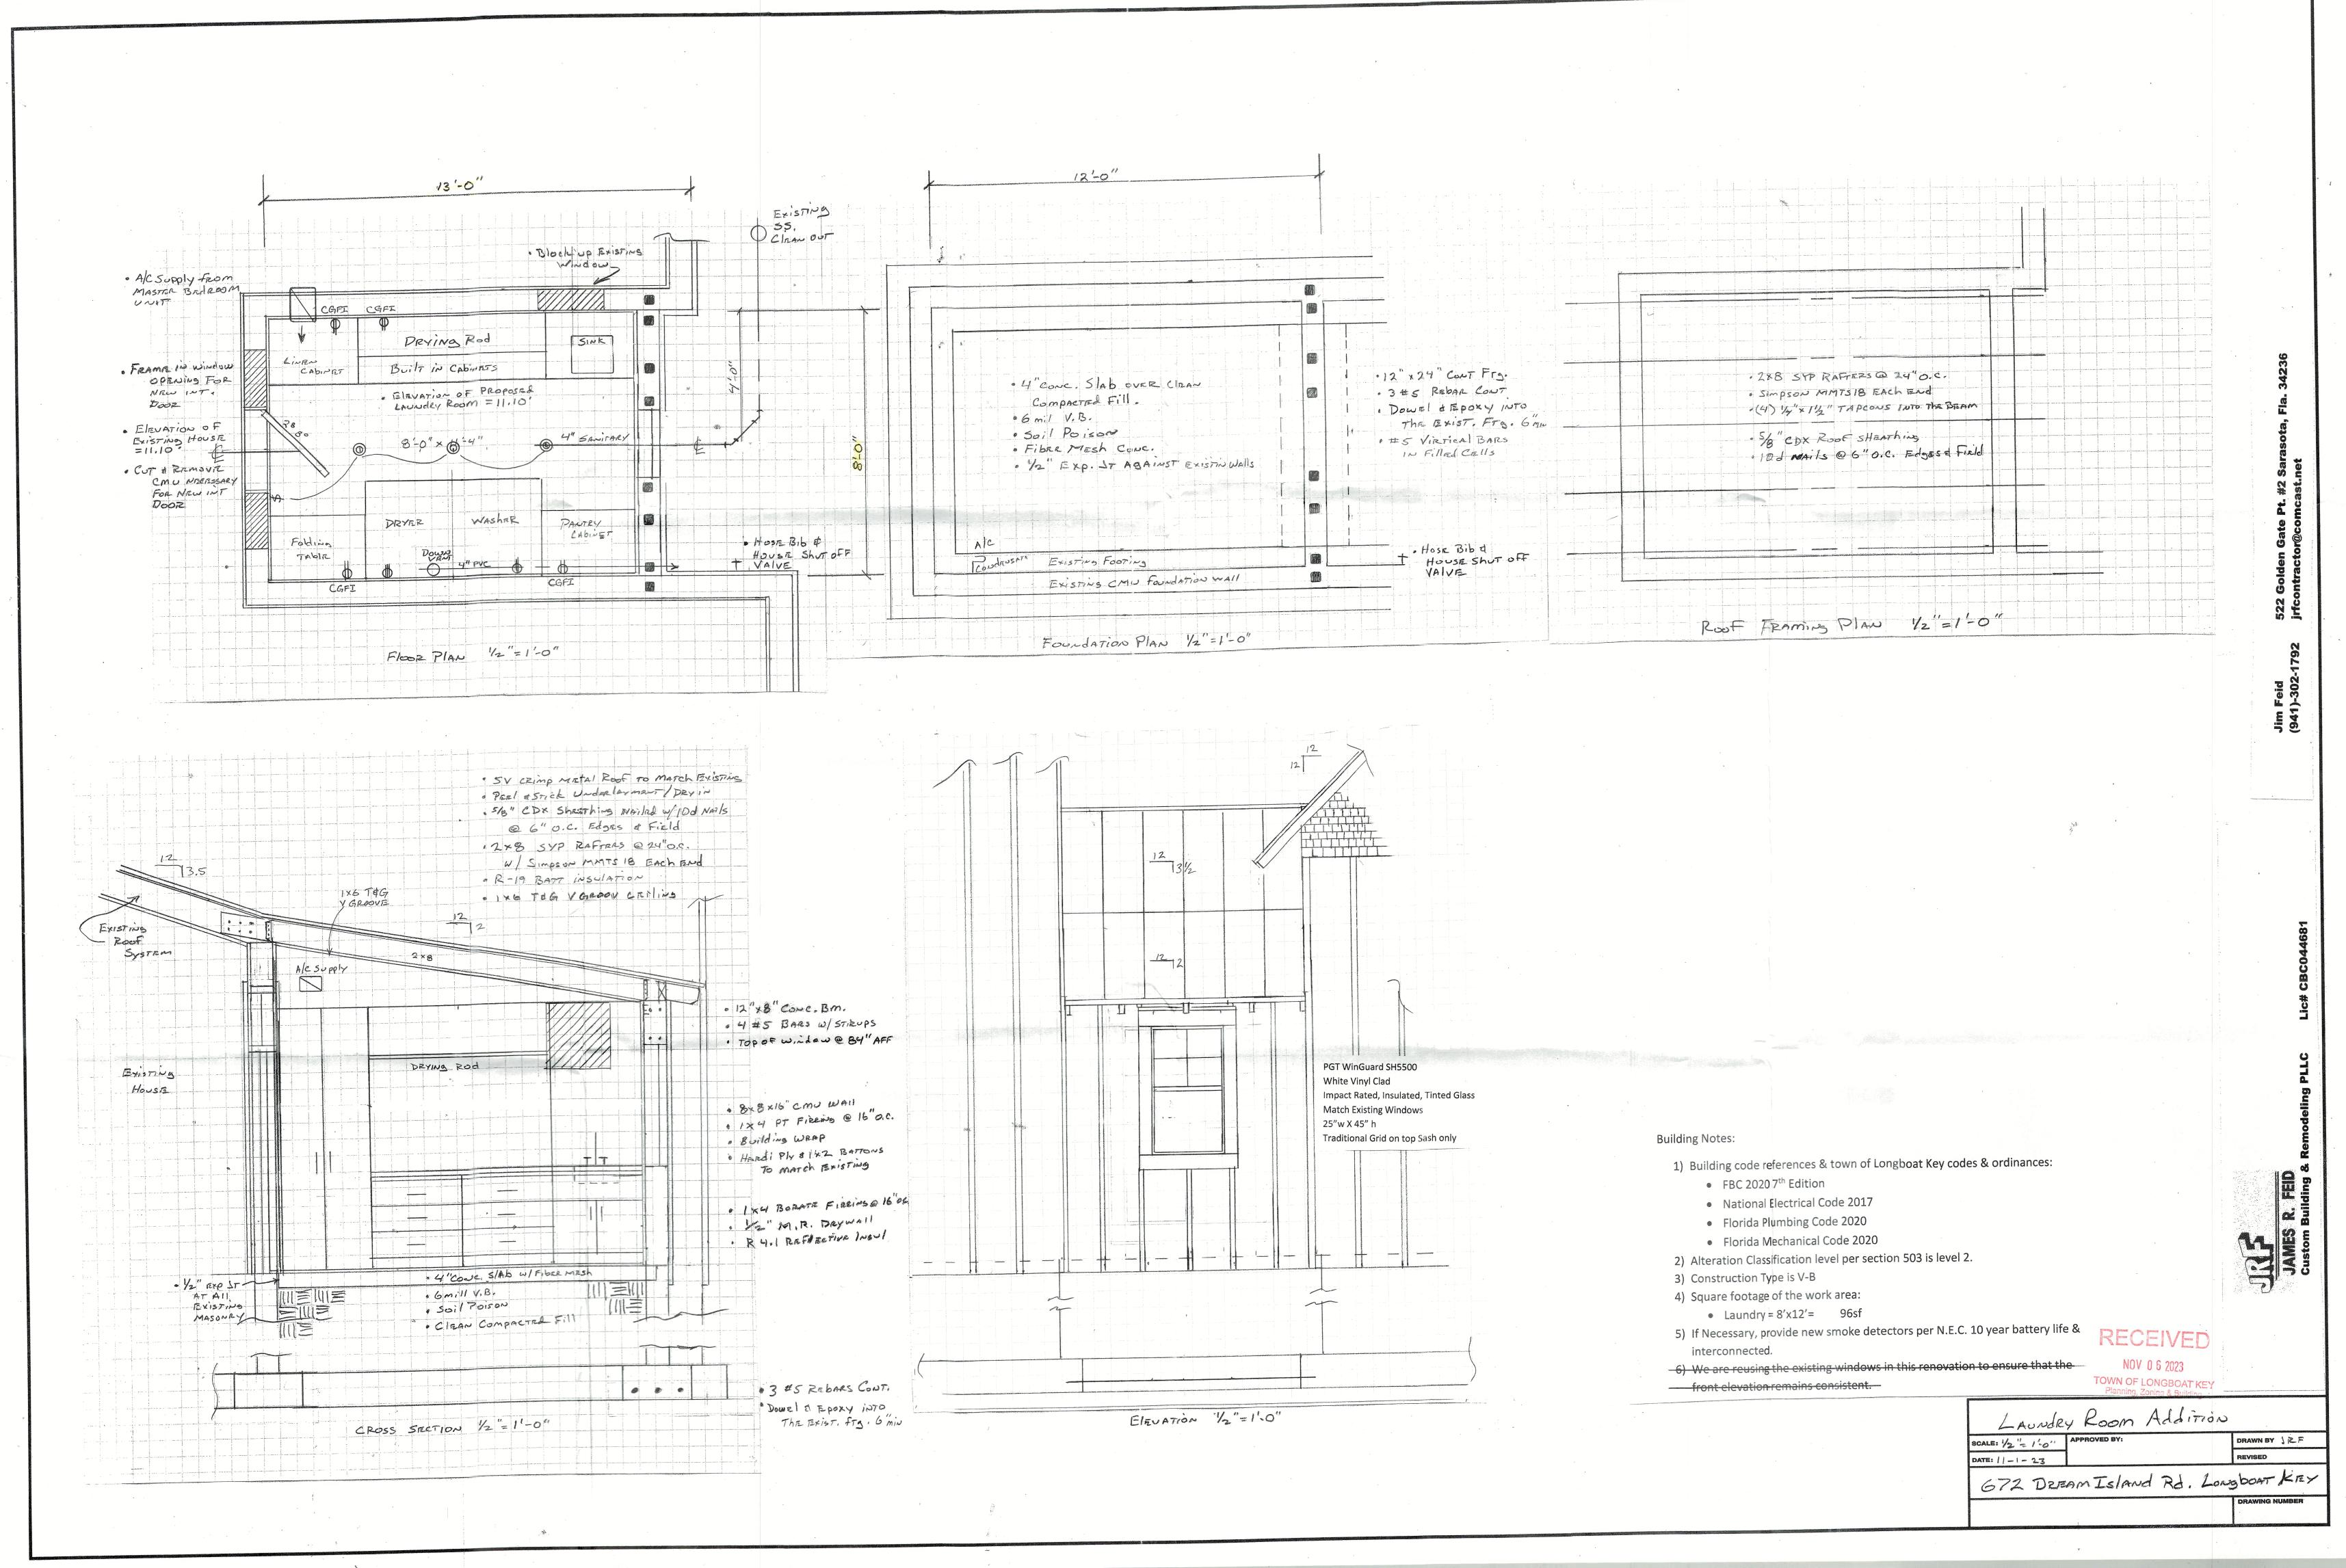

An Addition for:

672 Dream Island Rd. Longboat Key, Florida 34228

DESIGN CRITERIA

ALL WORK IS TO BE IN ACCORDANCE WITH THE FLORIDA BUILDING CODE 2020, (7th EDITION).

OCCUPANCY TYPE: R-3
ALTERATION CLASSIFICATION: 2
CONSTRUCTION TYPE: V-B
BASIC WIND SPEED: 150 mph
RISK CATEGORY: II
EXPOSURE CATEGORY: D
ENCLOSURE CLASSIFICATION: ENCLOSED
INTERNAL PRESSURE COEF: +/- 0.18

SCOPE OF WORK:


- SUPPLEMENTAL STRUCTURAL PLANS FOR EXISTING ARCHITECTURAL PLANS.
- 2. LAUNDRY ROOM ADDITION.
- 3. STRUCTURAL ENGINEERING FOR ROOF RAFTERS.

INDEX SHEET

G-1 COVER PAGE

S-1 NOTES & SPECIFICATIONS S-2 ROOF FRAMING PLAN

S-3 STRUCTURAL DETAIL SECTION

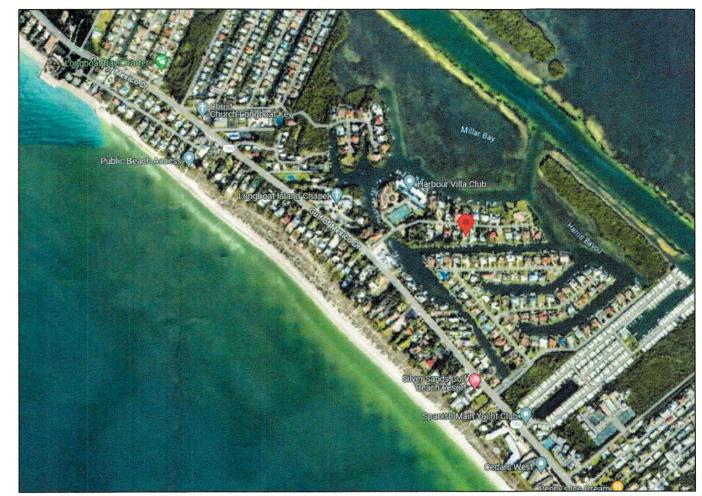


BLDG PERMIT PLANS FILE Copy of Record

VICINITY MAP:

RECEIVED

APR 0 9 2024

TOWN OF LONGBOAT KEY Planning, Zoning & Building

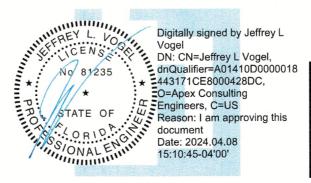

THIS ITEM HAS BEEN ELECTRONICALLY SIGNED AND SEALED BY JEFFREY VOGEL, PE USING A SHA-1 AUTHENTICATION CODE. PRINTED COPIES OF THIS DOCUMENT ARE NOT CONSIDERED SIGNED AND SEALED AND THE SHA-1 AUTHENTICATION CODE MUST BE VERIFIED ON ANY ELECTRONIC COPY



An Addition for 672 Dream Island Rd. Longboat Key, Florida 34228 PROJECT NO.: 24–0062 DRAWN BY: CS

4/8/2024

G-

GENERAL NOTES:

DO NOT SCALE DRAWINGS, USE DIMENSIONS PROVIDED, TYPICALLY. IN THE CASE OF DIMENSIONAL CONFLICT ARCHITECTURAL DIMENSIONS GOVERN OVER STRUCTURAL DIMENSIONS TYPICALLY

STRUCTURAL DRAWINGS ARE NOT TO BE REPRODUCED WITHOUT WRITTEN CONSENT OF APEX CONSULTING ENGINEERS.

NO PENETRATIONS SHALL BE MADE IN ANY STRUCTURAL MEMBERS OTHER THAN THOSE LOCATED ON THESE DRAWINGS WITHOUT PREVIOUS APPROVAL FROM THE ENGINEER OF RECORD.

ALL OTHER JOB SPECIFICATION AND FINISH SPECIFICATIONS TO BE FURNISHED TO GENERAL CONTRACTOR BY THE HOME OWNER AND ARE NOT PART OF THESE DRAWINGS

BRAND, STYLE, KIND, COLOR, ETC. OF ALL FINISHES & MATERIALS, ELECTRICAL FIXTURES, APPLIANCES, EQUIPMENT AS AGREED & NEGOTIATED BETWEEN OWNER & CONTRACTOR.

WHILE EVERY ATTEMPT HAS BEEN MADE IN THE PREPARATION OF THESE DRAWINGS TO AVOID MISTAKES, THE DESIGNER CANNOT GUARANTEE AGAINST HUMAN ERROR. PRIOR TO THE COMMENCEMENT OF ANY WORK, CONTRACTOR/OWNER MUST VERIFY ALL CONDITIONS AND DIMENSIONS AT JOB SITE. THE CONTRACTOR/OWNER SHALL REPORT ALL DISCREPANCIES BETWEEN DRAWINGS AND EXISTING CONDITIONS TO THE DESIGNER PRIOR TO COMMENCING WORK. © 2024 APEX C.E.

DESIGN LOADS AND NOTES:

DEAD LOADS

 TYPICAL FLOOR LOADING 	- 20PSF
TYPICAL ROOF LOADING	
METAL OR SHINGLE ROOFING	- 15 PSF
TILE ROOFING	- 25 PSF
BOTTOM CHORD	- 10 PSF

LOADING DOES NOT COUNT FOR ANY CONCRETE FLOATING OVER FLOORING/ROOFING.

ANY CHANGES MADE TO THE MATERIALS OF THE STRUCTURE FROM THOSE OF THE ARCHITECTURAL AND STRUCTURAL PLANS SHALL BE NOTIFIED TO THE ENGINEER OF RECORD FROM THE CONTRACTOR TO VERIEY THAT THE NEW LOADS CONFORM TO THE STRUCTURE AND ITS LOAD CARRYING CAPACITY.

- 30PSF

LIVE LOADS

FLOOF

	ALL OTHER AREAS	EXCEPT BALCONIES	- 40PSF
	BALCONIES & DECK	(S	- 60PSF
	STAIRS		- 40PSF
0	F:		
	TOP CHORD (FLAT,	PITCHED OR CURVED)	- 20PSF
	BOTTOM CHORD		
	UNINHABITAB	LE ATTICS w/o STORAGE	- 10PSF
	UNINHABITAB	LE ATTICS w/ STORAGE	- 20PSF

HABITABLE ATTICS & SLEEPING AREAS

WIND LOADS

SEE COMPONENT & CLADDING CHART FOR PRESSURES

LATERAL LOADS IN TRUSSES ARE RESISTED BY ROOF DIAPHRAGM AT POINT OF WIND LOAD INPUT UNLESS NOTED OTHERWISE.

FRAMING NOTES:

STRUCTURAL WOOD COMPONENTS (BEAMS, JOISTS, RAFTERS, BEARING WALLS/COLUMNS, SHEAR WALLS, ETC.) SHALL BE MINIMUM #2 SOUTHERN YELLOW PINE. ALL WOOD FRAMING MATERIALS SHALL BE SURFACE DRY AND USED AT 19% MAXIMUM MOISTURE CONTENT. ALL FRAMING EXPOSED TO THE WEATHER OR IN CONTACT WITH MASONRY OR CONCRETE SHALL BE PRESSURE TREATED.

GLB OR SYP POSTS SHALL BEAR DIRECTLY ON CONCRETE SLAB OR ON SYP OR PT PLATE UNLESS NOTED OTHERWISE.

TRUSSES AND BEAMS SHALL BEAR DIRECTLY ON GLB OR SYP POSTS U.N.O. WHERE REQUIRED, SHIMS TO BE A36 STEEL U.N.O.

MEMBERS DESIGNATED 'LVL' (E.G., 1 3/4" x 14" LVL) SHALL BE LAMINATED VENEER LUMBER AS MANUFACTURED BY BOISE (VERSA-LAM) OR ENGINEER APPROVED SUBSTITUTION.

TYPICAL WALL EXTERIOR WALL SHEATHING SHALL BE 15/32" W/ RING OR SMOOTH SHANK NAILS OF A DIAMETER NO LESS THEN 0.113" AND LENGTH NO LESS THAN 2%" SHALL BE USED AND SPACING OF 6" O.C. IN FIELD AND ON EDGES.

IF NOT NOTED IN PLANS WOOD CONNECTIONS SHALL FOLLOW FBC 2020 TABLE 2304.10.1 FASTENING SCHEDULE.

CONNECTORS:

PREFABRICATED METAL JOIST HANGERS, HURRICANE CLIPS, HOLD-DOWN ANCHORS AND OTHER ACCESSORIES SHALL BE MANUFACTURED BY SIMPSON STRONG TIE COMPANY OR EQUIVALENT. INSTALL ALL ACCESSORIES AS PER MANUFACTURERS REQUIREMENTS. ALL STEEL SHALL HAVE A MINIMUM THICKNESS OF 0.04 INCHES (ASTM A446 GRADE A) AND BE GALVANIZED (COATING G60).

USE TRUSS HANGERS TO ATTACH FLOOR TRUSSES TO LVL BEAMS IF LESS THAN 3-1/2" SQUARE BEARING AREA IS PROVIDED.

FOR FLOOR FRAMING; USE SIMPSON H2.5A AT EACH INTERIOR MEMBER (WITH OR WITHOUT UPLIFT) WHERE POSSIBLE. PROVIDE ADDITIONAL TIEDOWNS FOR GREATER UPLIFTS.

BOLT HEADS SHALL BE CENTERED & DRILLED NO MORE THAN 1/16" LARGER THAN BOLT DIAMETER. BOLTED CONNECTIONS SHALL BE TIGHT BUT NOT TO THE EXTENT OF CRUSHING WOOD LINDER WASHERS.


PEST/DECAY PROTECTION NOTES:

ALL PLANTINGS AND IRRIGATION/SPRINKLER SYSTEMS AND RISERS FOR SPRAY HEADS SHALL BE AT LEAST 1 FOOT FROM BUILDING SIDEWALLS.


SOIL TREATMENT SHALL MEET THE REQUIREMENTS OF 2020 FBC R318 METHOD.

PROTECTION AGAINST DECAY AND TERMITES SHALL BE PROVIDED IN ACCORDANCE WITH 2020 FBC R317, R318.

ROOF FLASHING SHALL BE PROVIDED IN ACCORDANCE WITH THE REQUIREMENTS OF 2020 FBC R903.

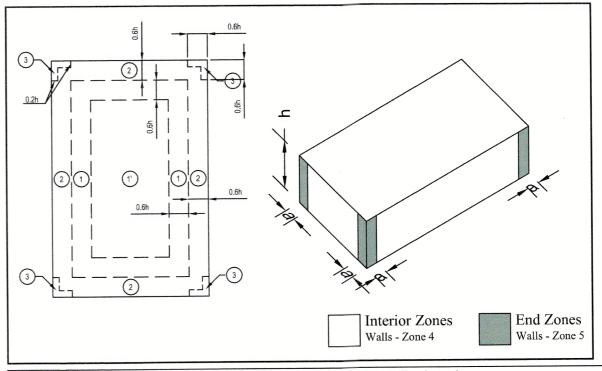

Ultimate V	Vind Speed	= 150 mph	, Exposure	D	Fully Enclos	sed			a fin canada da
Effective	ctive Walls Roof								
Wind	Positive	Nega	ative	Positive		Nega	ative		
Area	All Zones	Zone 4	Zone 5	All Zones	Zone 1	Zone 2	Zone 3	Not Used	
10	36.67	-39.78	-49.10	24.24	-56.56	-78.31	-106.27		
20	35.02	-38.12	-45.79	22.08	-47.06	-66.09	-89.44		
30	34.05	-37.16	-43.86	20.82	-41.50	-58.94	-79.59		
40	33.36	-36.47	-42.49	19.92	-37.56	-53.87	-72.60		1
50	32.83	-35.94	-41.43	19.23	-34.50	-49.93	-67.18		
60	32.40	-35.51	-40.56	18.66	-32.00	-46.72	-62.75		
70	32.03	-35.14	-39.82	18.18	-29.89	-44.00	B59.00	PERMI	TPLANS
80	31.71	-34.82	-39.19	17.77	-28.06	-41.64	-55.76	FHF	di accompany
90	31.43	-34.54	-38.62	17.40	-26.44	-39.57	-52.90	ny of R	ecord
100	31.18	-34.29	-38.12	17.07	-25.00	-37.71	-50.34	PYOIN	ecoru
500	27.34	-30.45	-30.45	14.92	-10.00	-25.48	-50.34		
								VED	augus per de la company de la

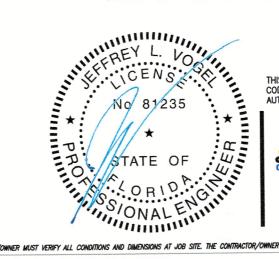

APR 0 9 2024

THIS ITEM HAS BEEN ELECTRONICALLY SIGNED AND SEALED BY JEFFREY VOGEL, PE USING A SHA-1 AUTHENTICATION Y CODE. PRINTED COPIES OF THIS DOCUMENT ARE NOT CONSIDERED SIGNED AND SEALED AND THE SHA-2 Building AUTHENTICATION CODE MUST BE VERIFIED ON ANY ELECTRONIC COPY



JEFF@APEXENGINEER.COM

Cert, of Auth.#33881


© 2024 APEX C.E.

An Addition for 672 Dream Island Rd. Longboat Key, Florida 34228

PROJECT NO.: 24-0062
DRAWN BY: CS
DATE: 4/8/2024

S-1

WHILE EVERY ATTEMPT HAS BEEN MADE IN THE PREPARATION OF THESE DRAWINGS TO AVOID MISTAKES, THE DESIGNER CANNOT GUARANTEE AGAINST HUMAN ERROR. PRIOR TO THE COMMENCING WORK.

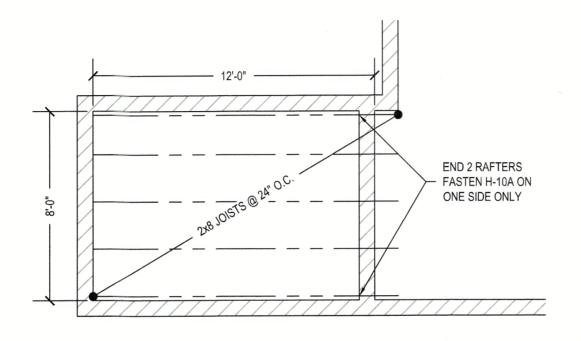

ROOF FRAMING PLAN

SCALE: 1/4" = 1'-0"

BLDG PERMIT PLANS FILE Copy of Record

RECEIVED

APR 0 9 2024

TOWN OF LONGBOAT KEY Planning, Zoning & Building



JEFFREY L. VOGEL, PE #81235 4315 53RD AVE E, BRADENTON FL 34203 TEL (941) 365-1900/ FAX (888)365-4041 JEFF@APEXENGINEER.COM

THIS ITEM HAS BEEN ELECTRONICALLY SIGNED AND SEALED BY JEFFREY VOGEL, PE USING A SHA-1 AUTHENTICATION CODE. PRINTED COPIES OF THIS DOCUMENT ARE NOT CONSIDERED SIGNED AND SEALED AND THE SHA-1 AUTHENTICATION CODE MUST BE VERIFIED ON ANY ELECTRONIC COPY An Addition for 672 Dream Island Rd. Longboat Key, Florida 34228 S-2 PROJECT NO .: 24-0062 DRAWN BY: CS 4/8/2024

WHILE EVERY ATTEMPT HAS BEEN MADE IN THE PREPARATION OF THESE DRAWINGS TO AVOID MISTAKES, THE DESIGNER CANNOT GUARANTEE AGAINST HUMAN ERROR. PRIOR TO COMMENCING WORK,

