




ENGINEERING, INC.

Consulting Engineers #5396 6389 TOWER LANE Sarasota, Fl. 34240

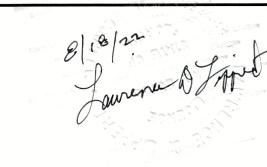


LAWRENCE D. LIPPERT, P.E. FL. REG. NO. 23985

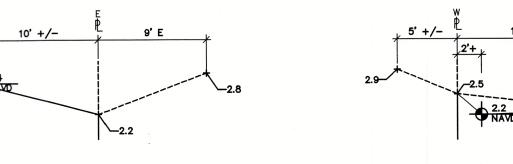

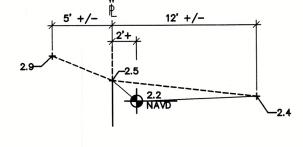

WEST DETAIL @ EXCAVATION SECTION

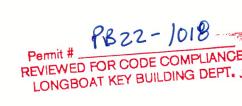

Reviewer: PATT FIGE

NOTE: THE SOUTHWEST 30' +/- IS TO BE GRADED AS SHOWN. THE REMAINING LOT PERIMETER HAS EXISTING ELEVATIONS THAT DIRECT RUNOFF TO MARBURY LANE OR THE EXISTING CANAL. SITE CONTRACTOR SHALL CONFIRM FINAL SITE GRADING ELEVATIONS MATCH EXISTING.



COMPLIANCE WITH BEST MANAGEMENT PRACTICES FOR EROSION CONTROL AND STORM WATER RUN-OFF DURING CONSTRUCTION: BEFORE ANY CLEARING OR GRADING OCCURS: CONTRACTOR TO ERECT CONTINUOUS SILT FENCE ON SIDES SILT FENCING TO BE EMBEDDED A MINIMUM OF 6" INTO THE SOIL AND SECURED BY WOOD STAKING AS PROVIDED WITH

ROTECT WITH SAND BAGS OR HAY BALES TO CONTROL SEDIMENT FLOW. DURING CLEARING/GRADING: ALL ORGANIC MATERIAL THAT IS STRIPPED FROM THE SITE SHALL BE REMOVED FROM THE SITE IMMEDIATELY, NO STOCK-PILING OF DEBRIS FOR MORE THAT A DAY.
TEMPORARY SWALES SHALL BE CUT IN FRONT OF SILT FENCING O DIRECT STORM WATER PER DRAINAGE PLAN. **DURING CONSTRUCTION:** CONTROL WASTE FROM ACCUMULATING ON SITE. PROVIDE INTERMITTENT SITE INSPECTIONS BY SITE SUPERVISOR(S)

NOTE: THESE DRAWINGS ARE NOT TO BE SCALED

FENCING MATERIAL. SILT FENCE TO BE INSPECTED REGULARLY AND ANY DAMAGED MATERIAL TO BE IMMEDIATELY REPAIRED OR REPLACED. IF THERE ARE ANY STORM SEWERS PRESENT AT THE STREET,

FOR WASTE/TRASH CONTROL NO CONCRÉTE WASHOUT TO BE ALLOWED ON SITE; INFORM SUPPLIERS IN ADVANCE OF THIS RULE.

DRAINAGE PLAN SCALE: 1/8" = 1'-0"

CUSTOR BOB 8 SPAN 759 MARI LONGBOA

Plan no.

2021-50 D1.0

REVISIONS: NO. DESCRIP: BY DATE

DATE: 8-15-2022

SCALE: AS SHOWN

SHEET TITLE:

DRAINAGE PLAN SHEET NO.

THE HOMEOWNER. THE DRAWINGS HAVE BEEN DONE TO THE BEST OF JC DRAFTING & DESIGN INC.'S KNOWLEDGE THE PLANS AND SPECIFICATIONS COMPLY WITH THE APPLICABLE MINIMUM FLORIDA BUILDING CODES AND FIRE SAFETY STANDARDS AND ANY CONDITIONS WHICH APPEAR TO BE INACCURATE SHALL BE BROUGHT TO THE DESIGNER, STRUCTURAL ENGINEER THE GENERAL CONTRACTOR'S ATTENTION AND CORRECTED. THE GENERAL CONTRACTOR SHALL EXAMINE THE PLANS COMPLETELY AND VISIT THE JOB SITE BEFORE BEGINNING CONSTRUCTION ON THIS PROJECT IT SHALL BE THE GENERAL CONTRACTORS RESPONSIBILITY TO INSURE THAT THE STRUCTURE CAN BE CONSTRUCTED AS DRAWN OR WITH ADDENDUM DRAWINGS TO BE PROVIDE BY THE DESIGNER ONLY. THIS GENERAL CONTRACTOR SHALL VERIFY ALL DIMENSIONS AND CRITICAL HEIGHTS. IT WILL ALSO BE $\dot{}$ GENERAL CONTRACTOR'S RESPONSIBILITY TO OBTAIN ALL NECESSARY PERMITS AND MEET ALL STATE AND LOCAL BUILDING CODES. ALL DISCREPANCIES ARE TO BE BROUGHT TO THE ATTENTION OF THE DESIGNER IN WRITING. ANY STRUCTURAL CHANGES THAT APPEAR TO BE NEEDED ARE TO BE BROUGHT. TO THE ATTENTION OF THE STRUCTURAL ENGINEER OF RECORD FOR THIS PROJECT. WORK IS NOT T PROCEED UNTIL ALL DISCREPANCIES ARE CORRECTED. THE GENERAL CONTRACTOR SHALL CHECK AN VERIFY ALL DIMENSIONS AND COORDINATE ALL CONDITIONS IN THE FIELD. ALL DISCREPANCIES

DESIGN, INC. NO CHANGE TO THESE DRAWINGS MAY BE MADE WITHOUT A DEPICTED AND SPECIFIED ON THESE DRAWINGS ARE PROTECTED UNDER THE COPYRIGHT

HE UNITED STATES AND ARE THE PROPERTY OF JC DRAFTING & DESIGN, INC. AND SHAL BE RETURNED IN THE EVENT OF TERMINATION. USE OR COPY IS PERMITTED BY CONTRACT ONLY. AN CHANGES TO THESE PLANS WITHOUT THE WRITTEN APPROVAL OF JC DRAFTING & DESIGN, INC. OR ALL CONSTRUCTION EXECUTED FROM THESE PLANS WITHOUT THE EXPRESSED WRITTEN APPROVAL OF JC DRAFTING & DESIGN, INC SHALL AUTOMATICALLY RENDER JC DRAFTING & DESIGN, INC AND ITS EMPLOYEES HARMLESS TO ANY LIABILITY CLAIMS, SUIT OR LITIGATION BY ANY INTERESTED PARTIES IN THE PROJECT.

ALL CONSTRUCTION TO BE IN STRICT ACCORDANCE WITH GOVERNING (
ALL MANUFACTURED PRODUCTS AND MATERIALS SHALL BE USED IN ACCORDANCE WITH THE MANUFACTURERS SPECIFICATION RECOMMENDATIONS

5. ALL DIMENSIONS ARE TO ROUGH CONSTRUCTION UNLESS NOTED OTHERWISE. THE GENERAL

PROJECT DATA

TITLE PROJECT

SPANOS RESIDENCE

PROJECT LOCATION

759 MARBURY LANE LONGBOAT KEY FL. 34228 SURVEYOR:

HYATT SURVEY SERVICES, INC. 2021 LENA ROAD BRADENTON, FLORIDA 34211 PHONE NO. 941-748-4693

CUSTOM RESIDENCE DESIGNED BY:

JC DRAFTING & DESIGN, INC.

(Residential Drafting and Design)

905 PONDER AVE. SUITE C

Sarasota, FL 34232 PH (941) 925 - 3009

CONTACT: Jon R. Coulthurst, President COPYRIGHT - JC DRAFTING & DESIGN, INC.

PROJECT STRUCTURAL ENGINEER:

STRUCTURAL ENGINEERING ALLIANCE, INC.

THOMAS WINKLER, P.E. CONTACT NO: 941-932-7274

FL. REG. NO. 54400

GENERAL CONTRACTOR: JONAS YODER CUSTOM HOMES

905 PONDER AVE.

SARASOTA, FL 34232 - CBC1258281

SPANOS RESIDENCE



INDEX OF DRAWINGS

BUILDING "A" SHEETS

CS1.0 = COVER SHEET

A1.0 = SITE PLAN, AND LOT COVERAGE CALCULATIONS

A1.1 = GROUND FLOOR PLAN

A2.0 = FIRST FLOOR PLAN

A2.1 = FIRST FLOOR DIMENSIONAL PLAN A2.2 = FIRST FLOOR WINDOW AND DOOR SCHEDULE

A2.3 = FIRST FLOOR ROOF PLAN

= SECOND FLOOR PLAN

= SECOND FLOOR DIMENSIONAL PLAN

= SECOND FLOOR WINDOW AND DOOR SCHEDULE = UPPER ROOF AND ROOF TOP DECK FRAMING PLAN

A4.0 = OPEN DECK FLOOR PLAN W/ DIMENSIONS A5.0 = ELEVATIONS

= ELEVATIONS

= BUILDING SECTIONS A-A AND B-B

= BUILDING SECTIONS C-C AND D-D SHEET A9.0 = BUILDING SECTION E-ESHEET

A10.0 = BUILDING SECTION F-F

A11.0 = BUILDING SECTION G-G AND TYPICAL DETAILS

A12.0 = BUILDING SECTION H-H

A13.0 = TYPICAL DETAILS SHEET A14.0 = TYPICAL DETAILS

SHEET E1.0 = FIRST FLOOR ELECTRICAL PLAN SHEET E2.0 = SECOND FLOOR ELECTRICAL PLAN

STRUCTURAL

S1.0 = STRUCTURAL NOTES AND TYPICAL DETAILS

S2.0 = FOUNDATION PLAN

S3.0 = 1ST FLOOR FRAMING PLAN S4.0 = SECOND FLOOR FRAMING PLAN

S5.0 = HIGH ROOF FRAMING PLAN SHEET S6.0 = DETAILS

SHEET S7.0 = DETAILS

DRAINAGE

SHEET D1.0 = DRAINAGE PLAN

Reviewed for Code Compliance FLITE PERMITS OF SARASOTA

DESIGN CRITERIA

BUILDING CODE: FLORIDA BUILDING CODE (FBC 7TH EDITION (2020) RESIDENTIAL) ACCESSIBILITY CODE, BUILDING, ENERGY CONSERVATION, FUEL GAS, MECHANICAL PLUMBING AND N.E.C. 2017 CODE.

NOTE:

THE DESIGN OF THIS STRUCTURE MEETS A.S.C.E. 7

NOTE:

GENERAL CONTRACTOR IS TO COORDINATE WITH FPL TO HAVE OVERHEAD POWER LINES BURIED PROPOSED FENCE UNDER SEPARATE PERMIT

PROPOSED POOL UNDER SEPARATE PERMIT

INC. NO CHANGE TO THESE DRAWINGS MAY BE MADE WITHOUT A WRITTEN CONSENT FROM THE DESIGNER. UNAUTHORIZED

2. ALL CONSTRUCTION TO BE IN STRICT ACCORDANCE WITH GOVERNING CODES. 3. ALL MANUFACTURED PRODUCTS AND MATERIALS SHALL BE USED IN ACCORDANCE WITH THE MANUFACTURERS SPECIFICATION

4. ALL WORK SHOWN IS NEW UNLESS NOTED "EXIST", "EXISTING", OR "RELOCATED" 5. DO NOT SCALE DRAWINGS. ALL DIMENSIONS ARE TO ROUGH

UNLESS NOTED OTHERWISE. CONTRACTOR TO VERIFY ALL DIMENSIONS AND DETAILS PRIOR TO CONSTRUCTION, NOTIFY DESIGNER OF ALL DISCREPANCIES.

6. VERIFY ALL FLOOR, WALL, AND DECORATIVE FINISHES IF SHOWN ON

THESE PLANS AND SPECIFICATIONS COMPLY. TO THE BEST OF THE DESIGNERS KNOWLEDGE, WITH THE APPLICABLE MINIMUM BUILDING CODES AND FIRE SAFETY STANDARDS AS DETERMINED IN ACCORDANCE WITH CHAPTERS 553 AND 633, LAWS OF FLORIDA, AND APPLICABLE LOCAL CODES AND ORDINANCES. THE GENERAL CONTRACTOR SHALL BE RESPONSIBLE FOR INSURING ALL REQUIRED CODES ARE MET.

SARASOTA COUNTY ZONING INFORMATION

R-4SF

SETBACKS: FRONT- 20', SIDE- MIN. 8' COMBINED 20', REAR- 20'

BUILDING COVERAGE: 30% MAX

IMPERVIOUS COVERAGE: 50% (SKOD)

MAX HEIGHT TO MIDPOINT: 30' FROM DFE

FLOOD ZONE: AE8, 8' N.A.V.D. (BFE) - 9' N.A.V.D. (DFE) DAYLIGHT PLANE: FROM SIDE PROPERTY LINE AT DESIGN FLOOD 9' NAVD (56 DEGREE ANGLE - 80' WIDE LOT)

Plan no.

2021-50 CS1.0

NO. DESCRIP: BY DATE


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SCALE: AS SHOWN


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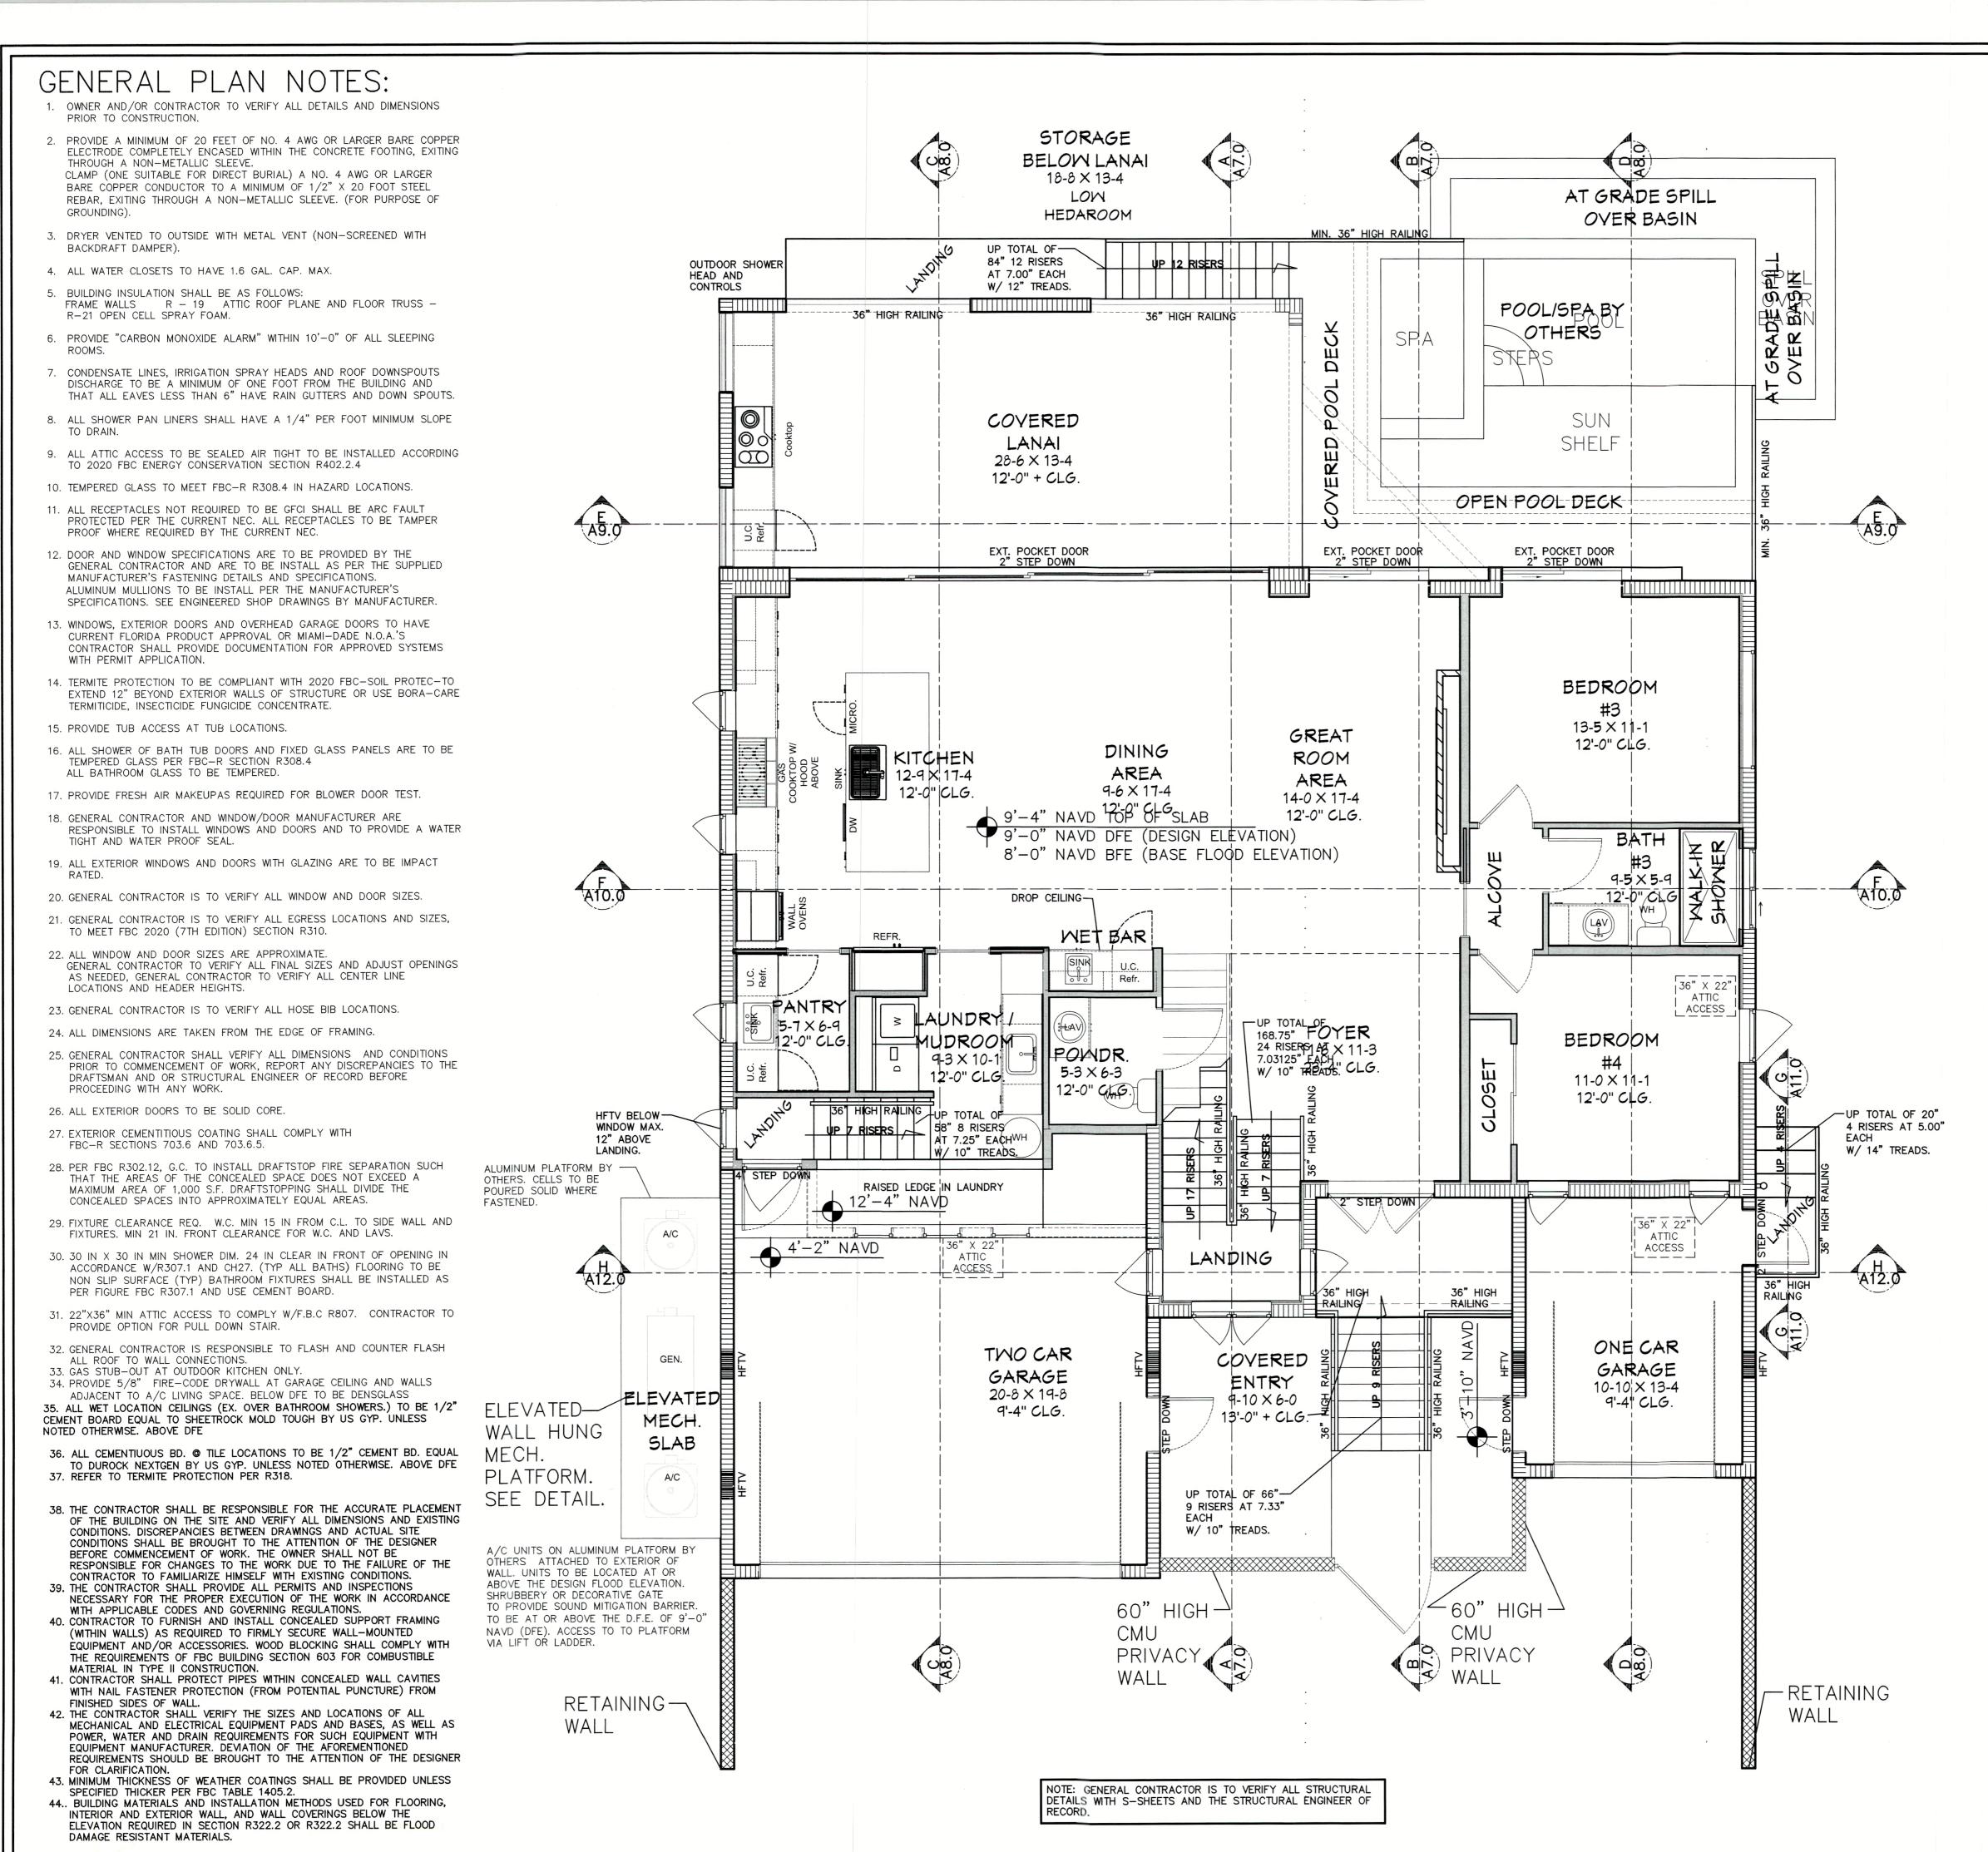
COVER SHEET

SHEET NO. CS1.0



BY DATE

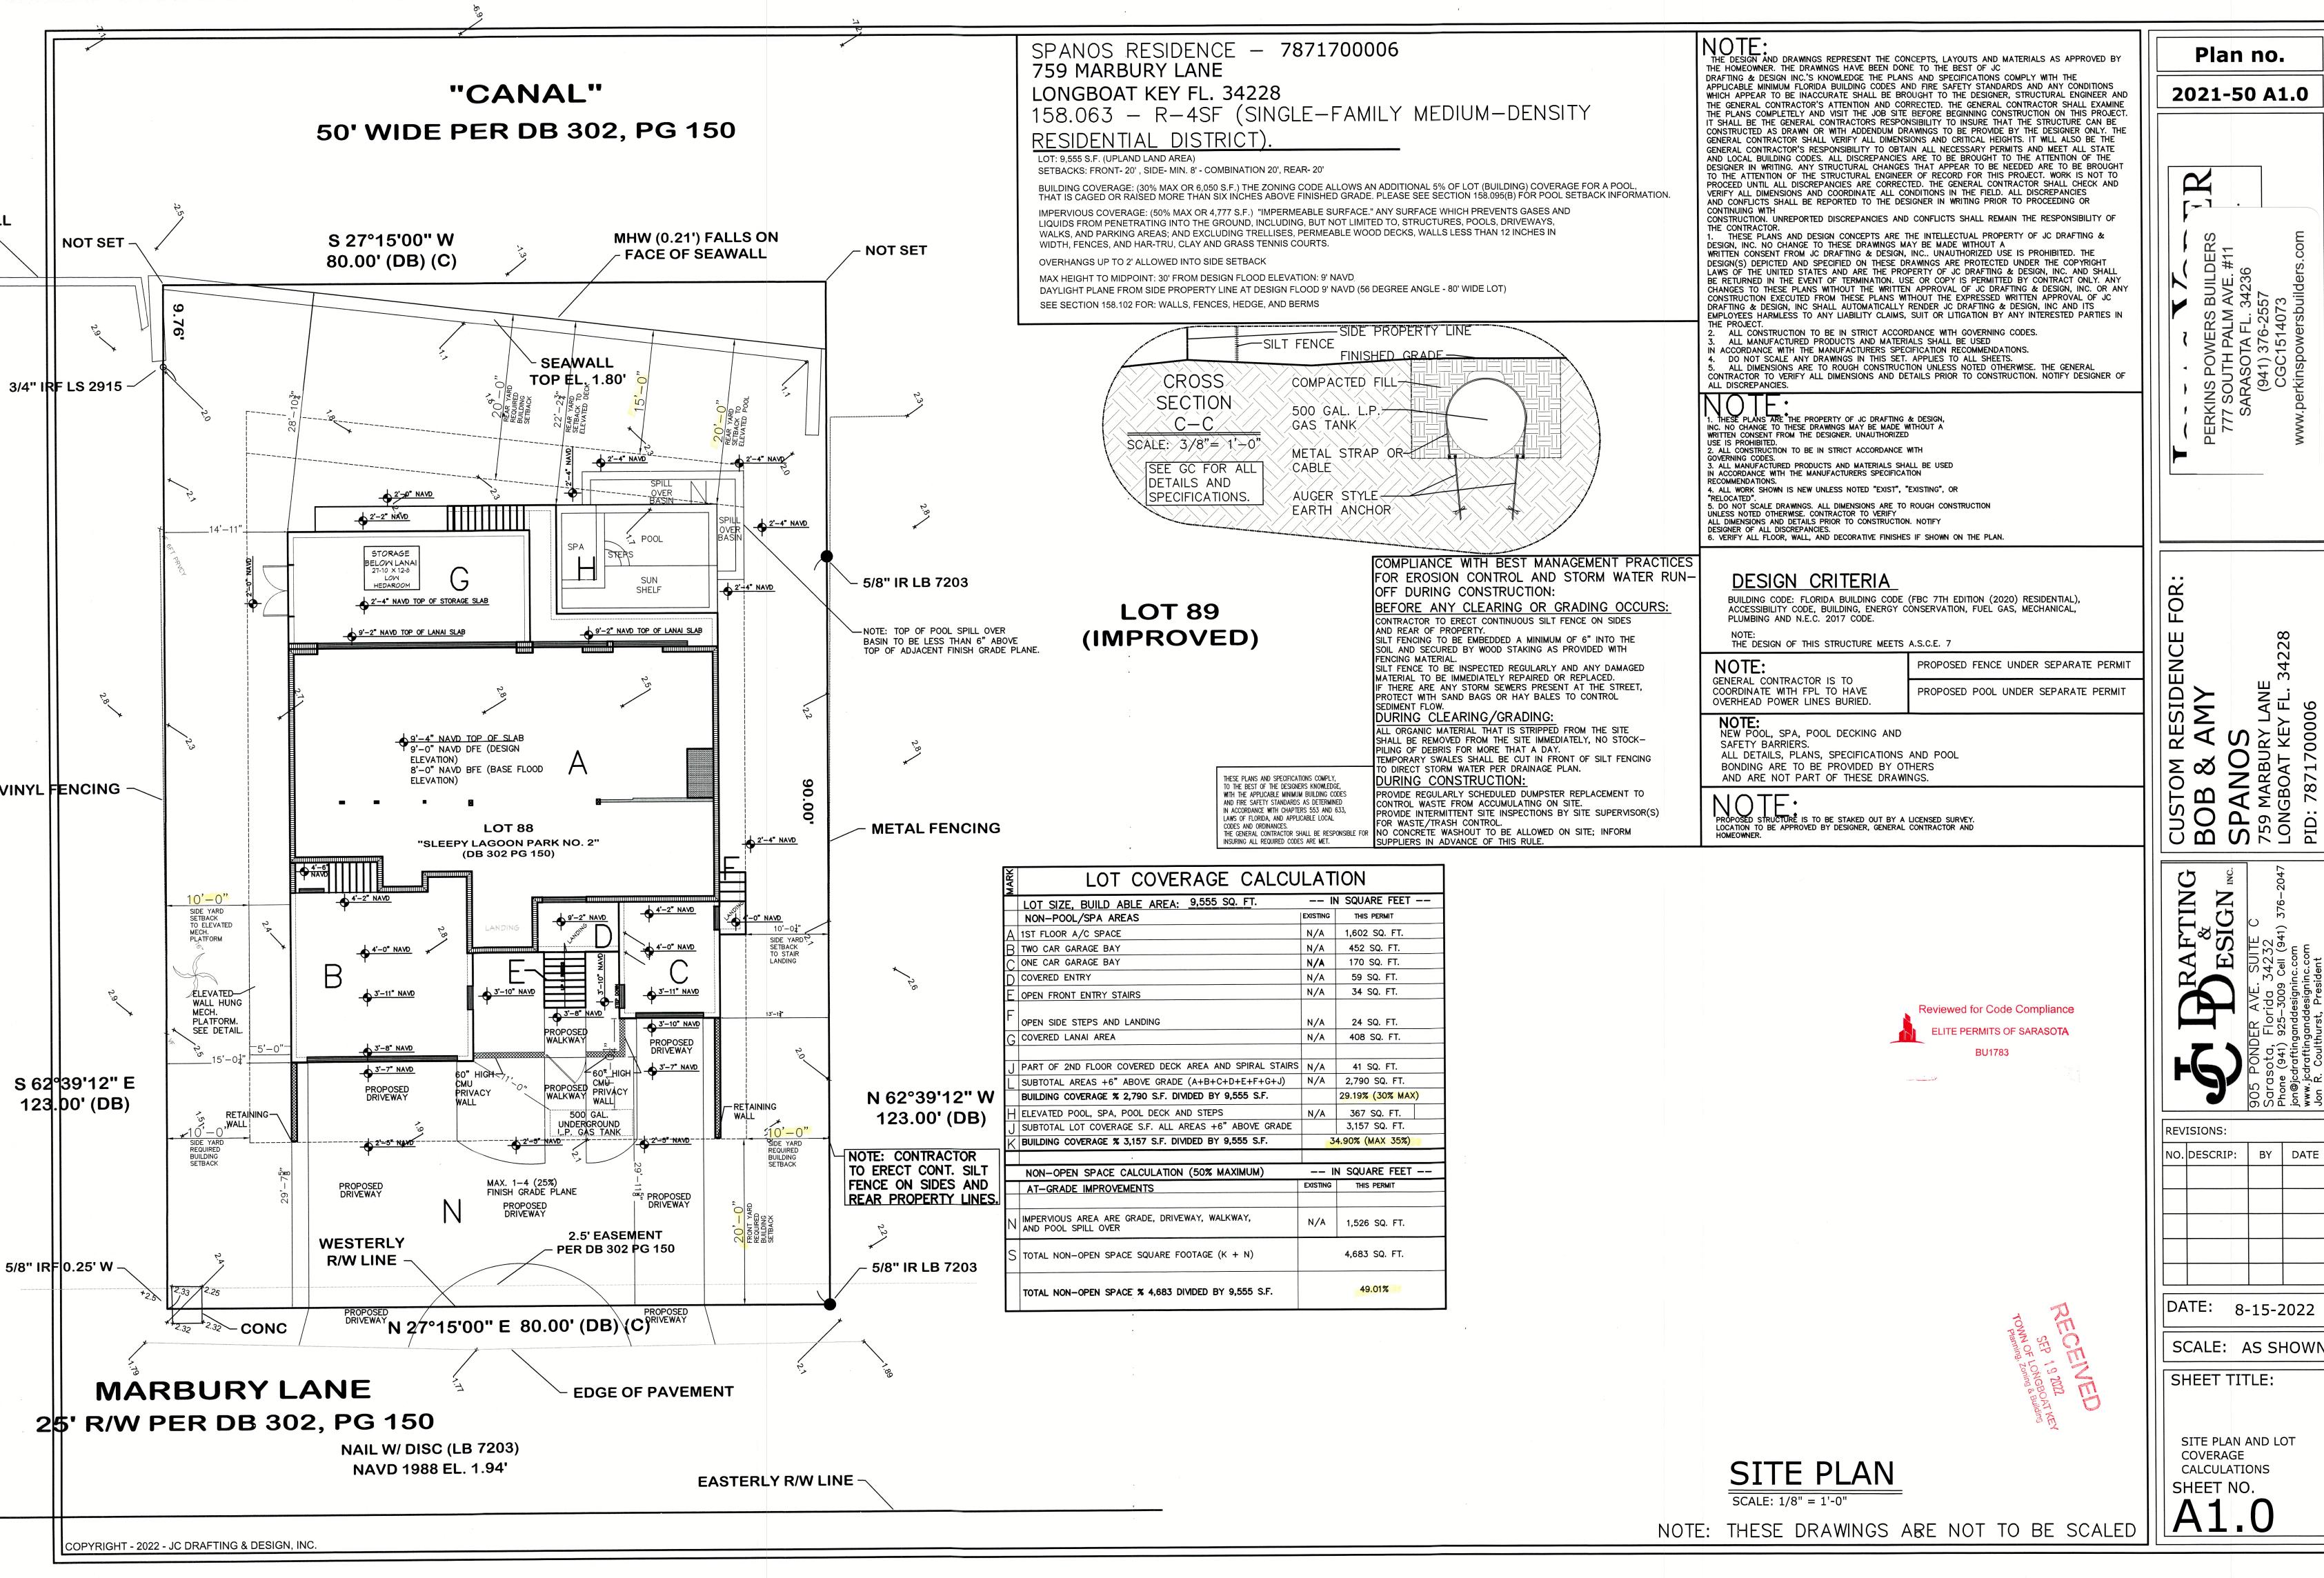

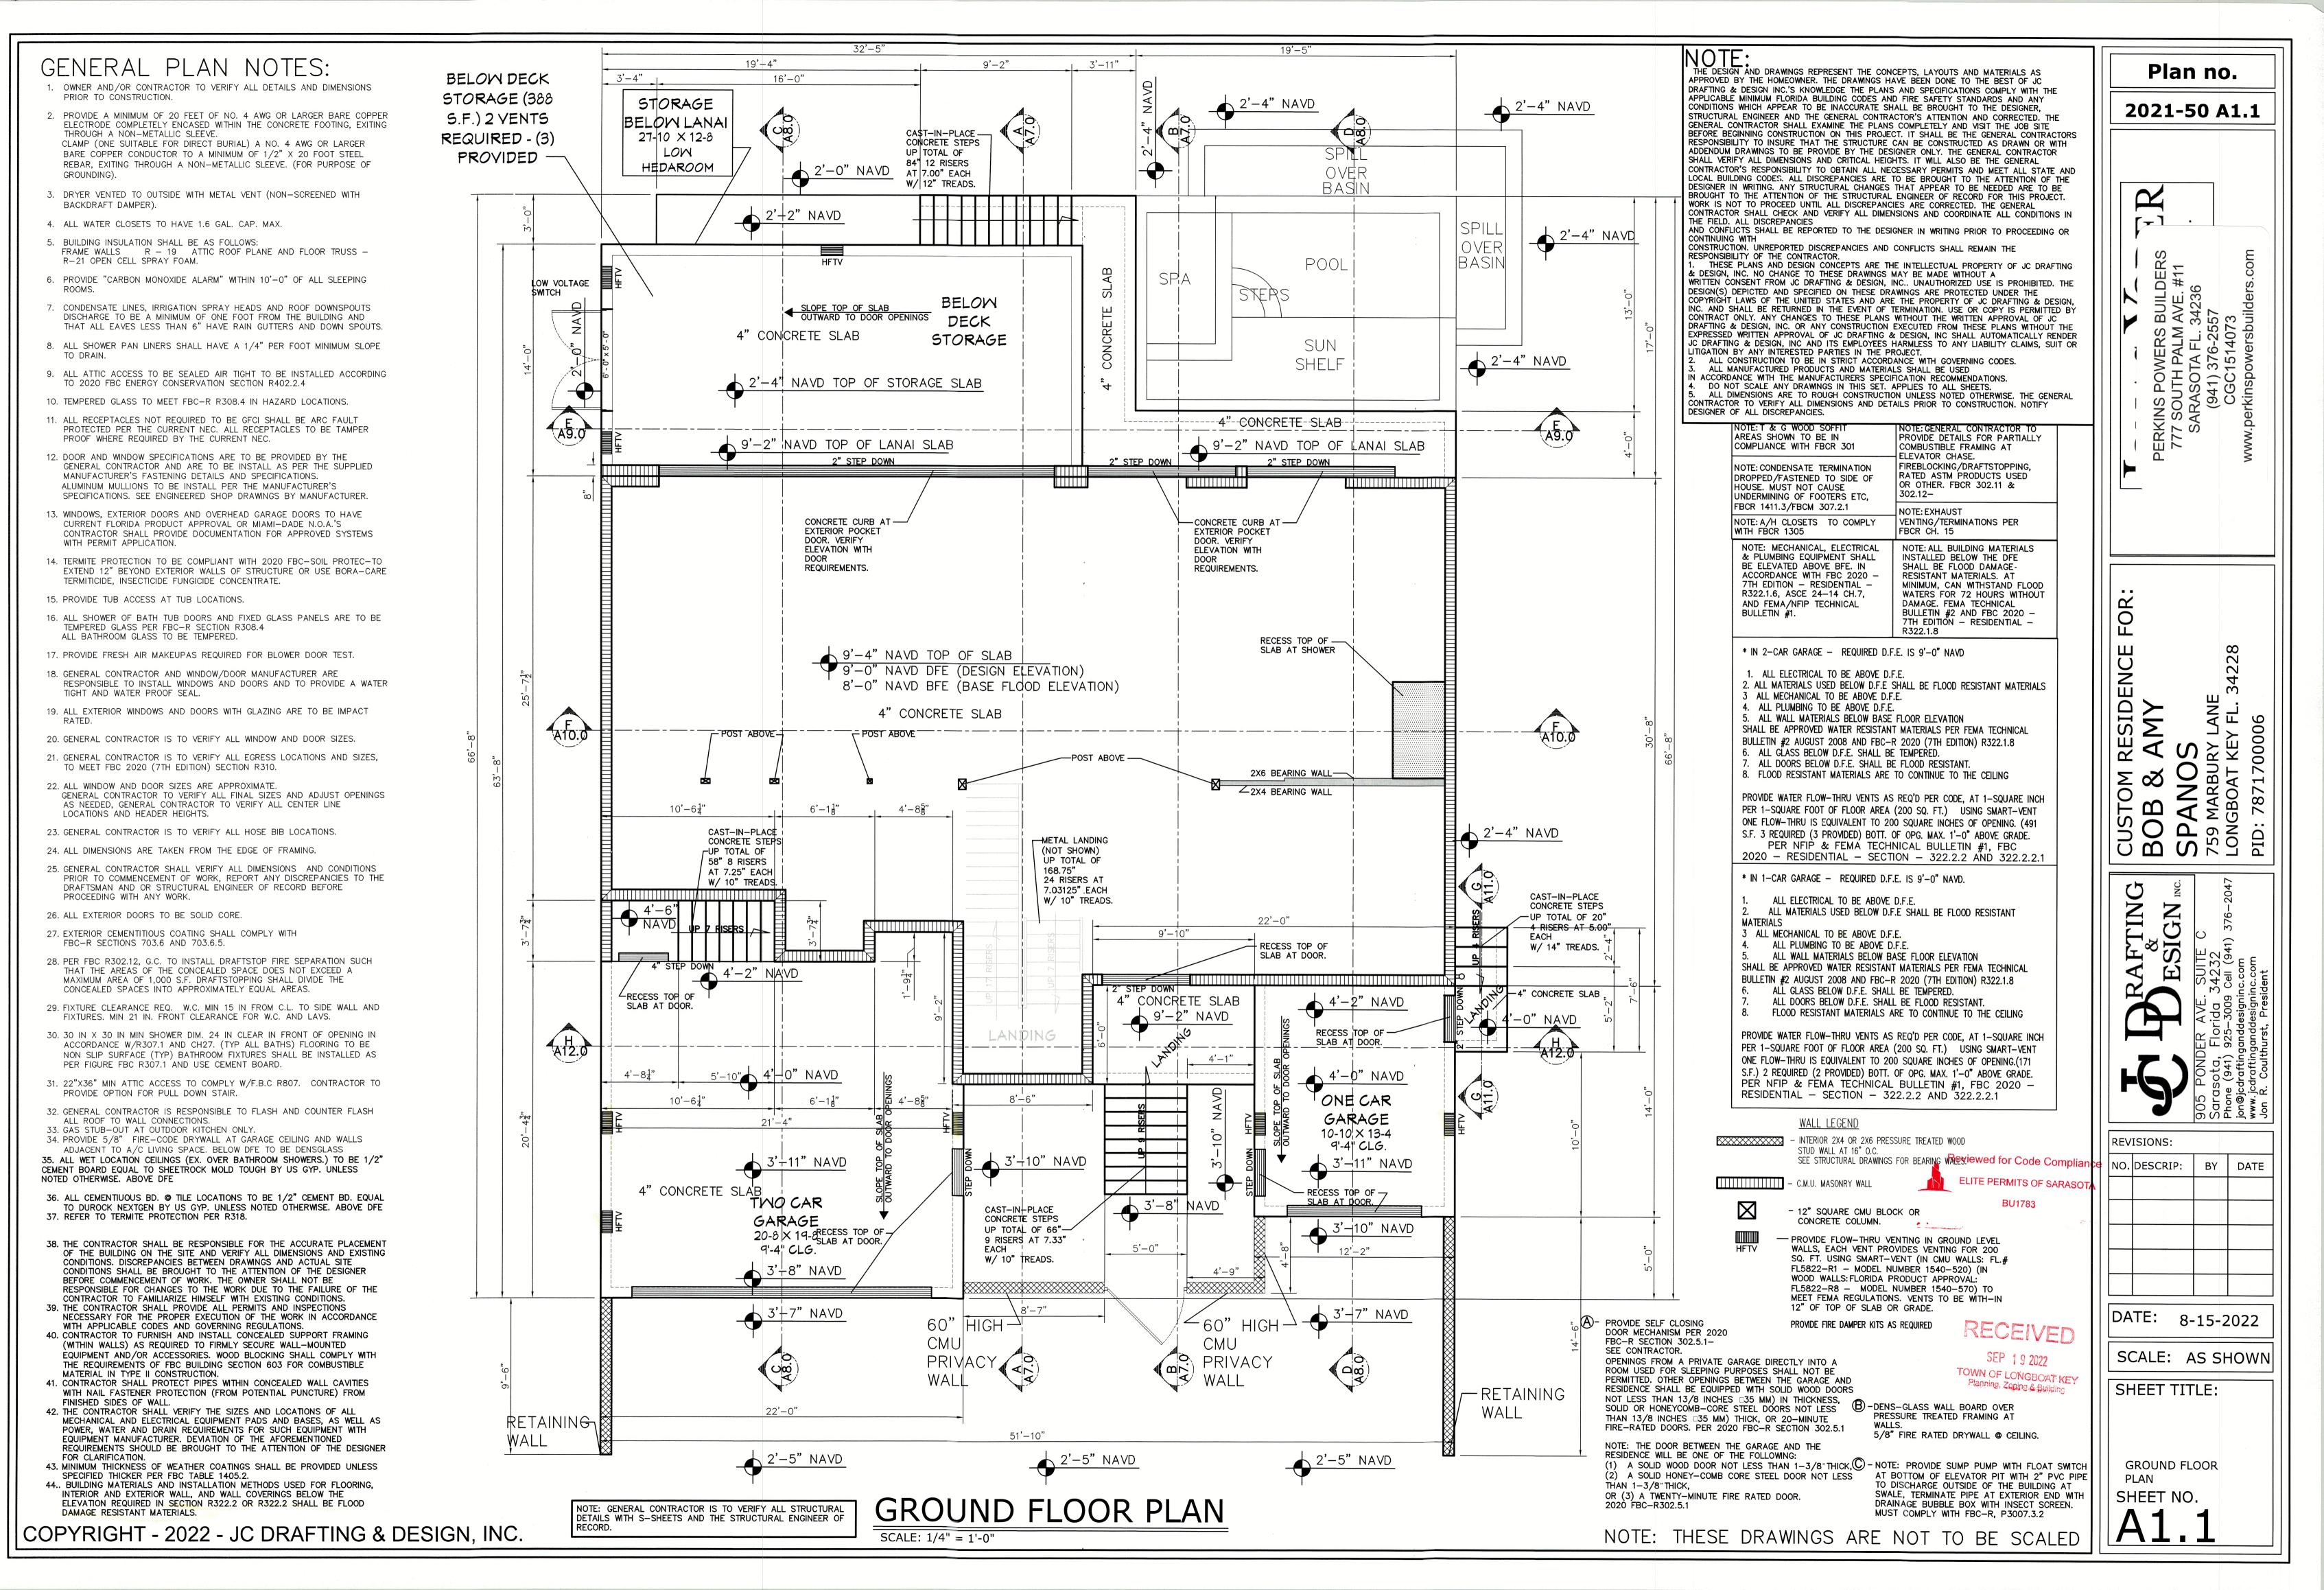

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RESPONSIBILITY OF THE CONTRACTOR. THESE PLANS AND DESIGN CONCEPTS ARE THE INTELLECTUAL PROPERTY OF JC DRAFTING & DESIGN, INC. NO CHANGE TO THESE DRAWINGS MAY BE MADE WITHOUT A WRITTEN CONSENT FROM JC DRAFTING & DESIGN, INC.. UNAUTHORIZED USE IS PROHIBITED. THE DESIGN(S) DEPICTED AND SPECIFIED ON THESE DRAWINGS ARE PROTECTED UNDER THE COPYRIGHT LAWS OF THE UNITED STATES AND ARE THE PROPERTY OF JC DRAFTING & DESIGN, INC. AND SHALL BE RETURNED IN THE EVENT OF TERMINATION. USE OR COPY IS PERMITTED BY CONTRACT ONLY. ANY CHANGES TO THESE PLANS WITHOUT THE WRITTEN APPROVAL OF JC DRAFTING & DESIGN, INC. OR ANY CONSTRUCTION EXECUTED FROM THESE PLANS WITHOUT THE EXPRESSED WRITTEN APPROVAL OF JC DRAFTING & DESIGN, INC SHALL AUTOMATICALLY RENDER C DRAFTING & DESIGN. INC AND ITS EMPLOYEES HARMLESS TO ANY LIABILITY CLAIMS, SUIT OR ITIGATION BY ANY INTERESTED PARTIES IN THE PROJECT.

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FLASHING: EXTERIOR WINDOWS AND DOORS SHALL BE FLASHED IN ACCORDANCE WITH MANUFACTURER'S NOA OR PRODUCT APPROVAL AND / OR INSTALLATION INSTRUCTIONS. IF FLASHING IS NOT ADDRESSED IN EITHER OF THE PREVIOUS NOTED THEN PAN FLASHING SHALL BE PROVIDED. PAN FLASHING SHALL BE SEALED AND SLOPED AS TO DIRECT WATER TO THE SURFACE OF THE EXTERIOR WALL FINISH OR WATER RESISTIVE BARRIER FOR SUBSEQUENT DRAINAGE. OPENINGS USING PAN FLASHING SHALL INCORPORATE FLASHING OR PROTECTION AT THE HEAD AND SIDES.

NOTE: ALL FINAL CABINET AND SHELVING LAYOUTS, DESIGN, DRAWINGS, SPECIFICATIONS & ENGINEERING ARE TO BE PROVIDED BY THE CABINET MAKER AND ARE NOT PART OF THESE DRAWINGS. CONTRACTOR TO COORDINATE WITH CABINET MAKER WITH THE OWNER'S FINAL SELECTION OF ALL APPLIANCES, FIXTURES AND CABINETRY. CABINET MAKER IS RESPONSIBLE FOR ALL REQUIRED FIELD MEASUREMENTS BEFORE, DURING AND AFTER DEMOLITION AND RENOVATION WITH REGARD TO ALL

NOTE: BRAND, STYLE, KIND, COLOR, ETC. OF ALL FINISHES AND MATERIALS, ELECTRICAL FIXTURES. APPLIANCES, EQUIPMENT AS AGREED AND NEGOTIATED BETWEEN OWNER

NOTE: ALL OTHER JOB SPECIFICATION AND FINISH SPECIFICATIONS TO BE FURNISHED TO GENERAL CONTRACTOR BY THE HOME OWNER AND ARE NOT PART OF THESE DRAWINGS.

NOTE: ALL OTHER DETAILS, LAYOUTS, SPECIFICATIONS, PLUMBING, HEATING, VENTILATION, AIR CONDITIONING, ELECTRICAL TO BE SUPPLIED BY SUBCONTRACTORS TO THE GENERAL CONTRACTOR. NOTICE: ALL INFORMATION PROVIDED MUST BE VERIFIED IN FIELD AND ANY MINOR ADJUSTMENTS

ARE TO BE MADE BY CONTRACTOR IN FIELD. ANY STRUCTURAL CHANGES THAT APPEAR TO BE NEEDED MUST BE BROUGHT TO THE ATTENTION OF THE GENERAL CONTRACTOR AND

NOTE: ALL NEW CONSTRUCTION SHALL BE REQUIRED TO PASS THE BLOWER DOOR TEST PER 2020 ENERGY CONSERVATION CODE R402.4 BE AWARE FLOW THRU OPENINGS MAY CREATE SOME ISSUES WHILE PERFORMING THIS TEST.

NOTE: SEE STRUCTURAL SHEETS FOR FINAL BEARING POST LOCATIONS NOTE: ALL CONDENSATE LINES AND ROOF DOWNSPOUTS SHALL DISCHARGE MIN. 12" AWAY FROM STRUCTURE SIDEWALL USING UNDERGROUND PIPING, TAIL EXTENSIONS OR SPLASH BLOCKS NOTE: ALL PLANS ARE TO MEET THE 2020 FBC-R (7TH EDITION AND 2020 FBC ENERGY of Code Com ELITE PERMITS OF SAR/

NOTE: PROVIDE 1" DAPOUT AT ALL EXTERIOR DOOR LOCATIONS NOTE: EXTERIOR WINDOW AND DOOR HEADERS TO BE 8'-0"

UNLESS NOTED OTHERWISE. NOTE: FINAL LOCATION OF HOSE NOTE: CEILINGS EXPOSED TO WIND: CEILINGS EXPOSED TO

WIND TO BE HARDIE BOARD AS SLCT'D ON 1/2" CDX ATTACHED TO BOTTOM CHORD W/ 1-1/2" DRYWALL SCREWS @ 6" O.C. EDGES &

NOTE: ALL TRUSS LAYOUTS, SCHEMATIC AND PROFILES MUST BE PROVIDED TO JC DRAFTING & DESIGN, INC. AND THE STRUCTURAL ENGINEER OF RECORD FOR APPROVAL. WALL LEGEND

- INTERIOR 2X4 OR 2X6 PRESSURE TREATED WOOD STUD WALL AT 16" O.C. SEE STRUCTURAL DRAWINGS FOR BEARING WALLS.

- C.M.U. MASONRY WALL

- INTERIOR WOOD SUPPORT POST SEE S-SHEETS - 12" SQUARE CMU BLOCK OR CONCRETE COLUMN.

- PROVIDE FLOW-THRU VENTING IN GROUND LEVEL WALLS, EACH VENT PROVIDES VENTING FOR 200 SQ. FT. USING SMART-VENT (IN CMU WALLS: FL.# FL5822-R1 - MODEL NUMBER 1540-520) (IN WOOD WALLS: FLORIDA PRODUCT APPROVÁL: FL5822-R8 - MODEL NUMBER 1540-570) TO MEET FEMA REGULATIONS. VENTS TO BE WITH-IN 12" OF TOP OF SLAB OR GRADE.

FIRST FLOOR PLAN

PROVIDE FIRE DAMPER KITS AS REQUIRED

SCALE: 1/4" = 1'-0"

DATE: 8-15-2022 SCALE: AS SHOWN SHEET TITLE: FIRST FLOOR PLAN SHEET NO. NOTE: THESE DRAWINGS ARE NOT TO BE SCALED

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SZ ALL CONSTRUCTION TO BE IN STRICT ACCORDANCE WITH GOVERNING CODES. NOTE: IN ACCORDANCE WITH FBC R703.8

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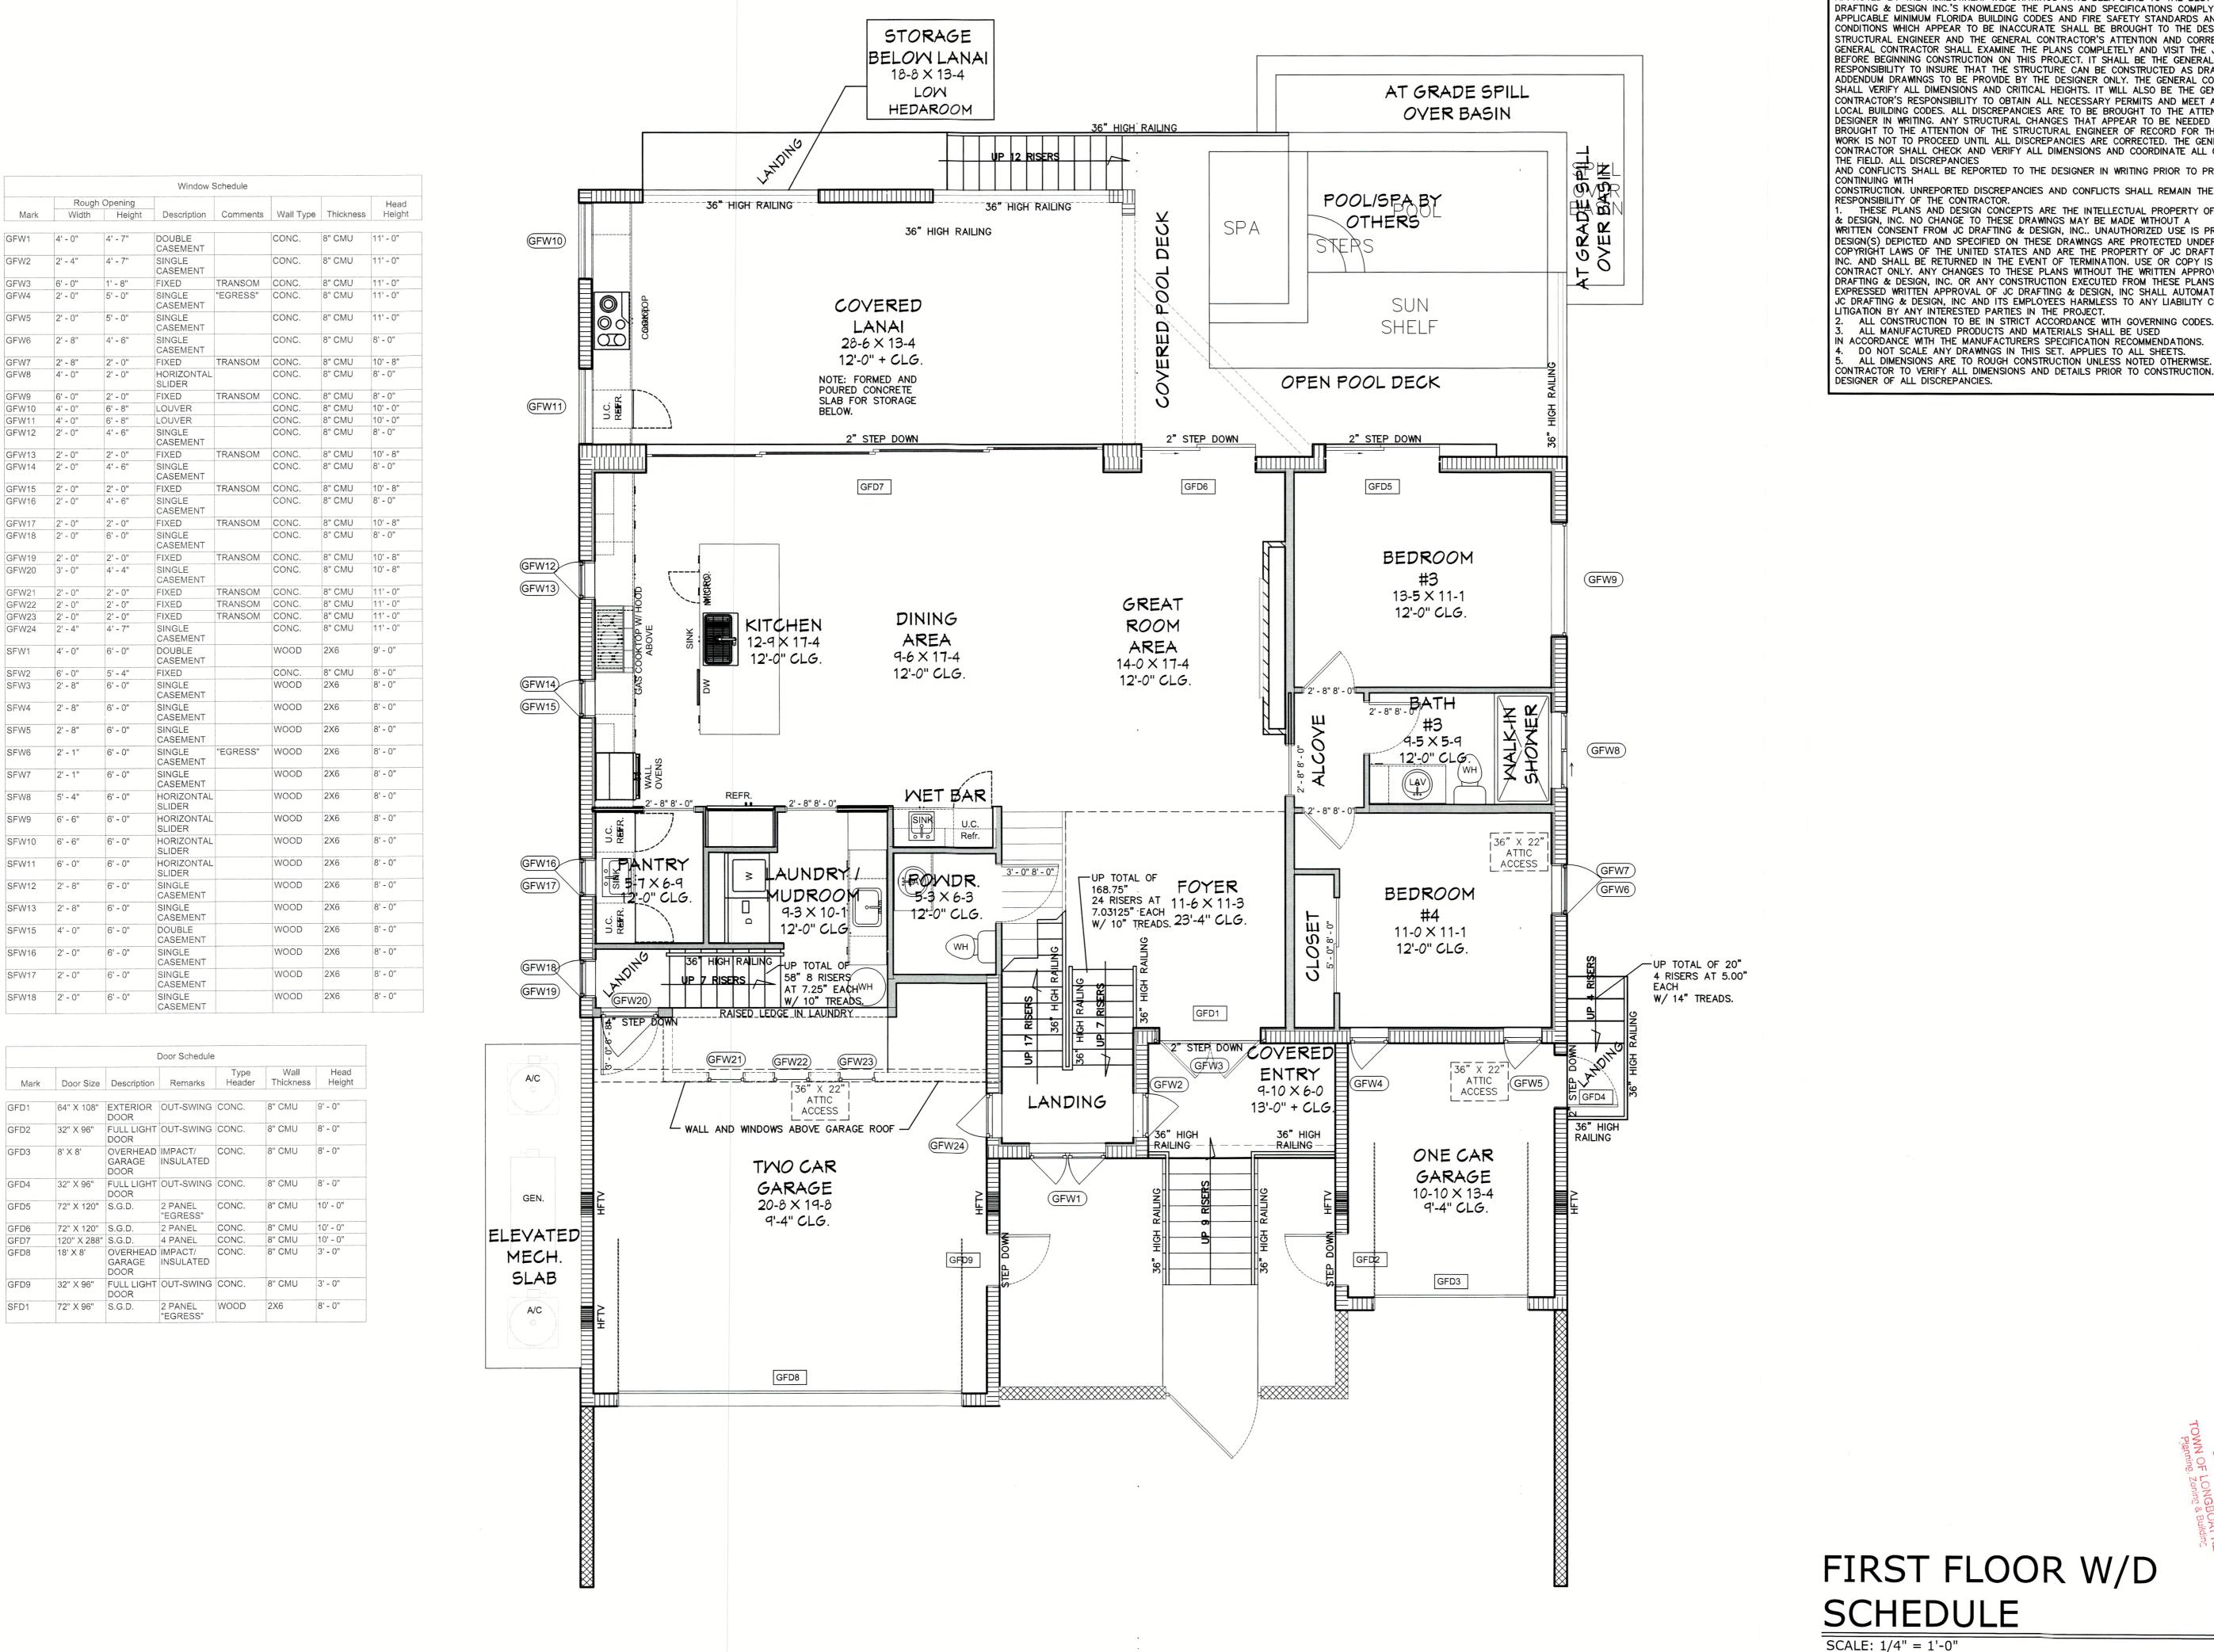
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Plan no.

2021-50 A2.2

PERKINS POWERS BUILDER
777 SOUTH PALM AVE. #11
SARASOTA FL. 34236
(941) 376-2557
CGC1514073

RE CUS BO SP/ 759 N LONG

REVISIONS: NO. DESCRIP: BY DATE

DATE: 8-15-2022

SCALE: AS SHOWN

SHEET TITLE:

FIRST FLOOR W/D SCHEDULE

SHEET NO.

FIRST FLOOR W/D SCHEDULE

NOTE: THESE DRAWINGS ARE NOT TO BE SCALED

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4' - 0"


GFW10 4' - 0"

GFW16 2' - 0"

GFW22 2' - 0"

GFW23 2' - 0"

2' - 8"

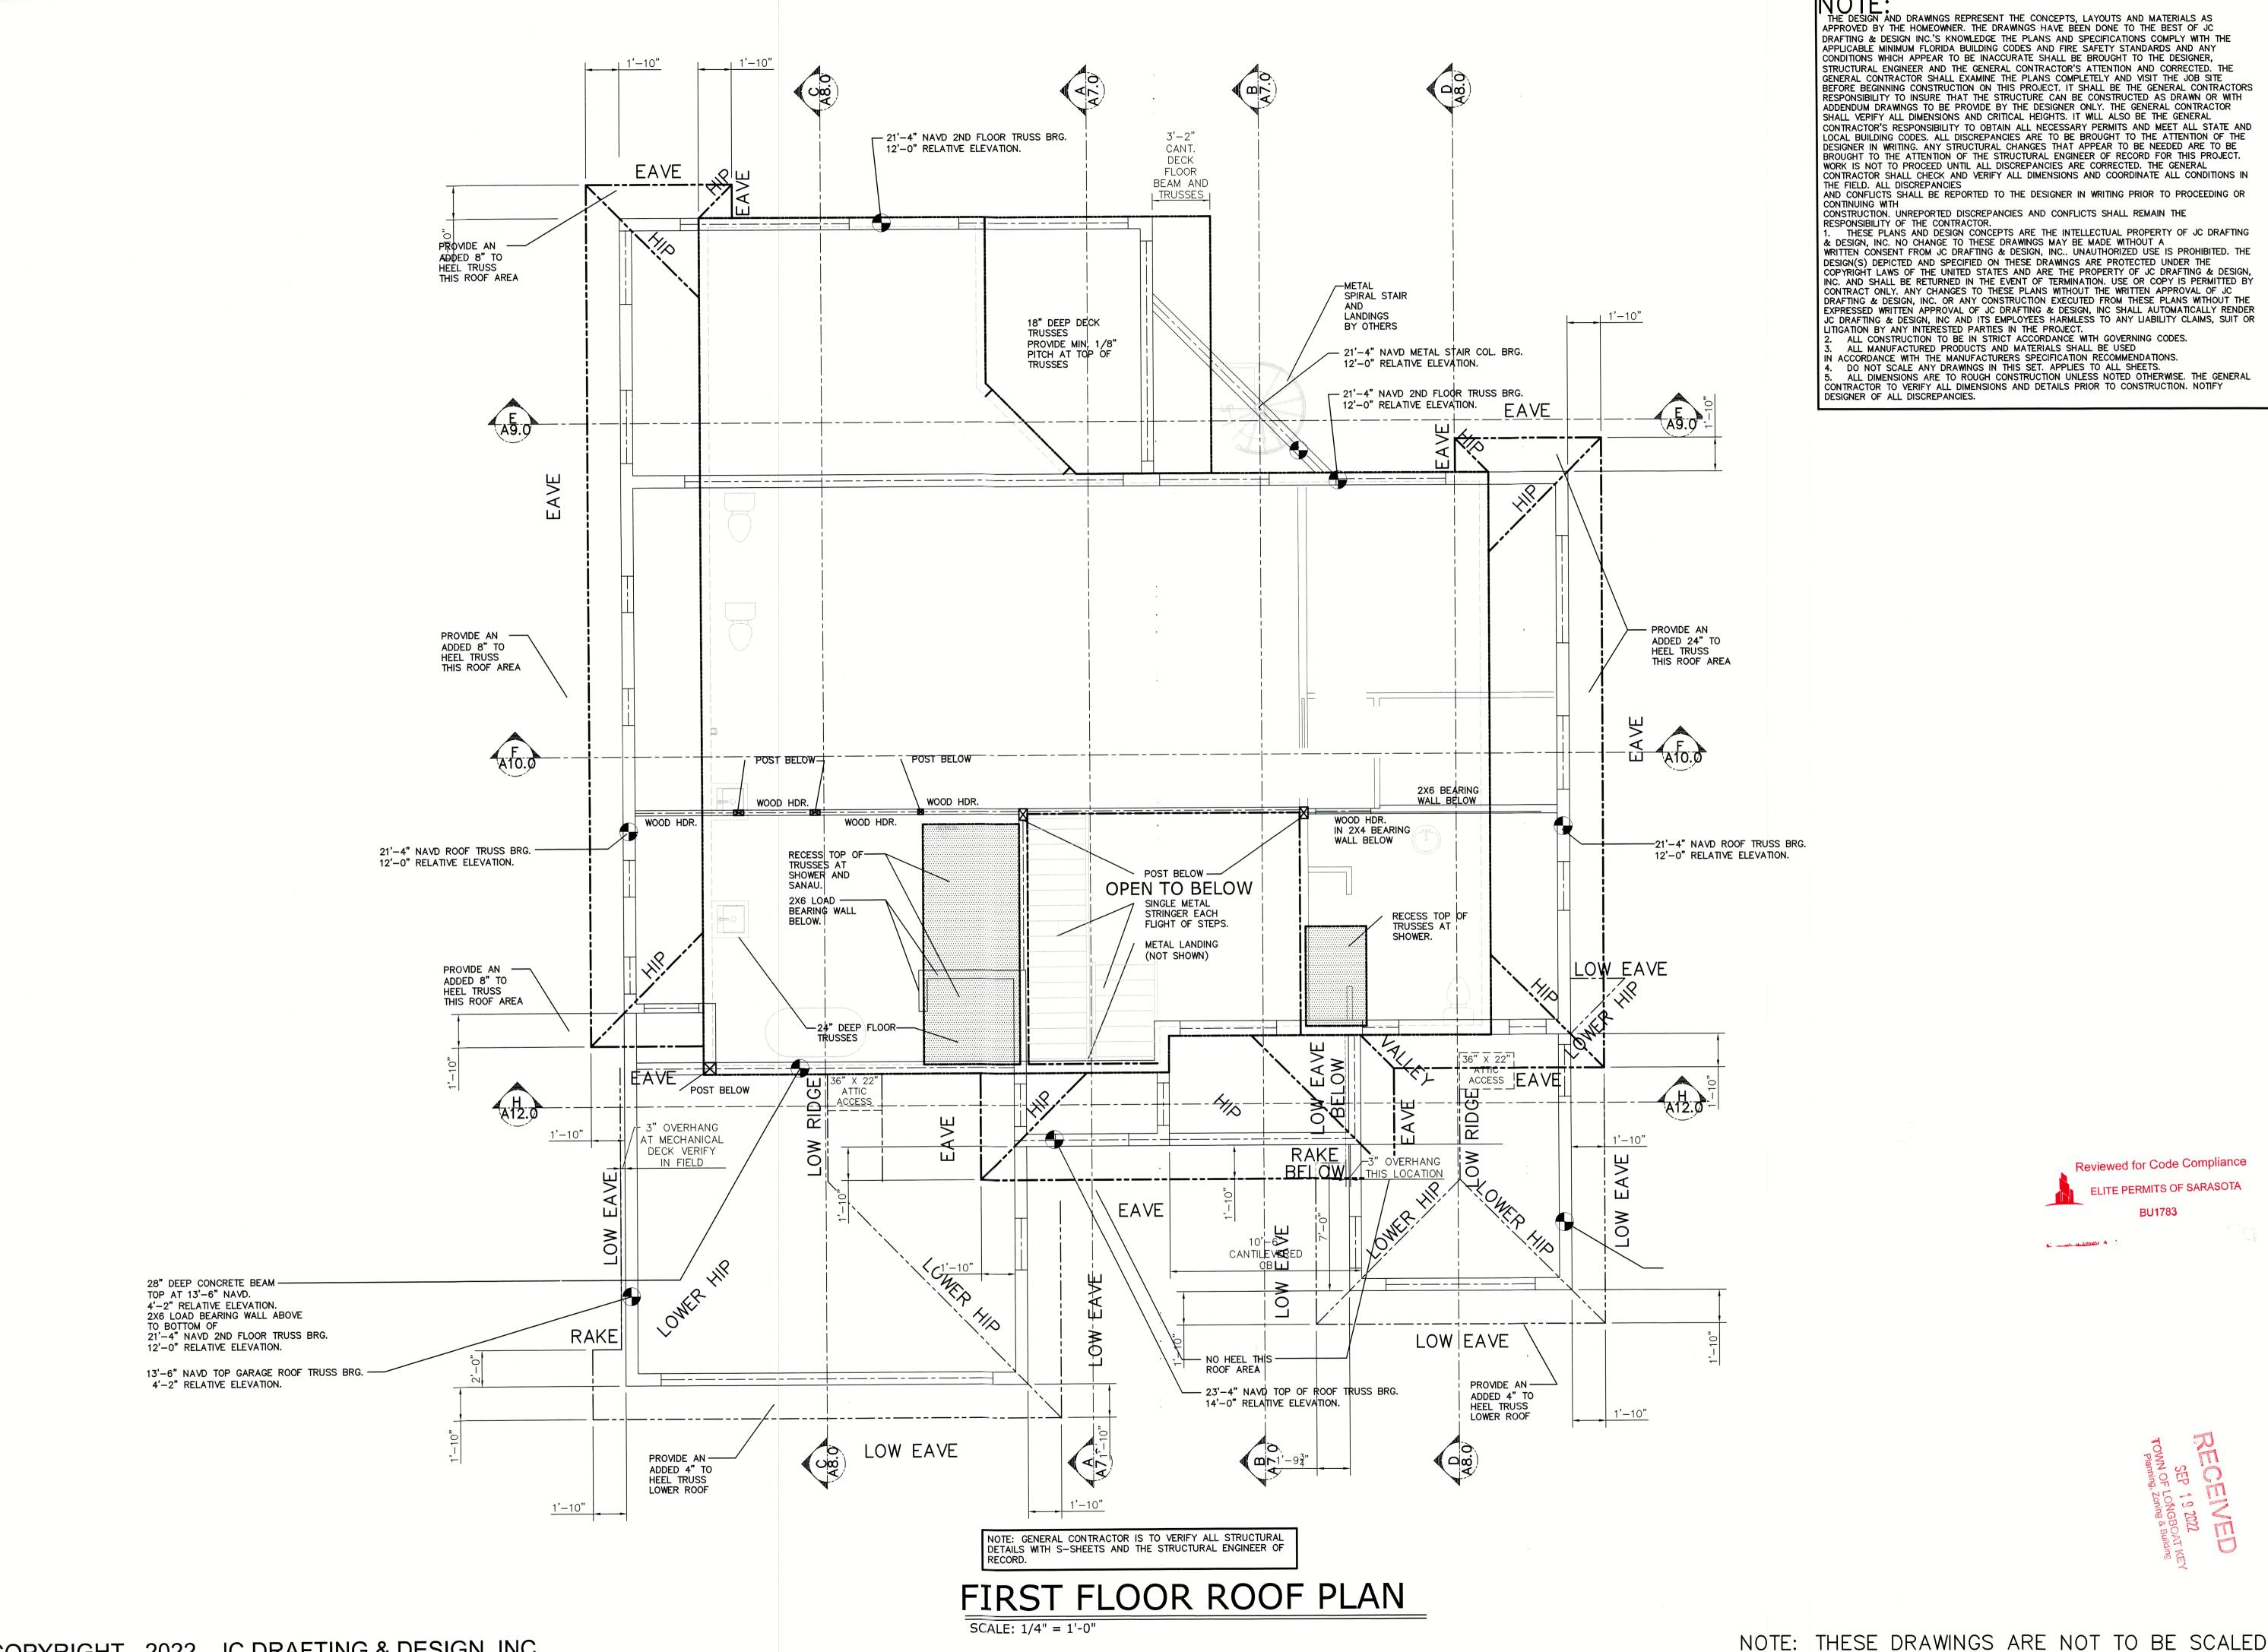

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> Reviewed for Code Compliance ELITE PERMITS OF SARASOTA



Plan no.

2021-50 A2.3

CUS **BO** SP 108

REVISIONS: NO. DESCRIP: BY DATE

DATE: 8-15-2022


SCALE: AS SHOWN

SHEET TITLE:

FIRST FLOOR ROOF

GENERAL PLAN NOTES:

- 1. OWNER AND/OR CONTRACTOR TO VERIFY ALL DETAILS AND DIMENSIONS
- 2. PROVIDE A MINIMUM OF 20 FEET OF NO. 4 AWG OR LARGER BARE COPPER ELECTRODE COMPLETELY ENCASED WITHIN THE CONCRETE FOOTING, EXITING THROUGH A NON-METALLIC SLEEVE. CLAMP (ONE SUITABLE FOR DIRECT BURIAL) A NO. 4 AWG OR LARGER BARE COPPER CONDUCTOR TO A MINIMUM OF 1/2" X 20 FOOT STEEL REBAR, EXITING THROUGH A NON-METALLIC SLEEVE. (FOR PURPOSE OF
- 3. DRYER VENTED TO OUTSIDE WITH METAL VENT (NON-SCREENED WITH BACKDRAFT DAMPER).
- 4. ALL WATER CLOSETS TO HAVE 1.6 GAL. CAP. MAX.
- 5. BUILDING INSULATION SHALL BE AS FOLLOWS: FRAME WALLS R - 19 ATTIC ROOF PLANE AND FLOOR TRUSS -R-21 OPEN CELL SPRAY FOAM.
- 6. PROVIDE "CARBON MONOXIDE ALARM" WITHIN 10'-0" OF ALL SLEEPING
- 7. CONDENSATE LINES, IRRIGATION SPRAY HEADS AND ROOF DOWNSPOUTS DISCHARGE TO BE A MINIMUM OF ONE FOOT FROM THE BUILDING AND THAT ALL EAVES LESS THAN 6" HAVE RAIN GUTTERS AND DOWN SPOUTS.
- 8. ALL SHOWER PAN LINERS SHALL HAVE A 1/4" PER FOOT MINIMUM SLOPE
- 9. ALL ATTIC ACCESS TO BE SEALED AIR TIGHT TO BE INSTALLED ACCORDING TO 2020 FBC ENERGY CONSERVATION SECTION R402.2.4
- 10. TEMPERED GLASS TO MEET FBC-R R308.4 IN HAZARD LOCATIONS.
- 11. ALL RECEPTACLES NOT REQUIRED TO BE GFCI SHALL BE ARC FAULT PROTECTED PER THE CURRENT NEC. ALL RECEPTACLES TO BE TAMPER PROOF WHERE REQUIRED BY THE CURRENT NEC.
- 12. DOOR AND WINDOW SPECIFICATIONS ARE TO BE PROVIDED BY THE GENERAL CONTRACTOR AND ARE TO BE INSTALL AS PER THE SUPPLIED MANUFACTURER'S FASTENING DETAILS AND SPECIFICATIONS. ALUMINUM MULLIONS TO BE INSTALL PER THE MANUFACTURER'S SPECIFICATIONS. SEE ENGINEERED SHOP DRAWINGS BY MANUFACTURER.
- 13. WINDOWS, EXTERIOR DOORS AND OVERHEAD GARAGE DOORS TO HAVE CURRENT FLORIDA PRODUCT APPROVAL OR MIAMI-DADE N.O.A.'S CONTRACTOR SHALL PROVIDE DOCUMENTATION FOR APPROVED SYSTEMS
- 14. TERMITE PROTECTION TO BE COMPLIANT WITH 2020 FBC-SOIL PROTEC-TO EXTEND 12" BEYOND EXTERIOR WALLS OF STRUCTURE OR USE BORA-CARE TERMITICIDE, INSECTICIDE FUNGICIDE CONCENTRATE.
- 15. PROVIDE TUB ACCESS AT TUB LOCATIONS.
- 16. ALL SHOWER OF BATH TUB DOORS AND FIXED GLASS PANELS ARE TO BE TEMPERED GLASS PER FBC-R SECTION R308.4 ALL BATHROOM GLASS TO BE TEMPERED.
- 17. PROVIDE FRESH AIR MAKEUPAS REQUIRED FOR BLOWER DOOR TEST.
- 18. GENERAL CONTRACTOR AND WINDOW/DOOR MANUFACTURER ARE RESPONSIBLE TO INSTALL WINDOWS AND DOORS AND TO PROVIDE A WATER TIGHT AND WATER PROOF SEAL.
- 19. ALL EXTERIOR WINDOWS AND DOORS WITH GLAZING ARE TO BE IMPACT
- 20. GENERAL CONTRACTOR IS TO VERIFY ALL WINDOW AND DOOR SIZES.
- 21. GENERAL CONTRACTOR IS TO VERIFY ALL EGRESS LOCATIONS AND SIZES, TO MEET FBC 2020 (7TH EDITION) SECTION R310.
- 22. ALL WINDOW AND DOOR SIZES ARE APPROXIMATE. GENERAL CONTRACTOR TO VERIFY ALL FINAL SIZES AND ADJUST OPENINGS AS NEEDED, GENERAL CONTRACTOR TO VERIFY ALL CENTER LINE LOCATIONS AND HEADER HEIGHTS.
- 23. GENERAL CONTRACTOR IS TO VERIFY ALL HOSE BIB LOCATIONS.
- 24. ALL DIMENSIONS ARE TAKEN FROM THE EDGE OF FRAMING.
- 25. GENERAL CONTRACTOR SHALL VERIFY ALL DIMENSIONS AND CONDITIONS PRIOR TO COMMENCEMENT OF WORK, REPORT ANY DISCREPANCIES TO THE DRAFTSMAN AND OR STRUCTURAL ENGINEER OF RECORD BEFORE
- 26. ALL EXTERIOR DOORS TO BE SOLID CORE.
- 27. EXTERIOR CEMENTITIOUS COATING SHALL COMPLY WITH FBC-R SECTIONS 703.6 AND 703.6.5.
- 28. PER FBC R302.12, G.C. TO INSTALL DRAFTSTOP FIRE SEPARATION SUCH THAT THE AREAS OF THE CONCEALED SPACE DOES NOT EXCEED A MAXIMUM AREA OF 1,000 S.F. DRAFTSTOPPING SHALL DIVIDE THE CONCEALED SPACES INTO APPROXIMATELY EQUAL AREAS.
- 29. FIXTURE CLEARANCE REQ. W.C. MIN 15 IN FROM C.L. TO SIDE WALL AND FIXTURES, MIN 21 IN. FRONT CLEARANCE FOR W.C. AND LAVS.
- 30. 30 IN X 30 IN MIN SHOWER DIM. 24 IN CLEAR IN FRONT OF OPENING IN ACCORDANCE W/R307.1 AND CH27. (TYP ALL BATHS) FLOORING TO BE NON SLIP SURFACE (TYP) BATHROOM FIXTURES SHALL BE INSTALLED AS PER FIGURE FBC R307.1 AND USE CEMENT BOARD.
- 31. 22"X36" MIN ATTIC ACCESS TO COMPLY W/F.B.C R807. CONTRACTOR TO PROVIDE OPTION FOR PULL DOWN STAIR.
- 32. GENERAL CONTRACTOR IS RESPONSIBLE TO FLASH AND COUNTER FLASH
- ALL ROOF TO WALL CONNECTIONS. 33. GAS STUB-OUT AT OUTDOOR KITCHEN ONLY.
- 34. PROVIDE 5/8" FIRE-CODE DRYWALL AT GARAGE CEILING AND WALLS ADJACENT TO A/C LIVING SPACE. BELOW DFE TO BE DENSGLASS 35. ALL WET LOCATION CEILINGS (EX. OVER BATHROOM SHOWERS.) TO BE 1/2" CEMENT BOARD EQUAL TO SHEETROCK MOLD TOUGH BY US GYP. UNLESS NOTED OTHERWISE. ABOVE DFE
- 36. ALL CEMENTIUOUS BD. @ TILE LOCATIONS TO BE 1/2" CEMENT BD. EQUAL TO DUROCK NEXTGEN BY US GYP. UNLESS NOTED OTHERWISE. ABOVE DFE 37. REFER TO TERMITE PROTECTION PER R318.
- 38. THE CONTRACTOR SHALL BE RESPONSIBLE FOR THE ACCURATE PLACEMENT OF THE BUILDING ON THE SITE AND VERIFY ALL DIMENSIONS AND EXISTING CONDITIONS. DISCREPANCIES BETWEEN DRAWINGS AND ACTUAL SITE CONDITIONS SHALL BE BROUGHT TO THE ATTENTION OF THE DESIGNER BEFORE COMMENCEMENT OF WORK. THE OWNER SHALL NOT BE RESPONSIBLE FOR CHANGES TO THE WORK DUE TO THE FAILURE OF THE
- CONTRACTOR TO FAMILIARIZE HIMSELF WITH EXISTING CONDITIONS. 39. THE CONTRACTOR SHALL PROVIDE ALL PERMITS AND INSPECTIONS NECESSARY FOR THE PROPER EXECUTION OF THE WORK IN ACCORDANCE WITH APPLICABLE CODES AND GOVERNING REGULATIONS.
- 40. CONTRACTOR TO FURNISH AND INSTALL CONCEALED SUPPORT FRAMING (WITHIN WALLS) AS REQUIRED TO FIRMLY SECURE WALL-MOUNTED EQUIPMENT AND/OR ACCESSORIES. WOOD BLOCKING SHALL COMPLY WITH THE REQUIREMENTS OF FBC BUILDING SECTION 603 FOR COMBUSTIBLE
- MATERIAL IN TYPE II CONSTRUCTION. 41. CONTRACTOR SHALL PROTECT PIPES WITHIN CONCEALED WALL CAVITIES WITH NAIL FASTENER PROTECTION (FROM POTENTIAL PUNCTURE) FROM FINISHED SIDES OF WALL.
- 42. THE CONTRACTOR SHALL VERIFY THE SIZES AND LOCATIONS OF ALL MECHANICAL AND ELECTRICAL EQUIPMENT PADS AND BASES, AS WELL AS POWER, WATER AND DRAIN REQUIREMENTS FOR SUCH EQUIPMENT WITH EQUIPMENT MANUFACTURER. DEVIATION OF THE AFOREMENTIONED REQUIREMENTS SHOULD BE BROUGHT TO THE ATTENTION OF THE DESIGNER FOR CLARIFICATION.
- 43. MINIMUM THICKNESS OF WEATHER COATINGS SHALL BE PROVIDED UNLESS SPECIFIED THICKER PER FBC TABLE 1405.2. 44. BUILDING MATERIALS AND INSTALLATION METHODS USED FOR FLOORING, INTERIOR AND EXTERIOR WALL, AND WALL COVERINGS BELOW THE ELEVATION REQUIRED IN SECTION R322.2 OR R322.2 SHALL BE FLOOD DAMAGE RESISTANT MATERIALS.

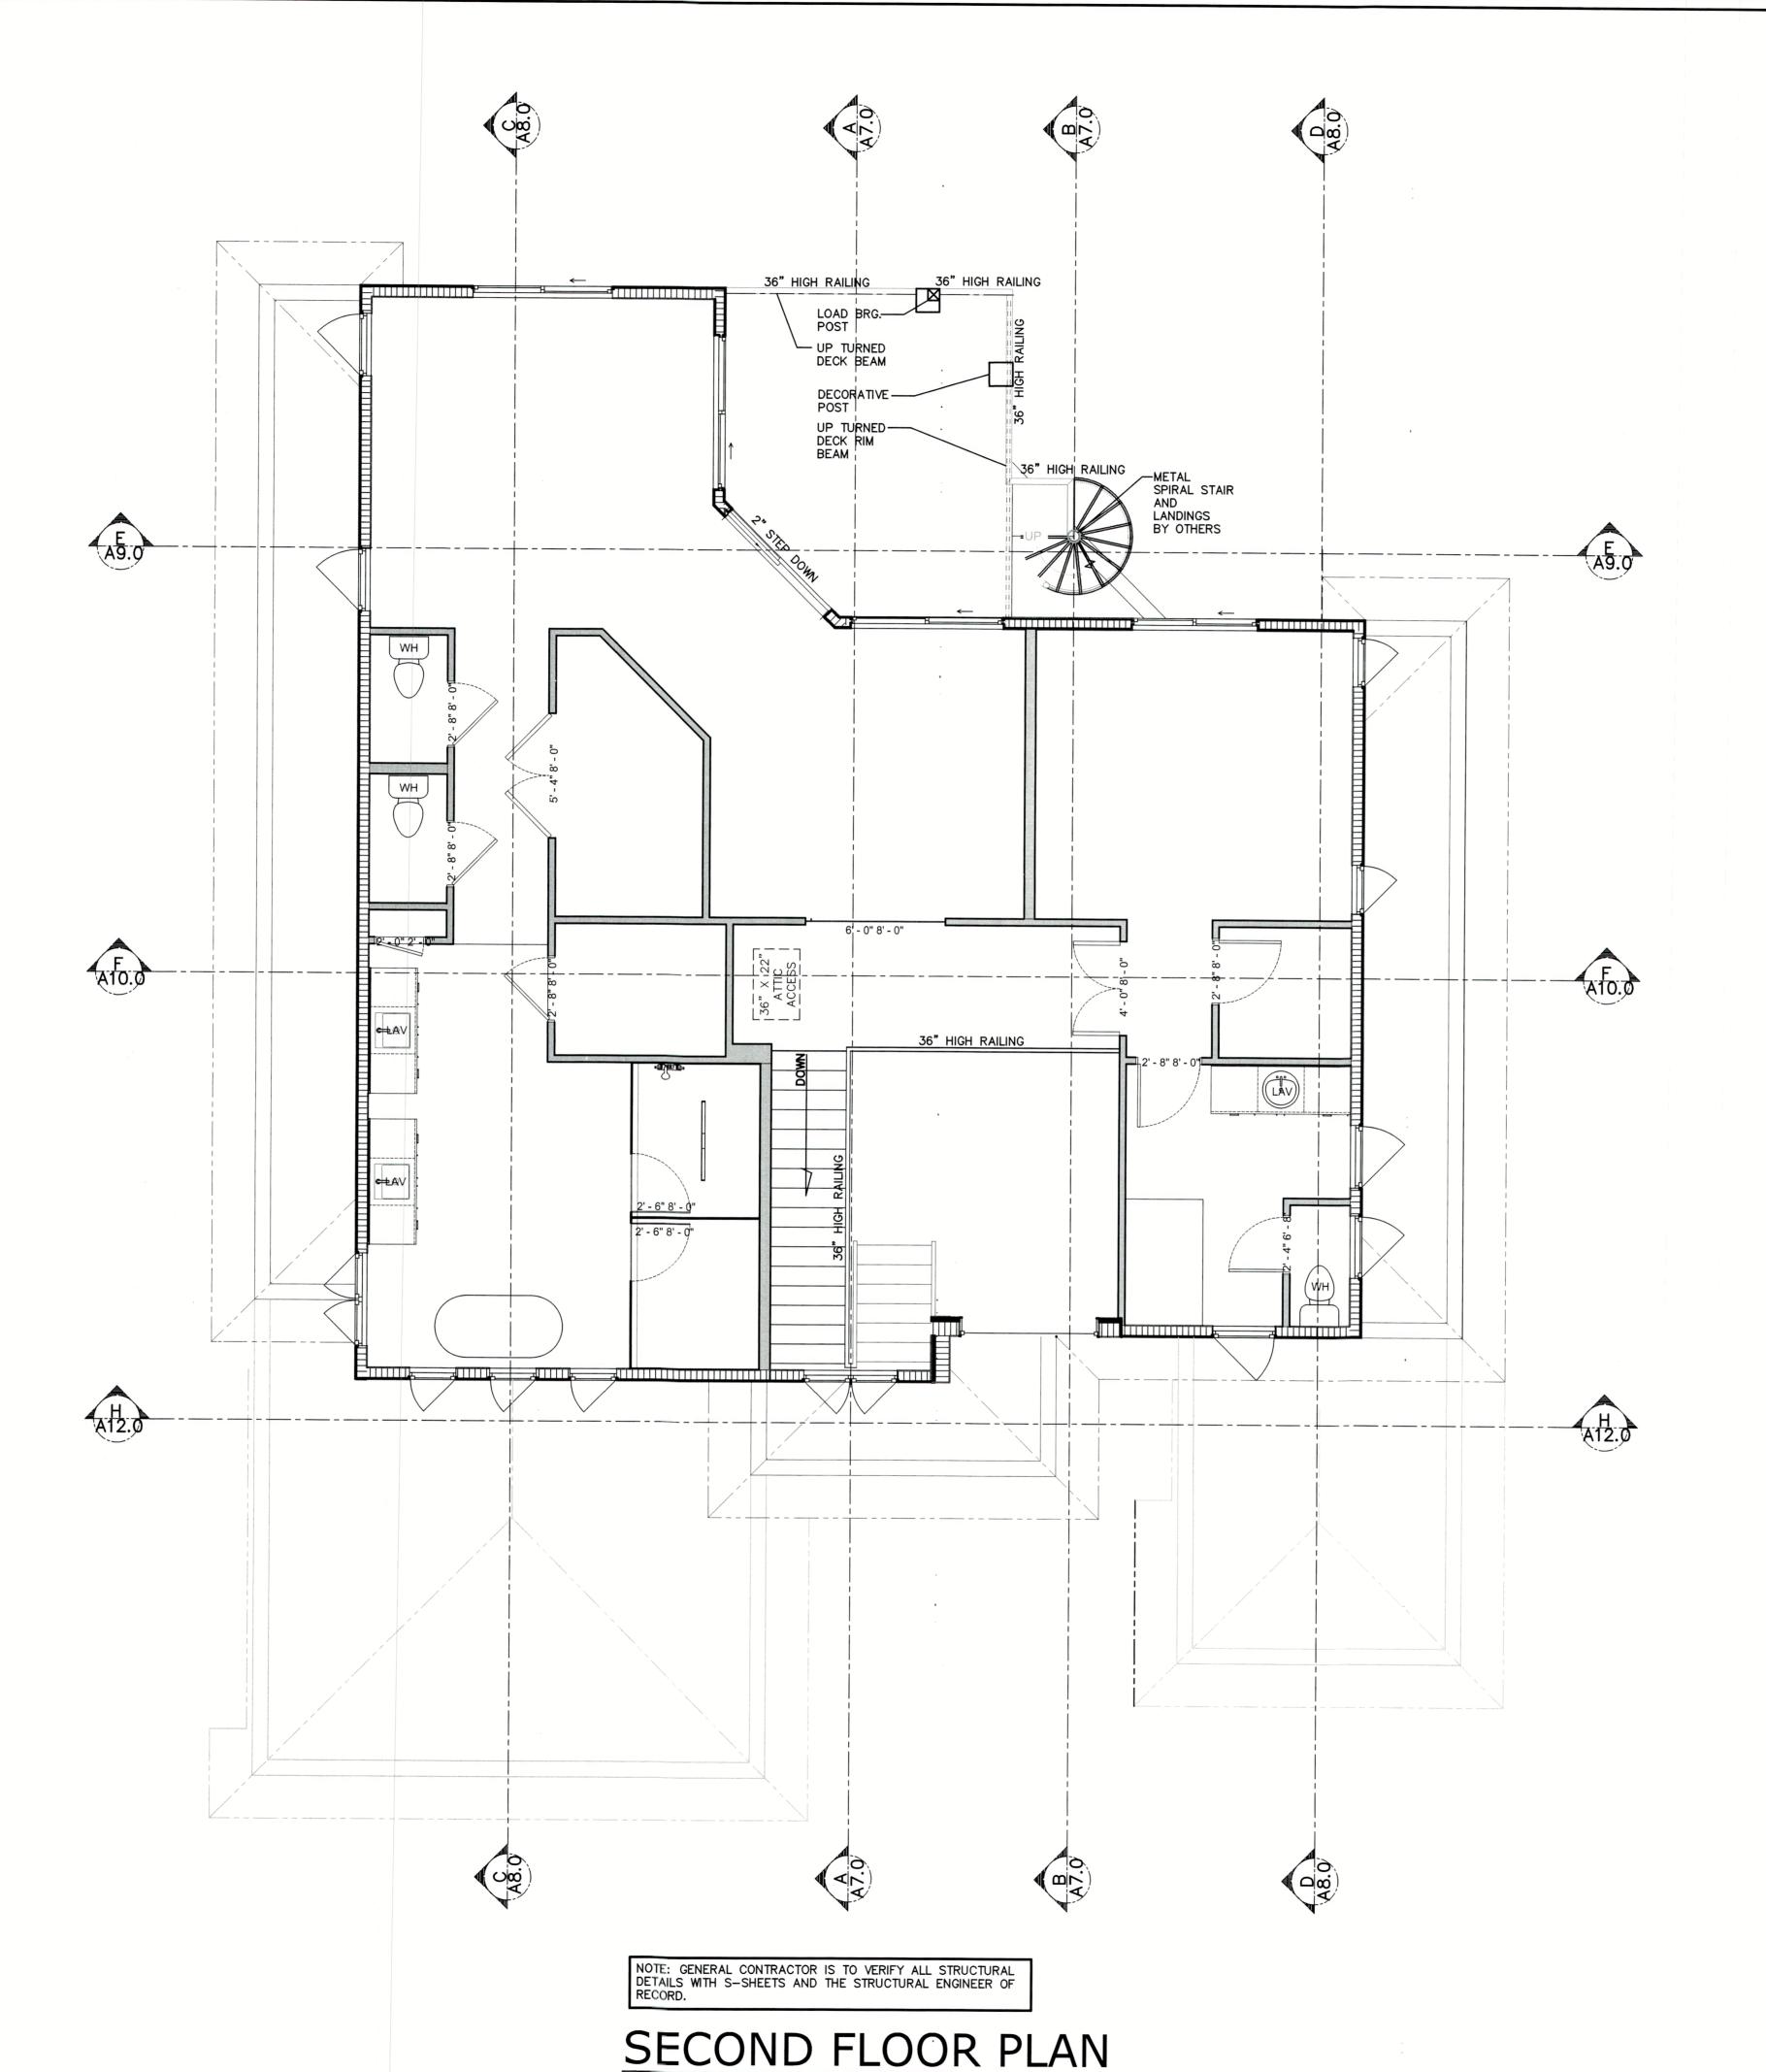

SCALE: 1/4" = 1'-0"

NOTE:
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APPROVED BY THE HOMEOWNER. THE DRAWINGS HAVE BEEN DONE TO THE BEST OF JC DRAFTING & DESIGN INC.'S KNOWLEDGE THE PLANS AND SPECIFICATIONS COMPLY WITH THE APPLICABLE MINIMUM FLORIDA BUILDING CODES AND FIRE SAFETY STANDARDS AND ANY CONDITIONS WHICH APPEAR TO BE INACCURATE SHALL BE BROUGHT TO THE DESIGNER, STRUCTURAL ENGINEER AND THE GENERAL CONTRACTOR'S ATTENTION AND CORRECTED. THE GENERAL CONTRACTOR SHALL EXAMINE THE PLANS COMPLETELY AND VISIT THE JOB SITE BEFORE BEGINNING CONSTRUCTION ON THIS PROJECT. IT SHALL BE THE GENERAL CONTRACTORS RESPONSIBILITY TO INSURE THAT THE STRUCTURE CAN BE CONSTRUCTED AS DRAWN OR WITH ADDENDUM DRAWINGS TO BE PROVIDE BY THE DESIGNER ONLY. THE GENERAL CONTRACTOR SHALL VERIFY ALL DIMENSIONS AND CRITICAL HEIGHTS. IT WILL ALSO BE THE GENERAL CONTRACTOR'S RESPONSIBILITY TO OBTAIN ALL NECESSARY PERMITS AND MEET ALL STATE AND LOCAL BUILDING CODES. ALL DISCREPANCIES ARE TO BE BROUGHT TO THE ATTENTION OF THE DESIGNER IN WRITING. ANY STRUCTURAL CHANGES THAT APPEAR TO BE NEEDED ARE TO BE BROUGHT TO THE ATTENTION OF THE STRUCTURAL ENGINEER OF RECORD FOR THIS PROJECT. WORK IS NOT TO PROCEED UNTIL ALL DISCREPANCIES ARE CORRECTED. THE GENERAL CONTRACTOR SHALL CHECK AND VERIFY ALL DIMENSIONS AND COORDINATE ALL CONDITIONS IN THE FIELD. ALL DISCREPANCIES AND CONFLICTS SHALL BE REPORTED TO THE DESIGNER IN WRITING PRIOR TO PROCEEDING OR CONSTRUCTION. UNREPORTED DISCREPANCIES AND CONFLICTS SHALL REMAIN THE

RESPONSIBILITY OF THE CONTRACTOR. THESE PLANS AND DESIGN CONCEPTS ARE THE INTELLECTUAL PROPERTY OF JC DRAFTING & DESIGN, INC. NO CHANGE TO THESE DRAWINGS MAY BE MADE WITHOUT A WRITTEN CONSENT FROM JC DRAFTING & DESIGN, INC., UNAUTHORIZED USE IS PROHIBITED. THE DESIGN(S) DEPICTED AND SPECIFIED ON THESE DRAWINGS ARE PROTECTED UNDER THE COPYRIGHT LAWS OF THE UNITED STATES AND ARE THE PROPERTY OF JC DRAFTING & DESIGN, INC. AND SHALL BE RETURNED IN THE EVENT OF TERMINATION. USE OR COPY IS PERMITTED BY CONTRACT ONLY. ANY CHANGES TO THESE PLANS WITHOUT THE WRITTEN APPROVAL OF JC DRAFTING & DESIGN, INC. OR ANY CONSTRUCTION EXECUTED FROM THESE PLANS WITHOUT THE EXPRESSED WRITTEN APPROVAL OF JC DRAFTING & DESIGN, INC SHALL AUTOMATICALLY RENDER JC DRAFTING & DESIGN, INC AND ITS EMPLOYEES HARMLESS TO ANY LIABILITY CLAIMS, SUIT OR LITIGATION BY ANY INTERESTED PARTIES IN THE PROJECT.

ALL CONSTRUCTION TO BE IN STRICT ACCORDANCE WITH GOVERNING CODES. . ALL MANUFACTURED PRODUCTS AND MATERIALS SHALL BE USED

N ACCORDANCE WITH THE MANUFACTURERS SPECIFICATION RECOMMENDATIONS. DO NOT SCALE ANY DRAWINGS IN THIS SET. APPLIES TO ALL SHEETS. ALL DIMENSIONS ARE TO ROUGH CONSTRUCTION UNLESS NOTED OTHERWISE. THE GENERAL CONTRACTOR TO VERIFY ALL DIMENSIONS AND DETAILS PRIOR TO CONSTRUCTION. NOTIFY DESIGNER OF ALL DISCREPANCIES.

NOTE: IN ACCORDANCE WITH FBC R703.8 FLASHING: EXTERIOR WINDOWS AND DOORS SHALL BE FLASHED IN ACCORDANCE WITH MANUFACTURER'S NOA OR PRODUCT APPROVAL AND / OR INSTALLATION INSTRUCTIONS. IF FLASHING IS NOT ADDRESSED IN EITHER OF THE PREVIOUS NOTED THEN PAN FLASHING SHALL BE PROVIDED. PAN FLASHING SHALL BE SEALED AND SLOPED AS TO DIRECT WATER TO THE SURFACE OF THE EXTERIOR WALL FINISH OR WATER RESISTIVE BARRIER FOR SUBSEQUENT DRAINAGE. OPENINGS USING PAN FLASHING SHALL INCORPORATE FLASHING OR PROTECTION AT THE HEAD AND SIDES.

NOTE: ALL FINAL CABINET AND SHELVING LAYOUTS, DESIGN, DRAWINGS, SPECIFICATIONS & ENGINEERING ARE TO BE PROVIDED BY THE CABINET MAKER AND ARE NOT PART OF THESE DRAWINGS. CONTRACTOR TO COORDINATE WITH CABINET MAKER WITH THE OWNER'S FINAL SELECTION OF ALL APPLIANCES, FIXTURES AND CABINETRY. CABINET MAKER IS RESPONSIBLE FOR ALL REQUIRED FIELD MEASUREMENTS BEFORE, DURING AND AFTER DEMOLITION AND RENOVATION WITH REGARD TO ALL

NOTE: BRAND, STYLE, KIND, COLOR, ETC. OF ALL FINISHES AND MATERIALS, ELECTRICAL FIXTURES. APPLIANCES, EQUIPMENT AS AGREED AND NEGOTIATED BETWEEN OWNER NOTE: ALL OTHER JOB SPECIFICATION AND

FINISH SPECIFICATIONS TO BE FURNISHED TO GENERAL CONTRACTOR BY THE HOME OWNER AND ARE NOT PART OF THESE DRAWINGS. NOTE: ALL OTHER DETAILS, LAYOUTS,

SPECIFICATIONS, PLUMBING, HEATING, VENTILATION, AIR CONDITIONING, ELECTRICAL TO BE SUPPLIED BY SUBCONTRACTORS TO THE GENERAL CONTRACTOR. NOTICE: ALL INFORMATION PROVIDED MUST

BE VERIFIED IN FIELD AND ANY MINOR ADJUSTMENTS ARE TO BE MADE BY CONTRACTOR IN FIELD. ANY STRUCTURAL CHANGES THAT APPEAR TO BE NEEDED MUST BE BROUGHT TO THE ATTENTION OF THE GENERAL CONTRACTOR AND

NOTE: ALL NEW CONSTRUCTION SHALL BE REQUIRED TO PASS THE BLOWER DOOR TEST PER 2020 ENERGY CONSERVATION CODE R402.4 BE AWARE FLOW THRU OPENINGS MAY CREATE SOME ISSUES WHILE PERFORMING THIS TEST.

NOTE: SEE STRUCTURAL SHEETS FOR FINAL BEARING POST LOCATIONS NOTE: ALL CONDENSATE LINES AND ROOF DOWNSPOUTS SHALL DISCHARGE MIN. 12" AWAY FROM STRUCTURE SIDEWALL USING UNDERGROUND PIPING, TAIL EXTENSIONS OR SPLASH BLOCKS NOTE: ALL PLANS ARE TO MEET THE 2020 FBC-R (7TH EDITION AND 2020 FBC ENERGY CONSERVATION

NOTE: PROVIDE 1" DAPOUT AT ALL EXTERIOR DOOR LOCATIONS NOTE: EXTERIOR WINDOW AND DOOR HEADERS TO BE 8'-0" UNLESS NOTED OTHERWISE. NOTE: FINAL LOCATION OF HOSE

BIBS, BY GC.

NOTE: CEILINGS EXPOSED TO WIND: CEILINGS EXPOSED TO WIND TO BE HARDIE BOARD AS SLCT'D ON 1/2" CDX ATTACHED TO BOTTOM CHORD W/ 1-1/2" DRYWALL SCREWS @ 6" O.C. EDGESPEVIEWED for Code Compliance

NOTE: ALL TRUSS LAYOUTS, SCHEMATIC AND PROTILES ELITE PERMITS OF SARASOTA MUST BE PROVIDED TO JC DRAFTING & DESIGN, INC. AND THE STRUCTURAL ENGINEER OF RECORD FOR APPROVAL.



Plan no.

2021-50 A3.0

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CUS BO SP/ 759 I

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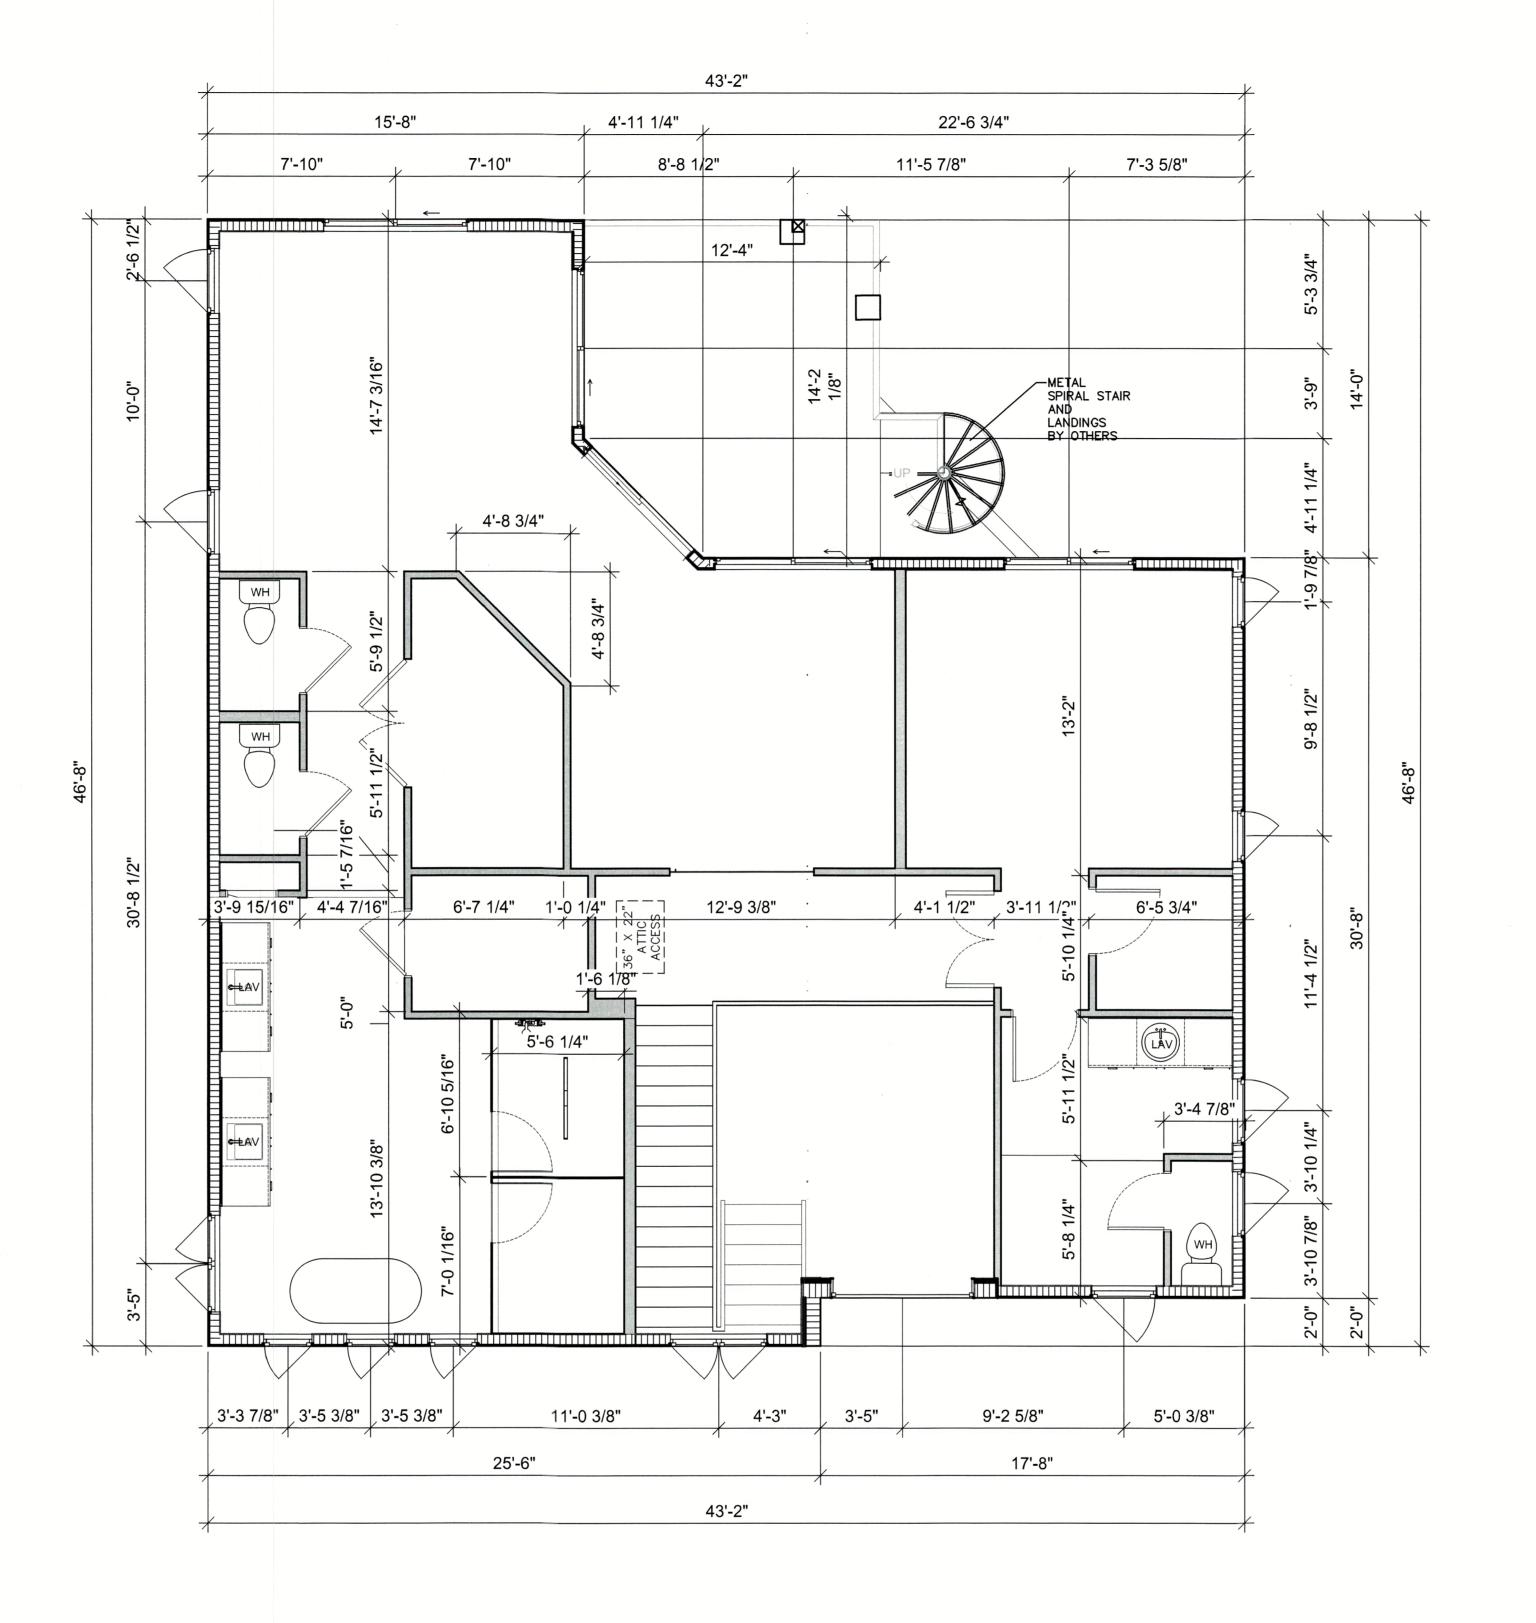
REVISIONS: NO. DESCRIP: | BY | DATE DATE: 8-15-2022

SCALE: AS SHOWN

SHEET TITLE:

SECOND FLOOR SHEET NO.

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AND CONFLICTS SHALL BE REPORTED TO THE DESIGNER IN WRITING PRIOR TO PROCEEDING OR CONSTRUCTION. UNREPORTED DISCREPANCIES AND CONFLICTS SHALL REMAIN THE RESPONSIBILITY OF THE CONTRACTOR.

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2. ALL CONSTRUCTION TO BE IN STRICT ACCORDING WITH GOVERNING CODES.

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Plan no.

2021-50 A3.1

CUS BOI SP/ 759 N LONG PID: 7

NO. DESCRIP: BY DATE

DATE: 8-15-2022

SCALE: AS SHOWN

SHEET TITLE:


SECOND FLOOR DIMENSIONAL PLAN SHEET NO.

A3.1



	Rough	Opening					Head
Mark	Width	Height	Description	Comments	Wall Type	Thickness	Height
GFW1	4' - 0"	4' - 7"	DOUBLE CASEMENT		CONC.	8" CMU	11' - 0"
GFW2	2' - 4"	4' - 7"	SINGLE CASEMENT		CONC.	8" CMU	11' - 0"
GFW3	6' - 0"	1' - 8"	FIXED	TRANSOM	CONC.	8" CMU	11' - 0"
GFW4	2' - 0"	5' - 0"	SINGLE CASEMENT	"EGRESS"	CONC.	8" CMU	11' - 0"
GFW5	2' - 0"	5' - 0"	SINGLE CASEMENT		CONC.	8" CMU	11' - 0"
GFW6	2' - 8"	4' - 6"	SINGLE CASEMENT		CONC.	8" CMU	8' - 0"
GFW7	2' - 8"	2' - 0"	FIXED	TRANSOM	CONC.	8" CMU	10' - 8"
GFW8	4' - 0"	2' - 0"	HORIZONTAL SLIDER		CONC.	8" CMU	8' - 0"
GFW9	6' - 0"	2' - 0"	FIXED	TRANSOM	CONC.	8" CMU	8' - 0"
GFW10	4' - 0"	6' - 8"	LOUVER		CONC.	8" CMU	10' - 0"
GFW11	4' - 0"	6' - 8"	LOUVER		CONC.	8" CMU	10' - 0"
GFW12	2' - 0"	4' - 6"	SINGLE CASEMENT		CONC.	8" CMU	8' - 0"
GFW13	2' - 0"	2' - 0"	FIXED	TRANSOM	CONC.	8" CMU	10' - 8"
GFW14	2' - 0"	4' - 6"	SINGLE CASEMENT	TIVANOON	CONC.	8" CMU	8' - 0"
CEM14E	2' - 0"	2' - 0"	FIXED	TRANSOM	CONC.	8" CMU	10' - 8"
GFW15 GFW16	2' - 0"	4' - 6"	SINGLE CASEMENT	ITANSON	CONC.	8" CMU	8' - 0"
GFW17	2' - 0"	2' - 0"	FIXED	TRANSOM	CONC.	8" CMU	10' - 8"
GFW17	2' - 0"	6' - 0"	SINGLE CASEMENT	TRANSON	CONC.	8" CMU	8' - 0"
OFW(40	0' 0"	2' - 0"	FIXED	TRANSOM	CONC.	8" CMU	10' - 8"
GFW19	2' - 0"			TRANSOW		8" CMU	10' - 8"
GFW20	3' - 0"	4' - 4"	SINGLE	TDANICOM	CONC.		
GFW21	2' - 0"	2' - 0"	FIXED	TRANSOM	CONC.	8" CMU	11' - 0"
GFW22	2' - 0"	2' - 0"	FIXED	TRANSOM	CONC.	8" CMU	11' - 0"
GFW23	2' - 0"	2' - 0"	FIXED	TRANSOM	CONC.	8" CMU	11' - 0"
GFW24	2' - 4"	4' - 7"	SINGLE CASEMENT		CONC.	8" CMU	11' - 0"
SFW1	4' - 0"	6' - 0"	DOUBLE CASEMENT		WOOD	2X6	9' - 0"
SFW2	6' - 0"	5' - 4"	FIXED		CONC.	8" CMU	8' - 0"
SFW3	2' - 8"	6' - 0"	SINGLE CASEMENT		WOOD	2X6	8' - 0"
SFW4	2' - 8"	6' - 0"	SINGLE CASEMENT		WOOD	2X6	8' - 0"
SFW5	2' - 8"	6' - 0"	SINGLE CASEMENT		WOOD	2X6	8' - 0"
SFW6	2' - 1"	6' - 0"	SINGLE CASEMENT	"EGRESS"	WOOD	2X6	8' - 0"
SFW7	2' - 1"	6' - 0"	SINGLE CASEMENT		WOOD	2X6	8' - 0"
SFW8	5' - 4"	6' - 0"	HORIZONTAL SLIDER		WOOD	2X6	8' - 0"
SFW9	6' - 6"	6' - 0"	HORIZONTAL SLIDER		WOOD	2X6	8' - 0"
SFW10	6' - 6"	6' ~ 0"	HORIZONTAL SLIDER		WOOD	2X6	8' - 0"
SFW11	6' - 0"	6' - 0"	HORIZONTAL SLIDER		WOOD	2X6	8' - 0"
SFW12	2' - 8"	6' - 0"	SINGLE CASEMENT		WOOD	2X6	8' - 0"
SFW13	2' - 8"	6' - 0"	SINGLE CASEMENT		WOOD	2X6	8' - 0"
SFW15	4' - 0"	6' - 0"	DOUBLE CASEMENT		WOOD	2X6	8' - 0"
SFW16	2' - 0"	6' - 0"	SINGLE CASEMENT	A COLOR OF THE COL	WOOD	2X6	8' - 0"
SFW17	2' - 0"	6' - 0"	SINGLE CASEMENT	Alexandria de la companya de la comp	WOOD	2X6	8' - 0"
SFW18	2' - 0"	6' - 0"	SINGLE CASEMENT		WOOD	2X6	8' - 0"

			Door Schedule			
Mark	Door Size	Description	Remarks	Type Header	Wall Thickness	Head Height
GFD1	64" X 108"	EXTERIOR	OUT-SWING	CONC.	8" CMU	9' - 0"
GFDI	04 X 106	DOOR	001-300110	CONC.	o Civio	9 - 0
GFD2	32" X 96"	FULL LIGHT DOOR	OUT-SWING	CONC.	8" CMU	8' - 0"
GFD3	8' X 8'	OVERHEAD GARAGE DOOR	IMPACT/ INSULATED	CONC.	8" CMU	8' - 0"
GFD4	32" X 96"	FULL LIGHT DOOR	OUT-SWING	CONC.	8" CMU	8' - 0"
GFD5	72" X 120"	S.G.D.	2 PANEL "EGRESS"	CONC.	8" CMU	10' - 0"
GFD6	72" X 120"	S.G.D.	2 PANEL	CONC.	8" CMU	10' - 0"
GFD7	120" X 288"	S.G.D.	4 PANEL	CONC.	8" CMU	10' - 0"
GFD8	18' X 8'	OVERHEAD GARAGE DOOR	IMPACT/ INSULATED	CONC.	8" CMU	3' - 0"
GFD9	32" X 96"	FULL LIGHT DOOR	OUT-SWING	CONC.	8" CMU	3' - 0"
SFD1	72" X 96"	S.G.D.	2 PANEL "EGRESS"	WOOD	2X6	8' - 0"

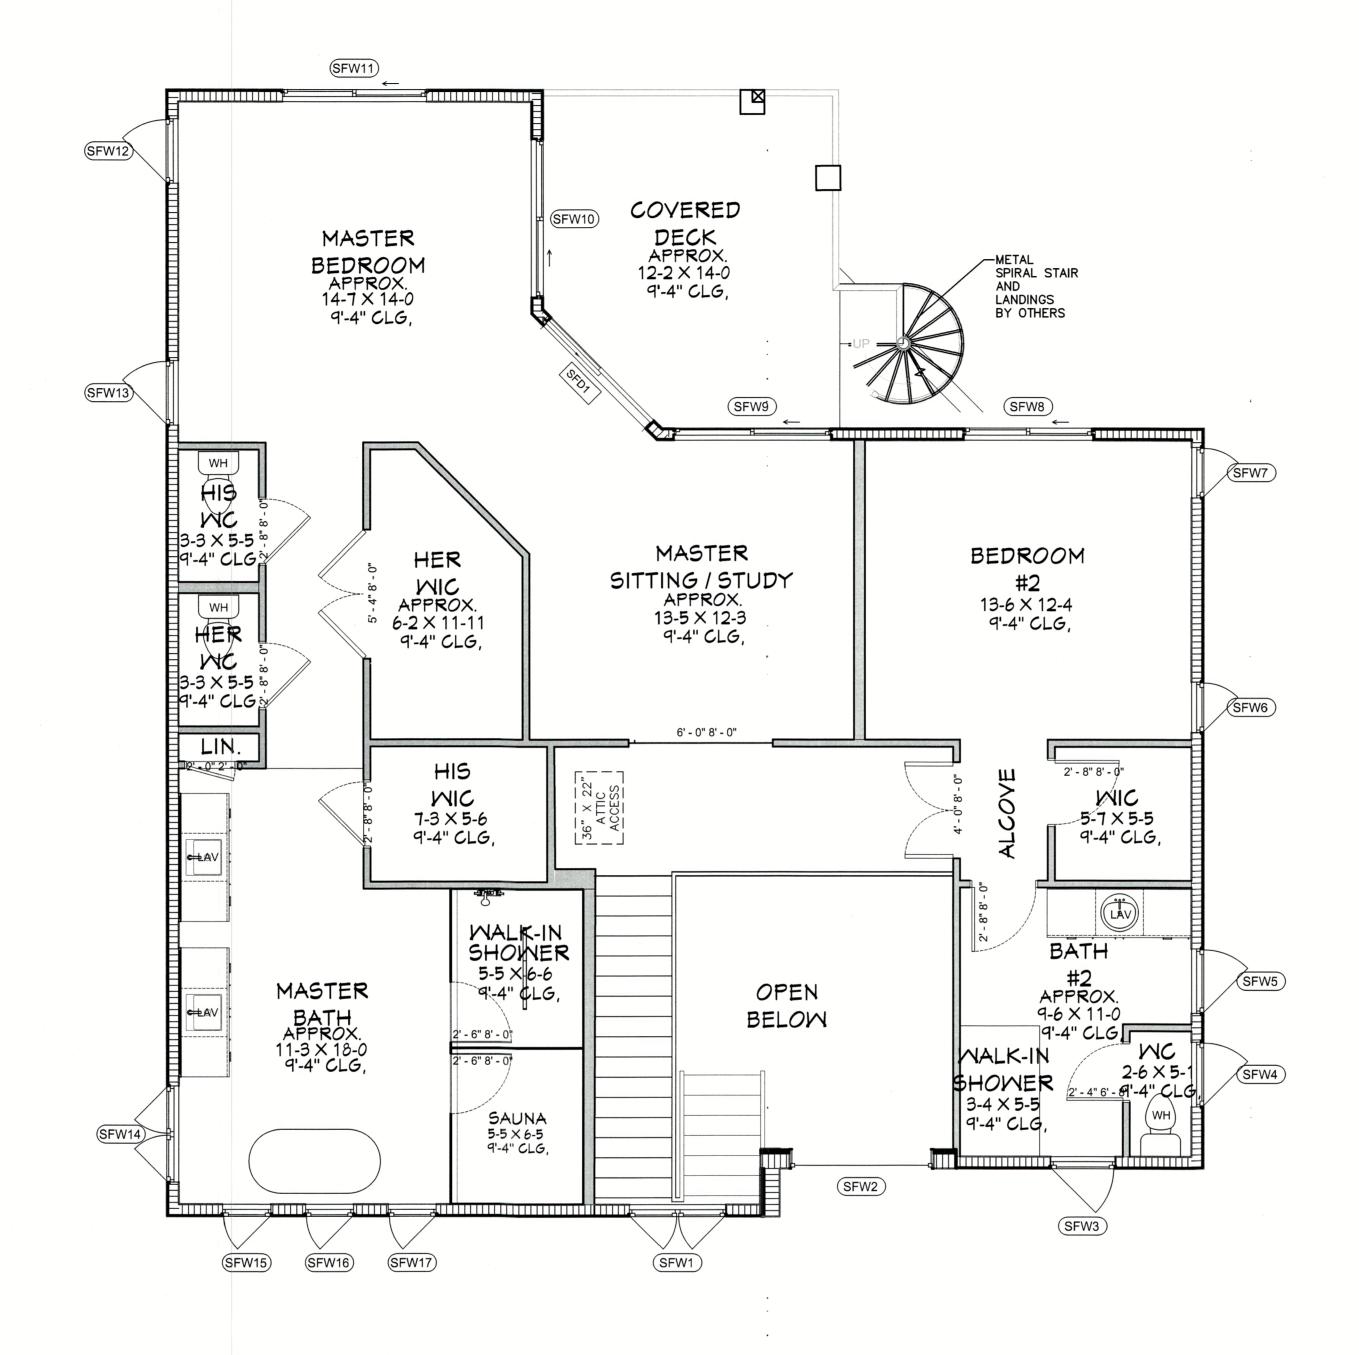

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Plan no.

2021-50 A3.2

CUS BOI SP/ 759 N LONG PID:

REVISIONS: NO. DESCRIP: BY DATE

DATE: 8-15-2022

SCALE: AS SHOWN

SHEET TITLE:

SECOND FLOOR W/D SCHEDULE SHEET NO.

The same at the same

WALL LEGEND:

SCALE: 1/4" = 1'-0"


— 2X6 INTERIOR WOOD BEARING WALL, U.N.O.

— 2X6 EXTERIOR WOOD BEARING WALL, U.N.O.

Reviewed for Code Compliance

ELITE PERMITS OF SARASOTA

SECOND FLOOR W/D SCHEDULE

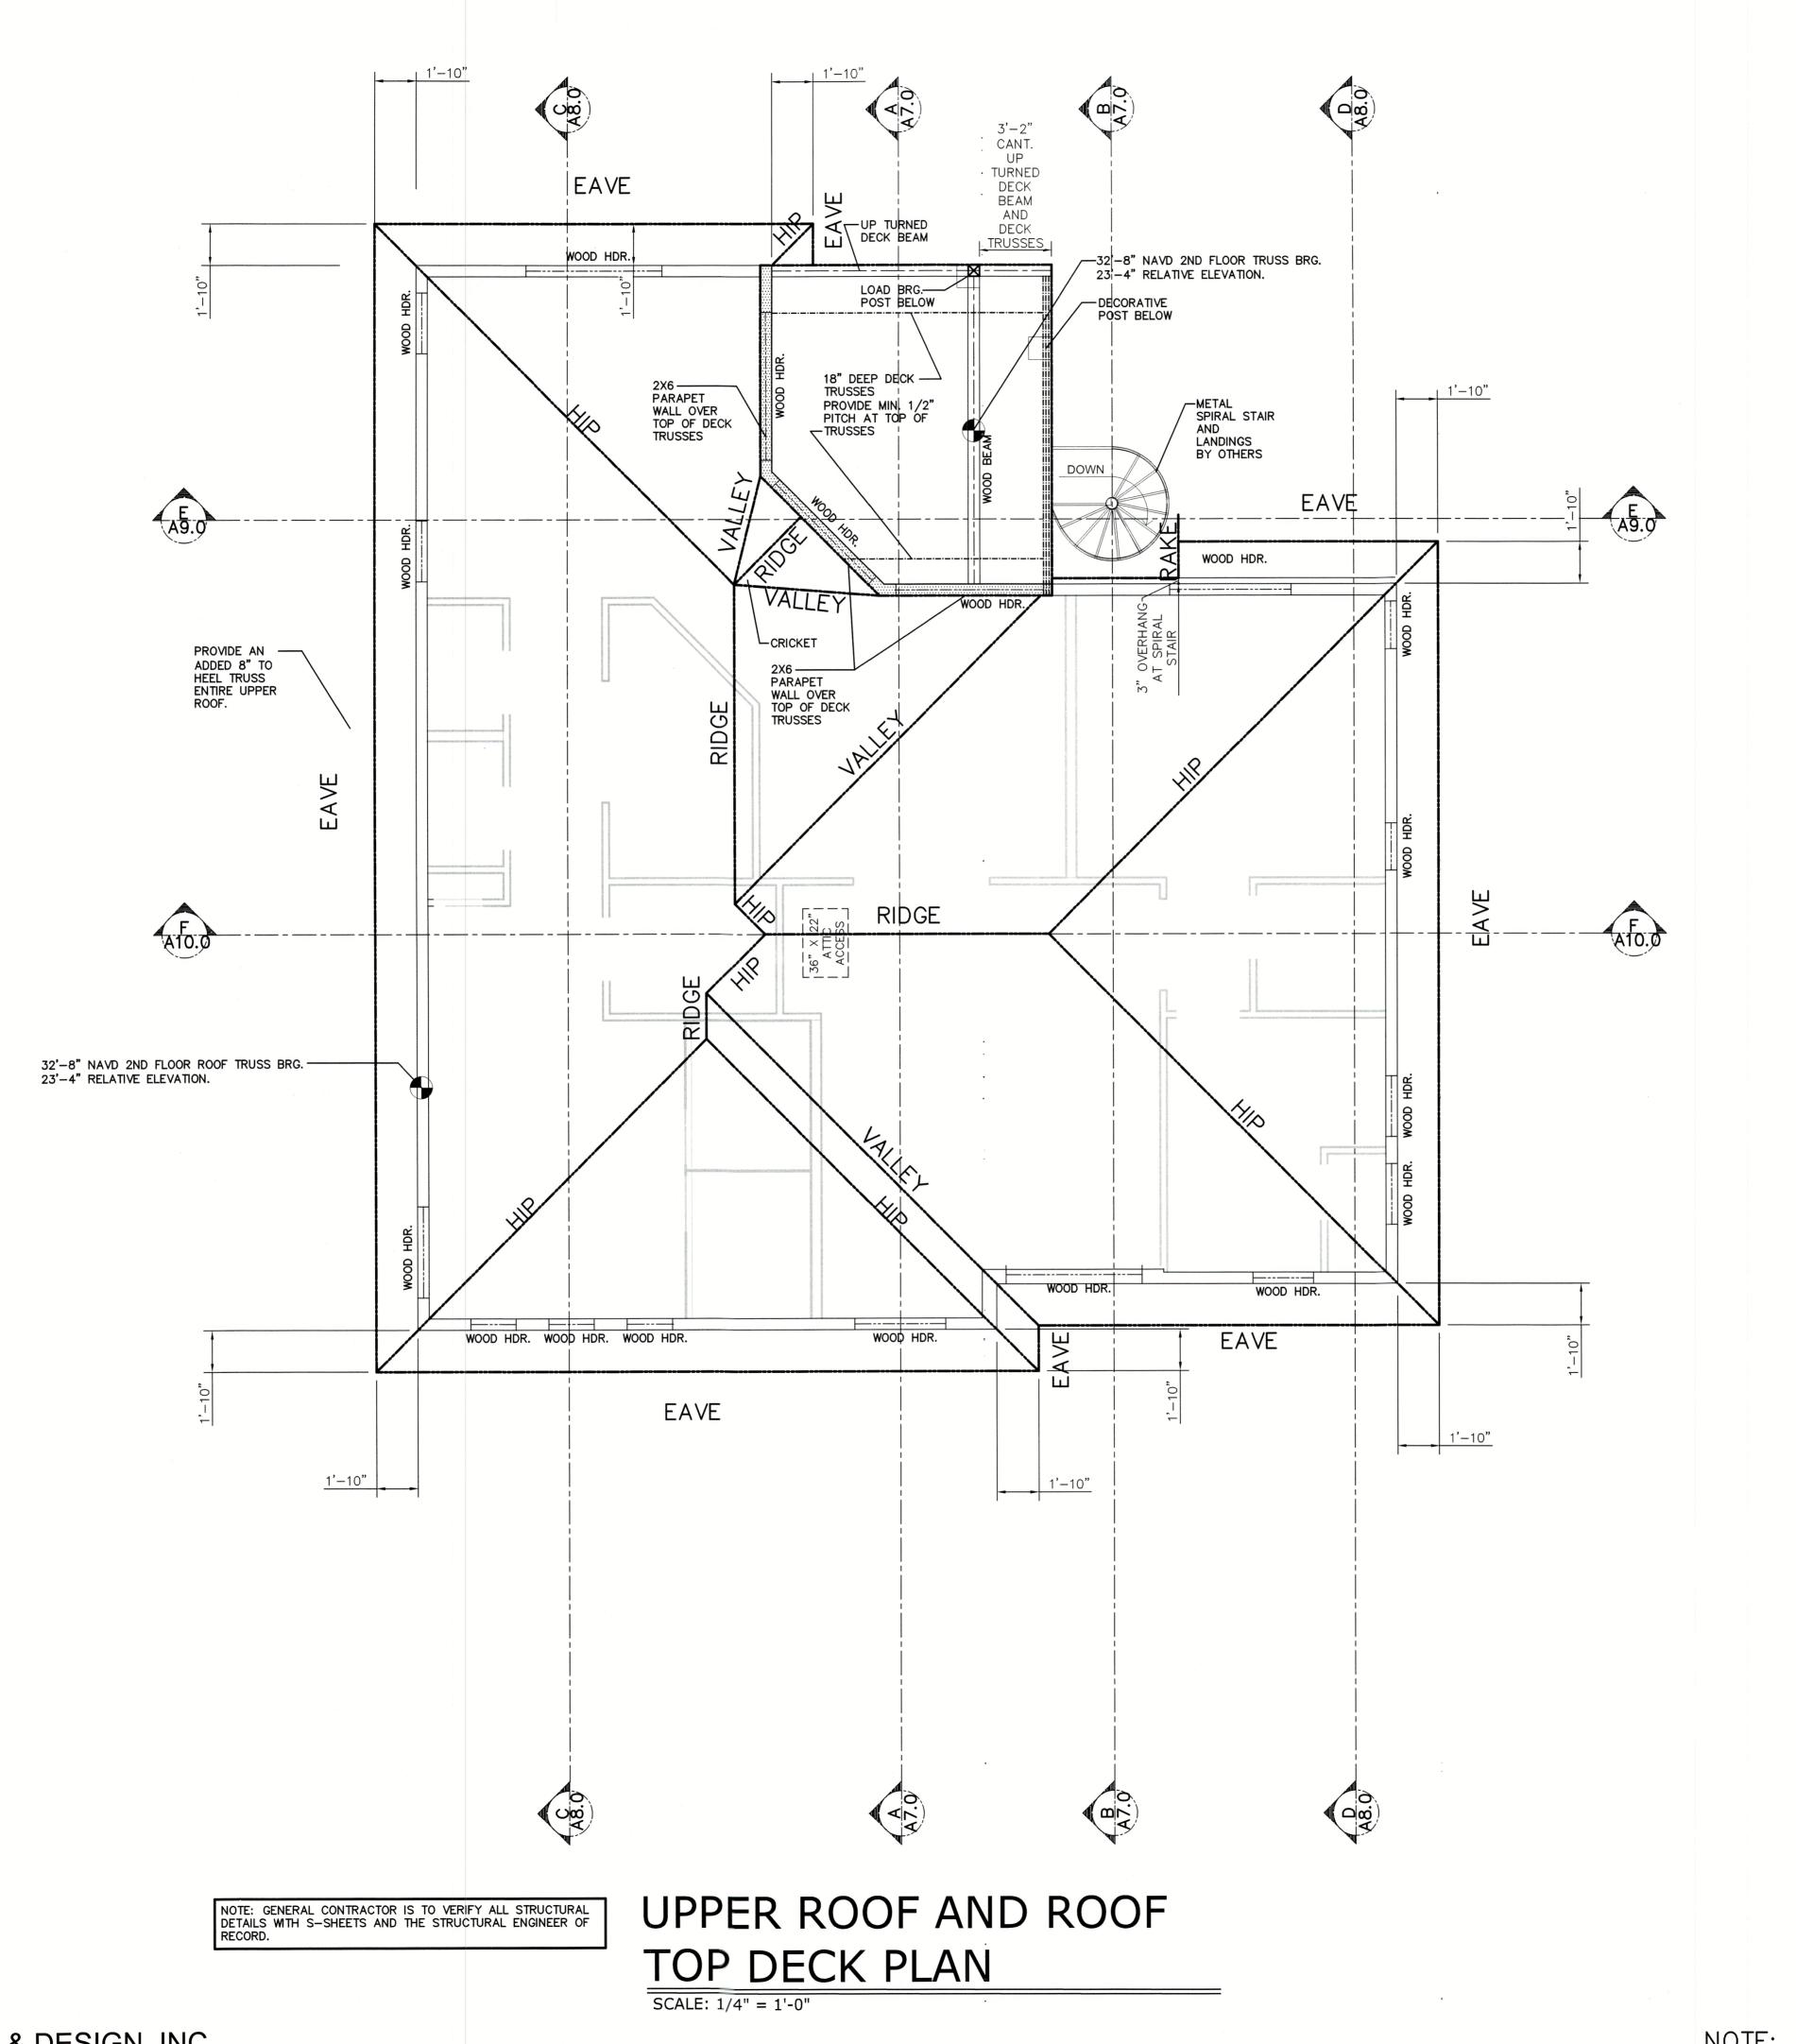

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2021-50 A3.3

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PERKINS POWERS BUILDERS
777 SOUTH PALM AVE. #11
SARASOTA FL. 34236
(941) 376-2557
CGC1514073

Plan no.

CUSTOM RESIDENCE FO

BOB & AMY

SPANOS
759 MARBURY LANE
LONGBOAT KEY FL. 34228
PID: 7871700006

ESIGN INC.
ONDER AVE. SUITE C
ota, Florida 34232
(941) 925-3009 Cell (941) 376-2047
raftinganddesigninc.com

REVISIONS:

NO. DESCRIP: BY DATE

DATE: 8-15-2022

SCALE: AS SHOWN


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UPPER ROOF AND ROOF TOP DECK FRAMING PLAN SHEET NO.

NOTE: THESE DRAWINGS ARE NOT TO BE SCALED

Reviewed for Code Compliance

ELITE PERMITS OF SARASOTA

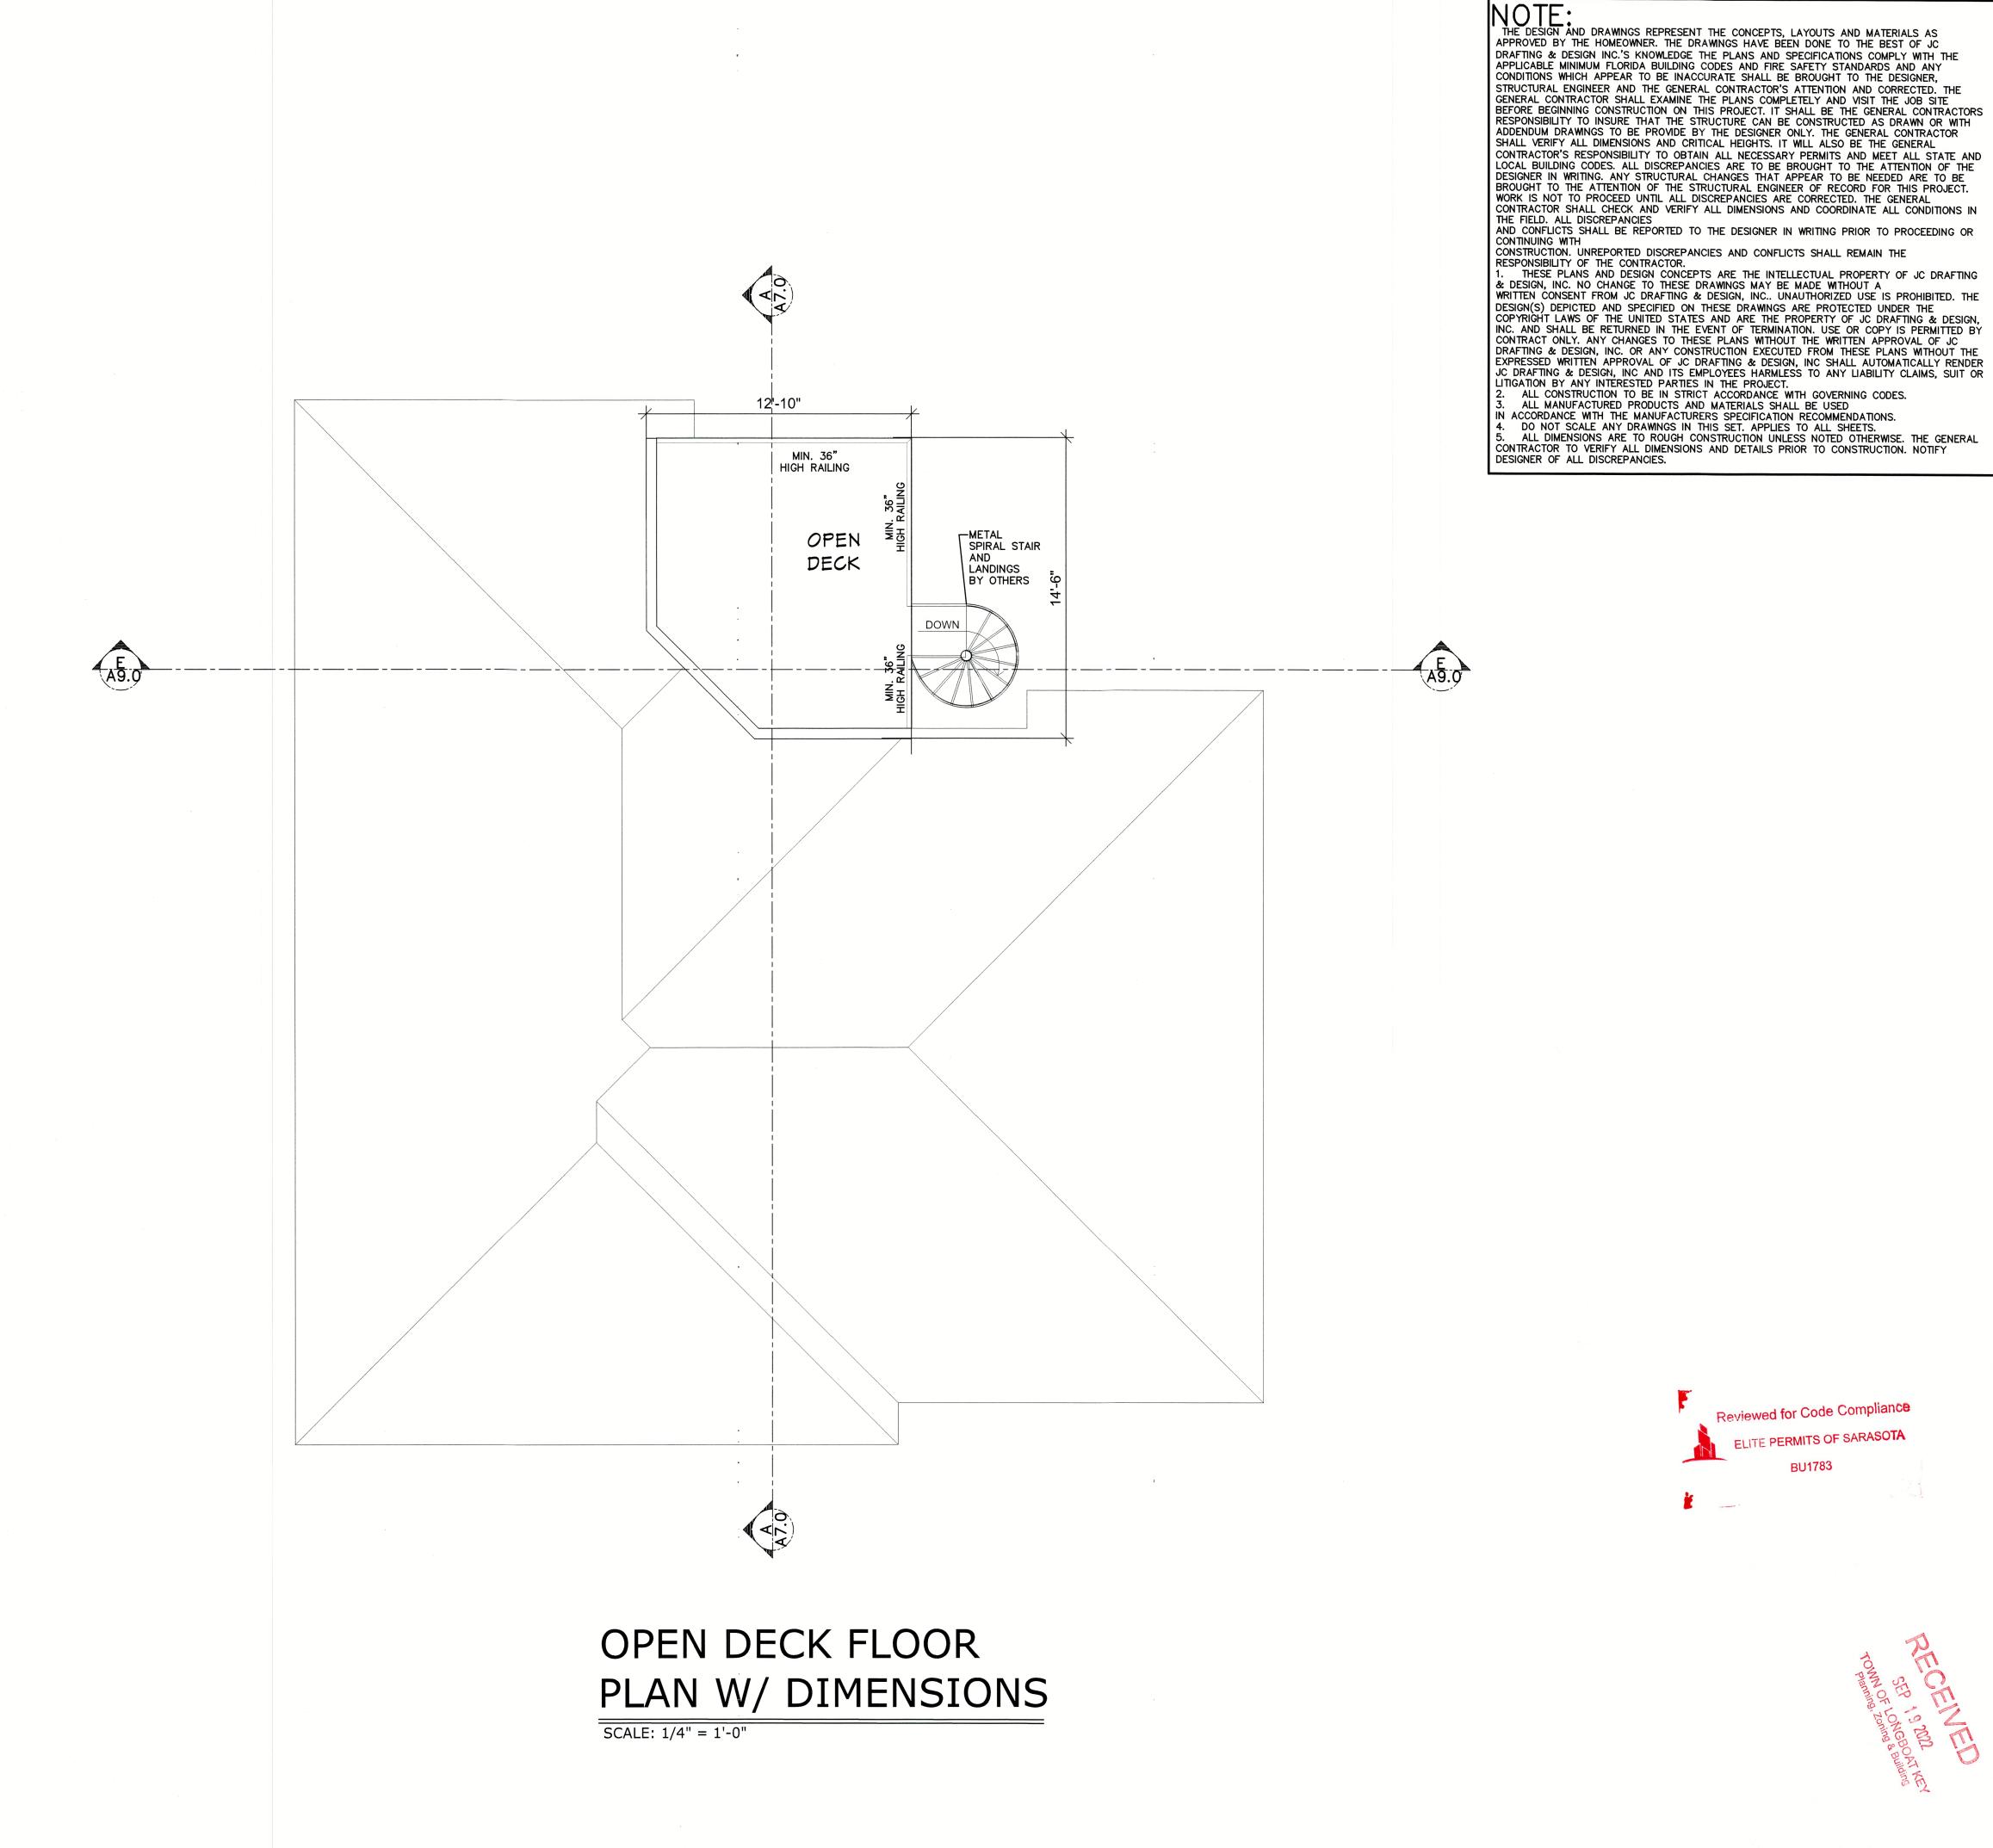

NOTE:
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Plan no.

2021-50 A4.0

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CUSTC BOB SPAI 759 MA LONGBC PID: 78


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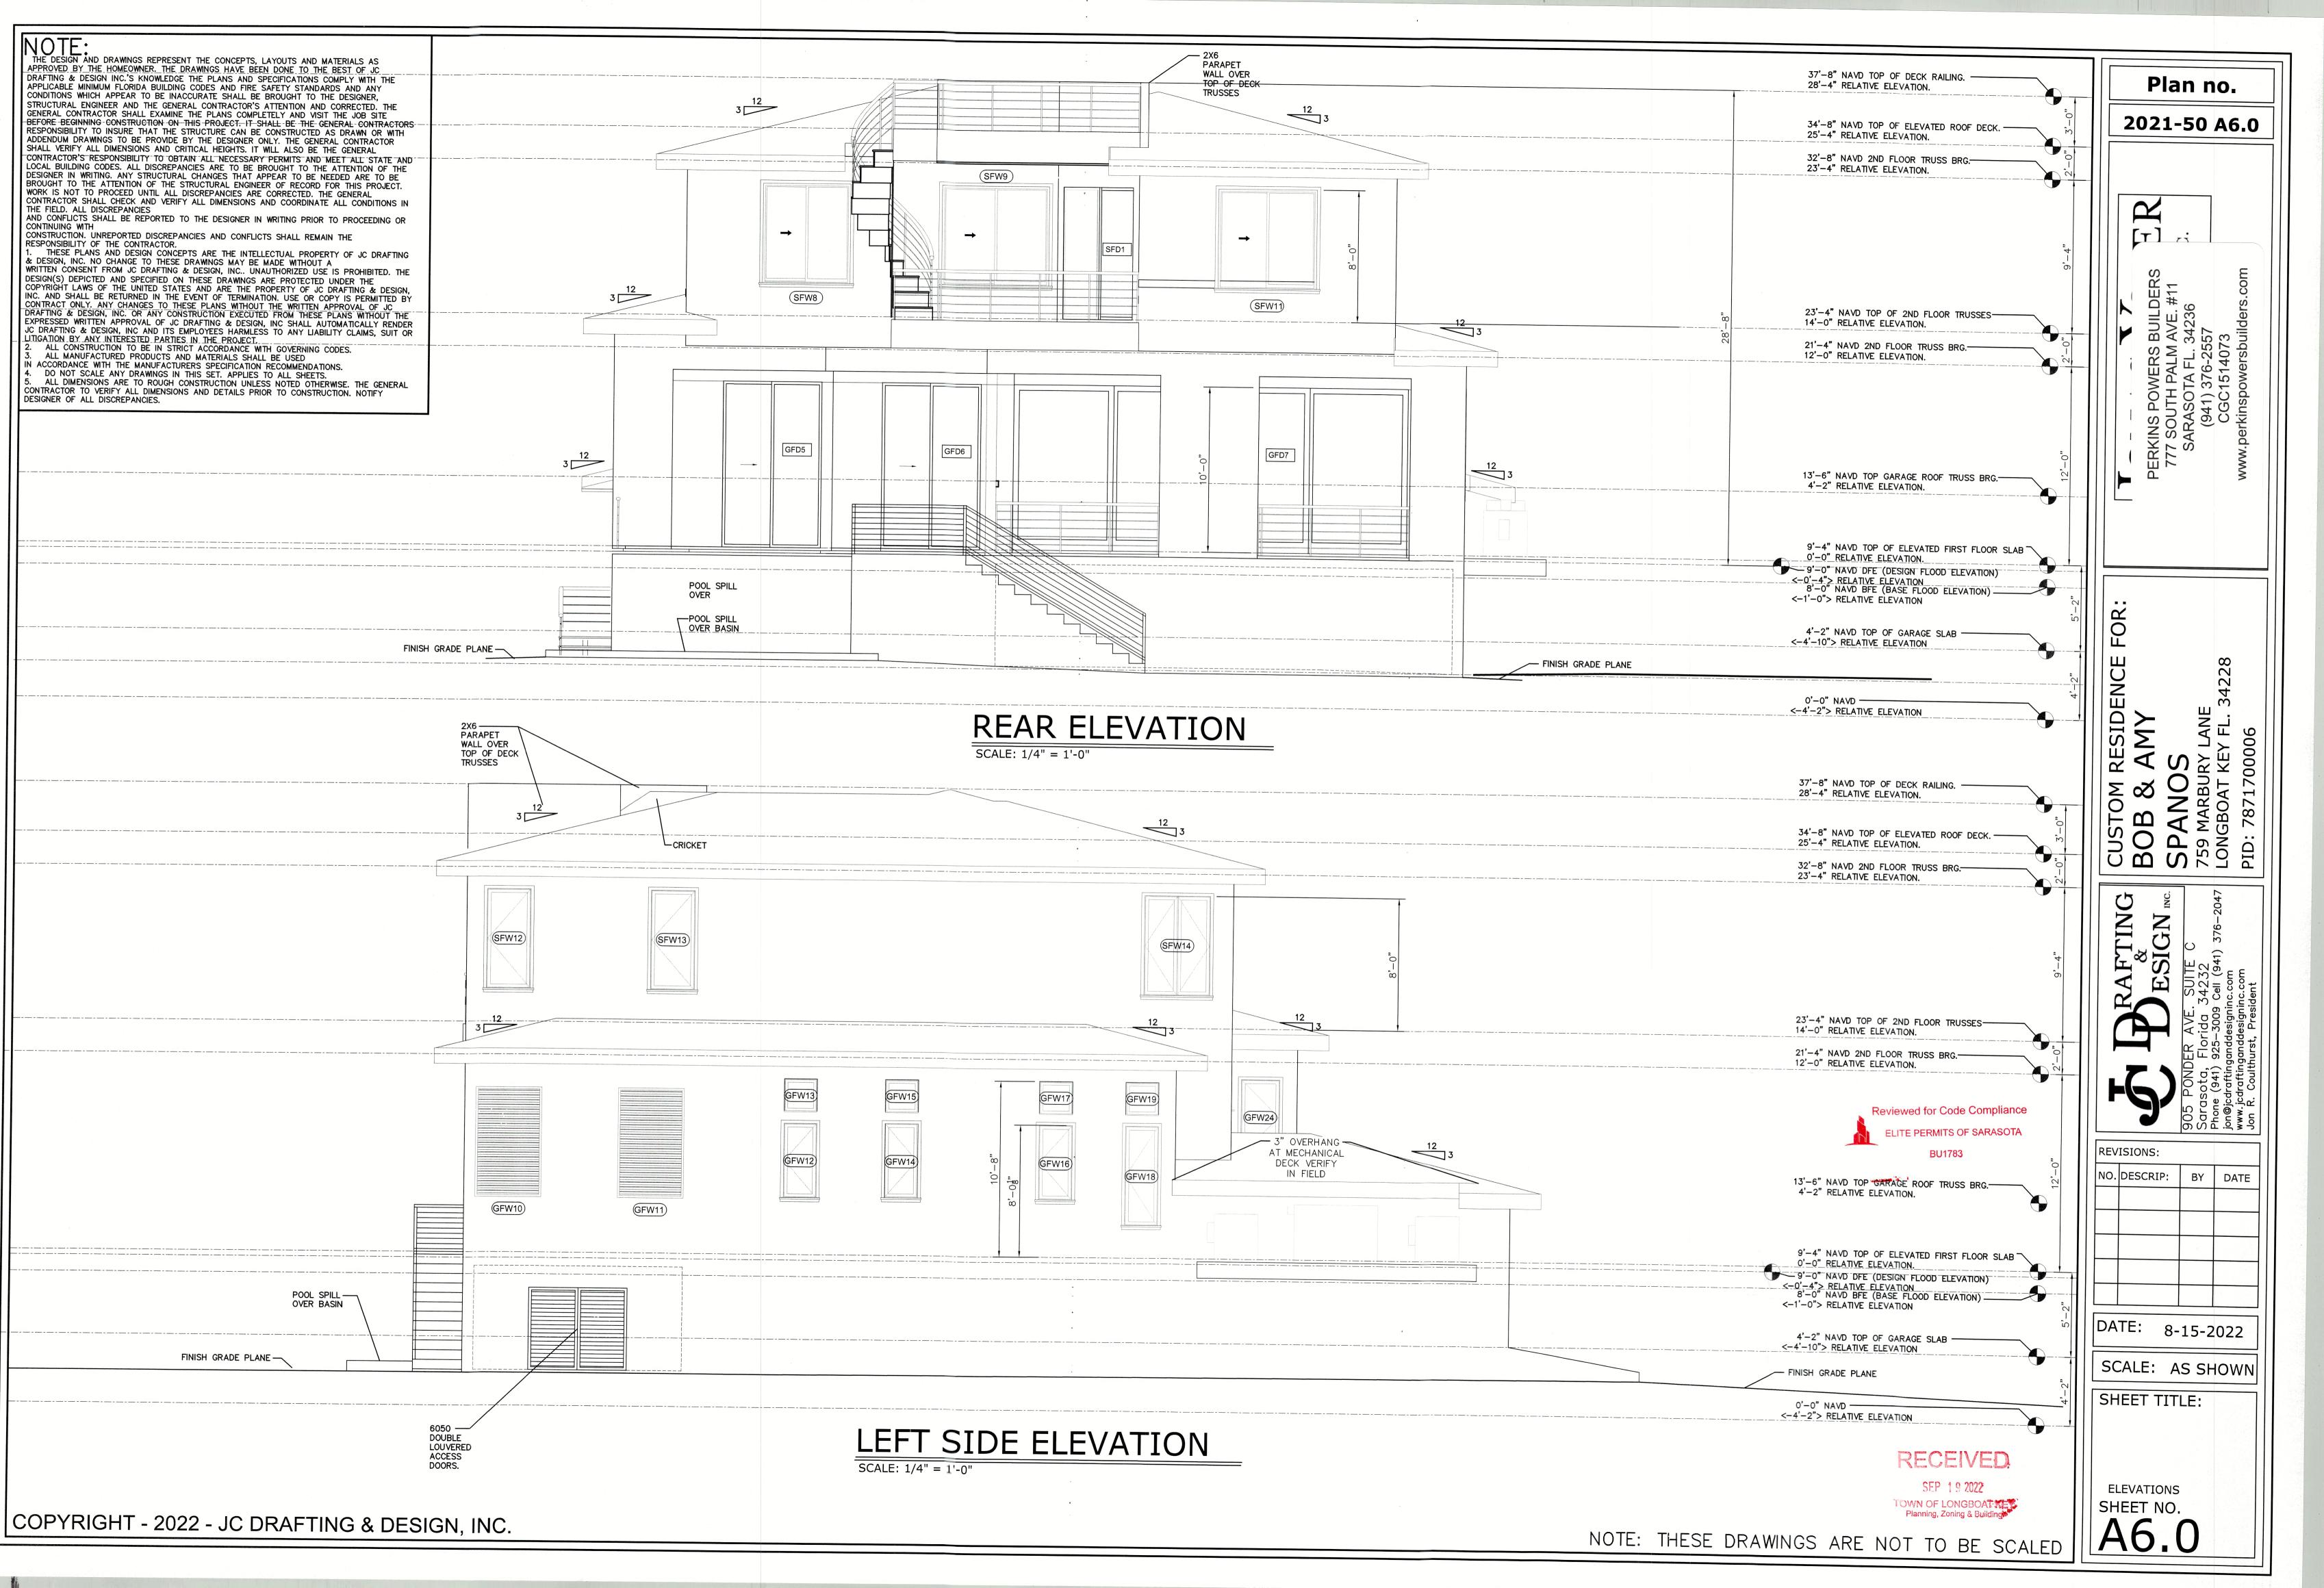
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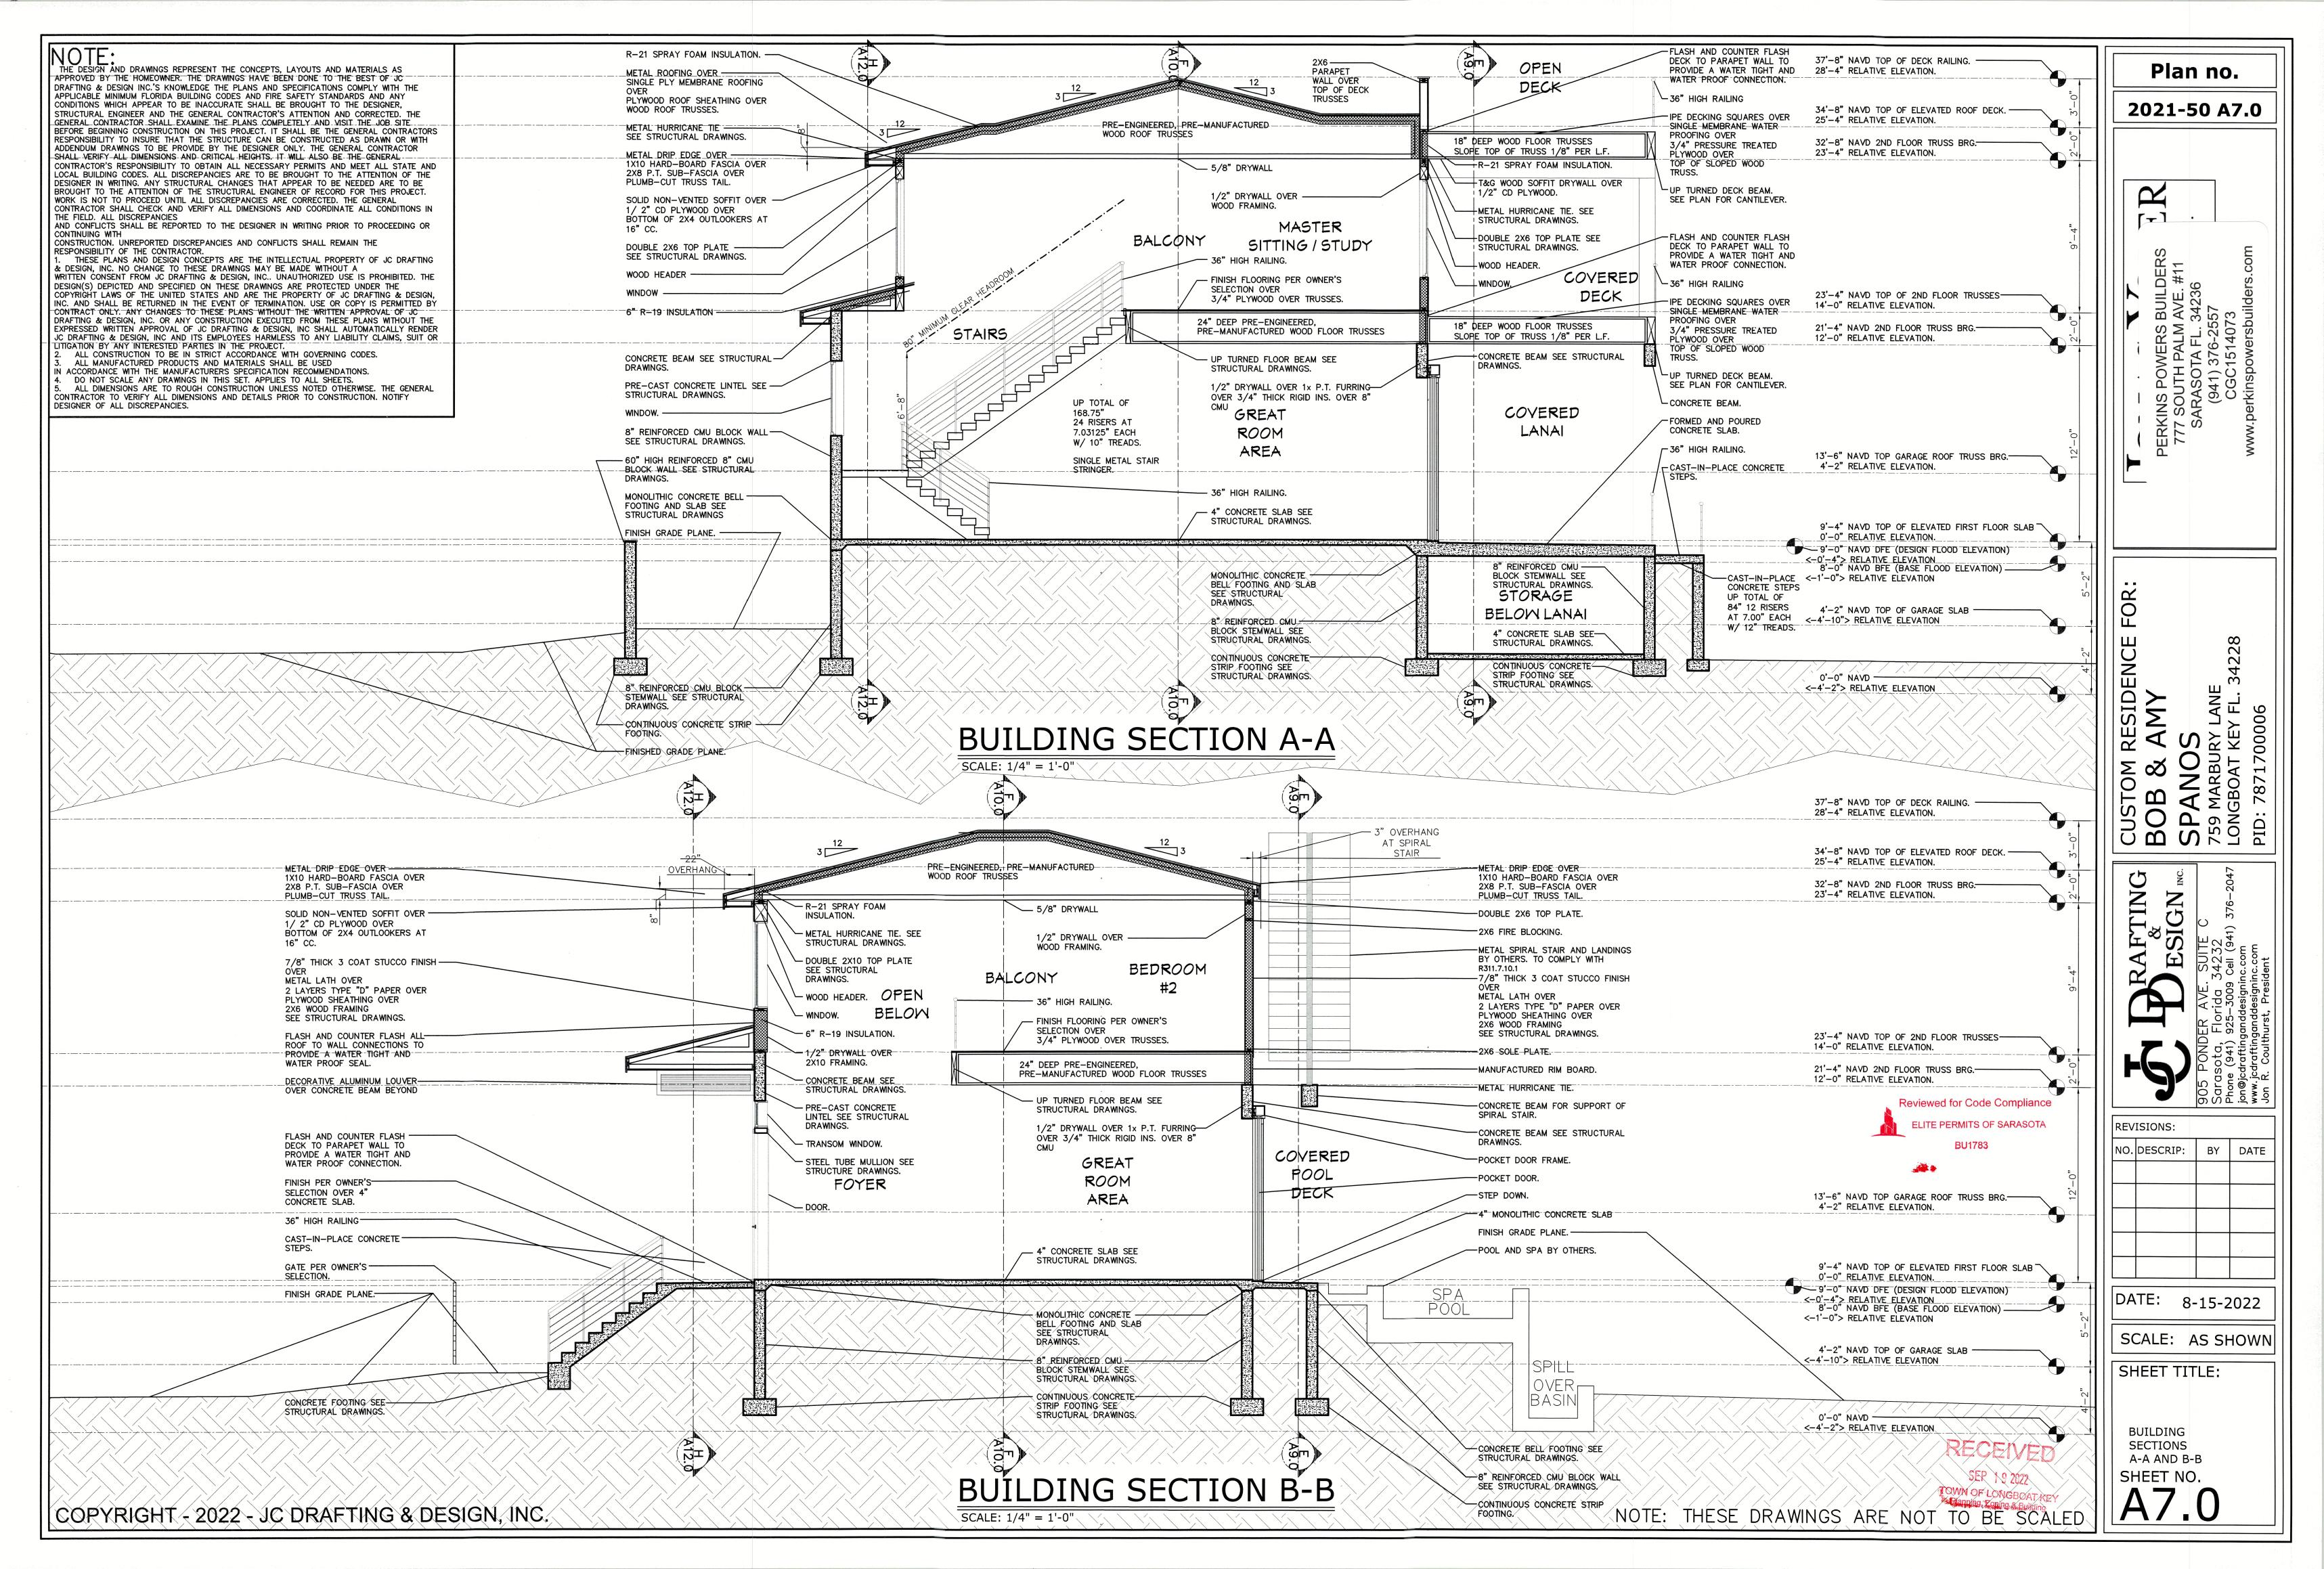
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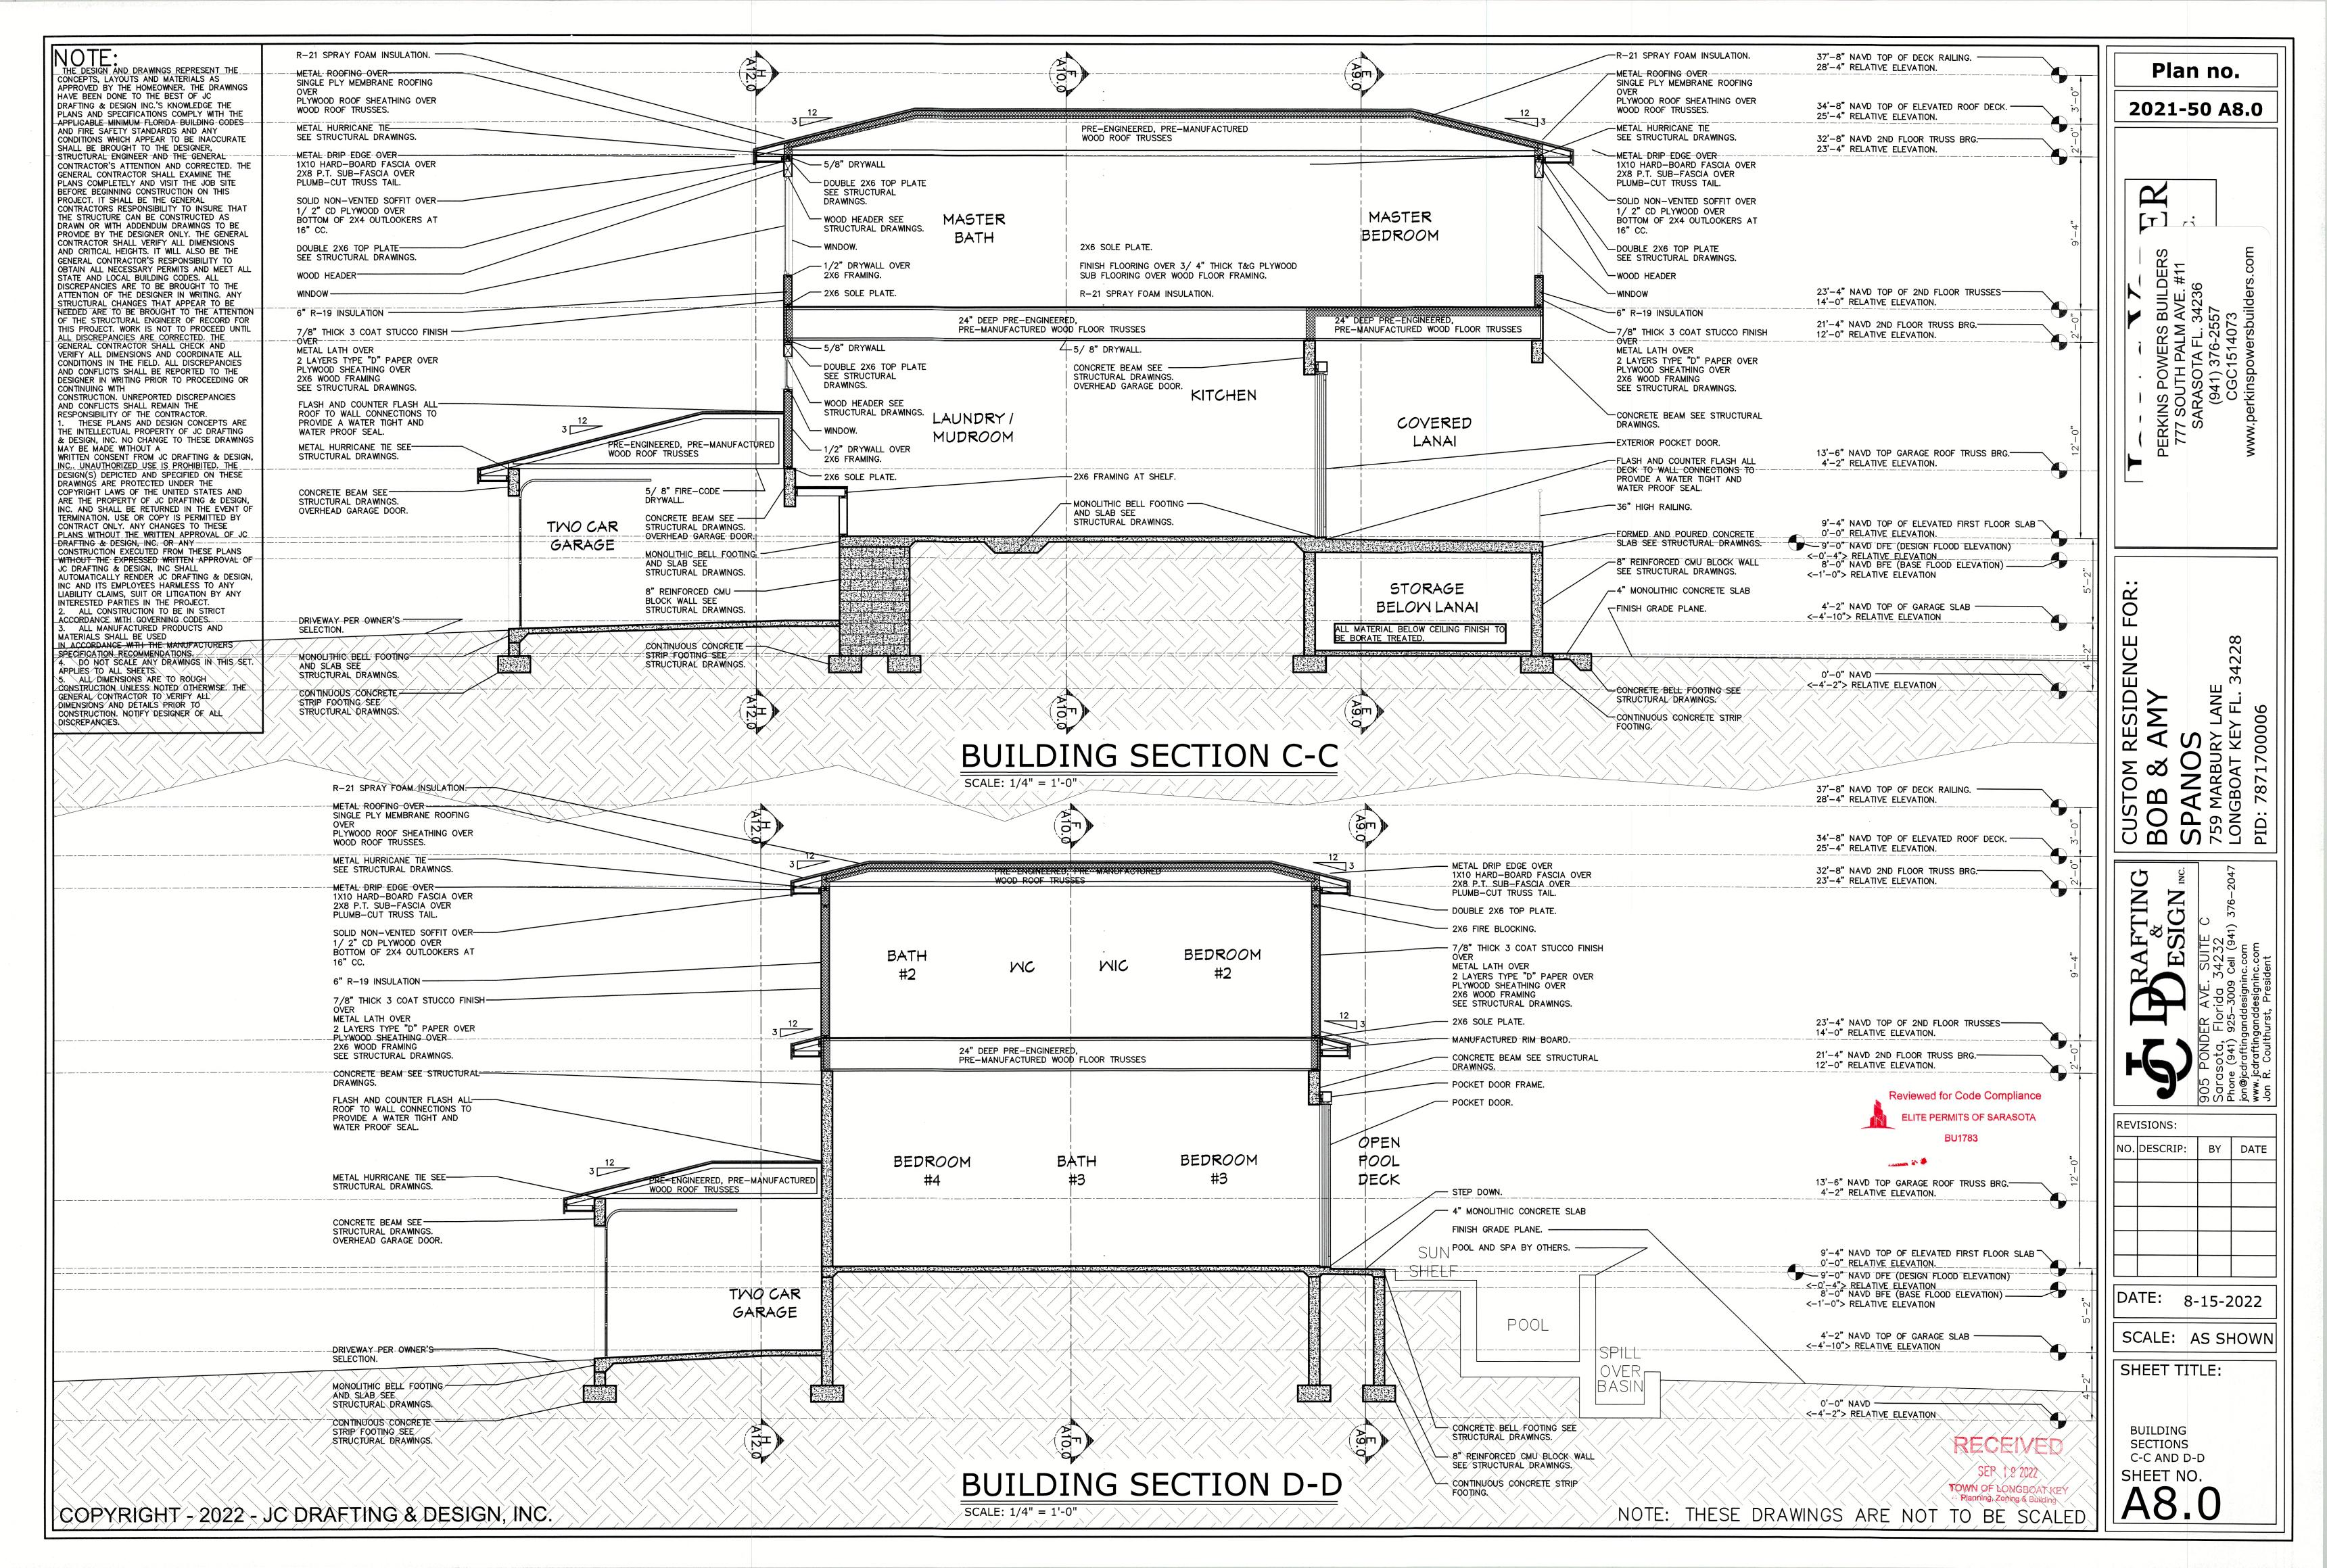
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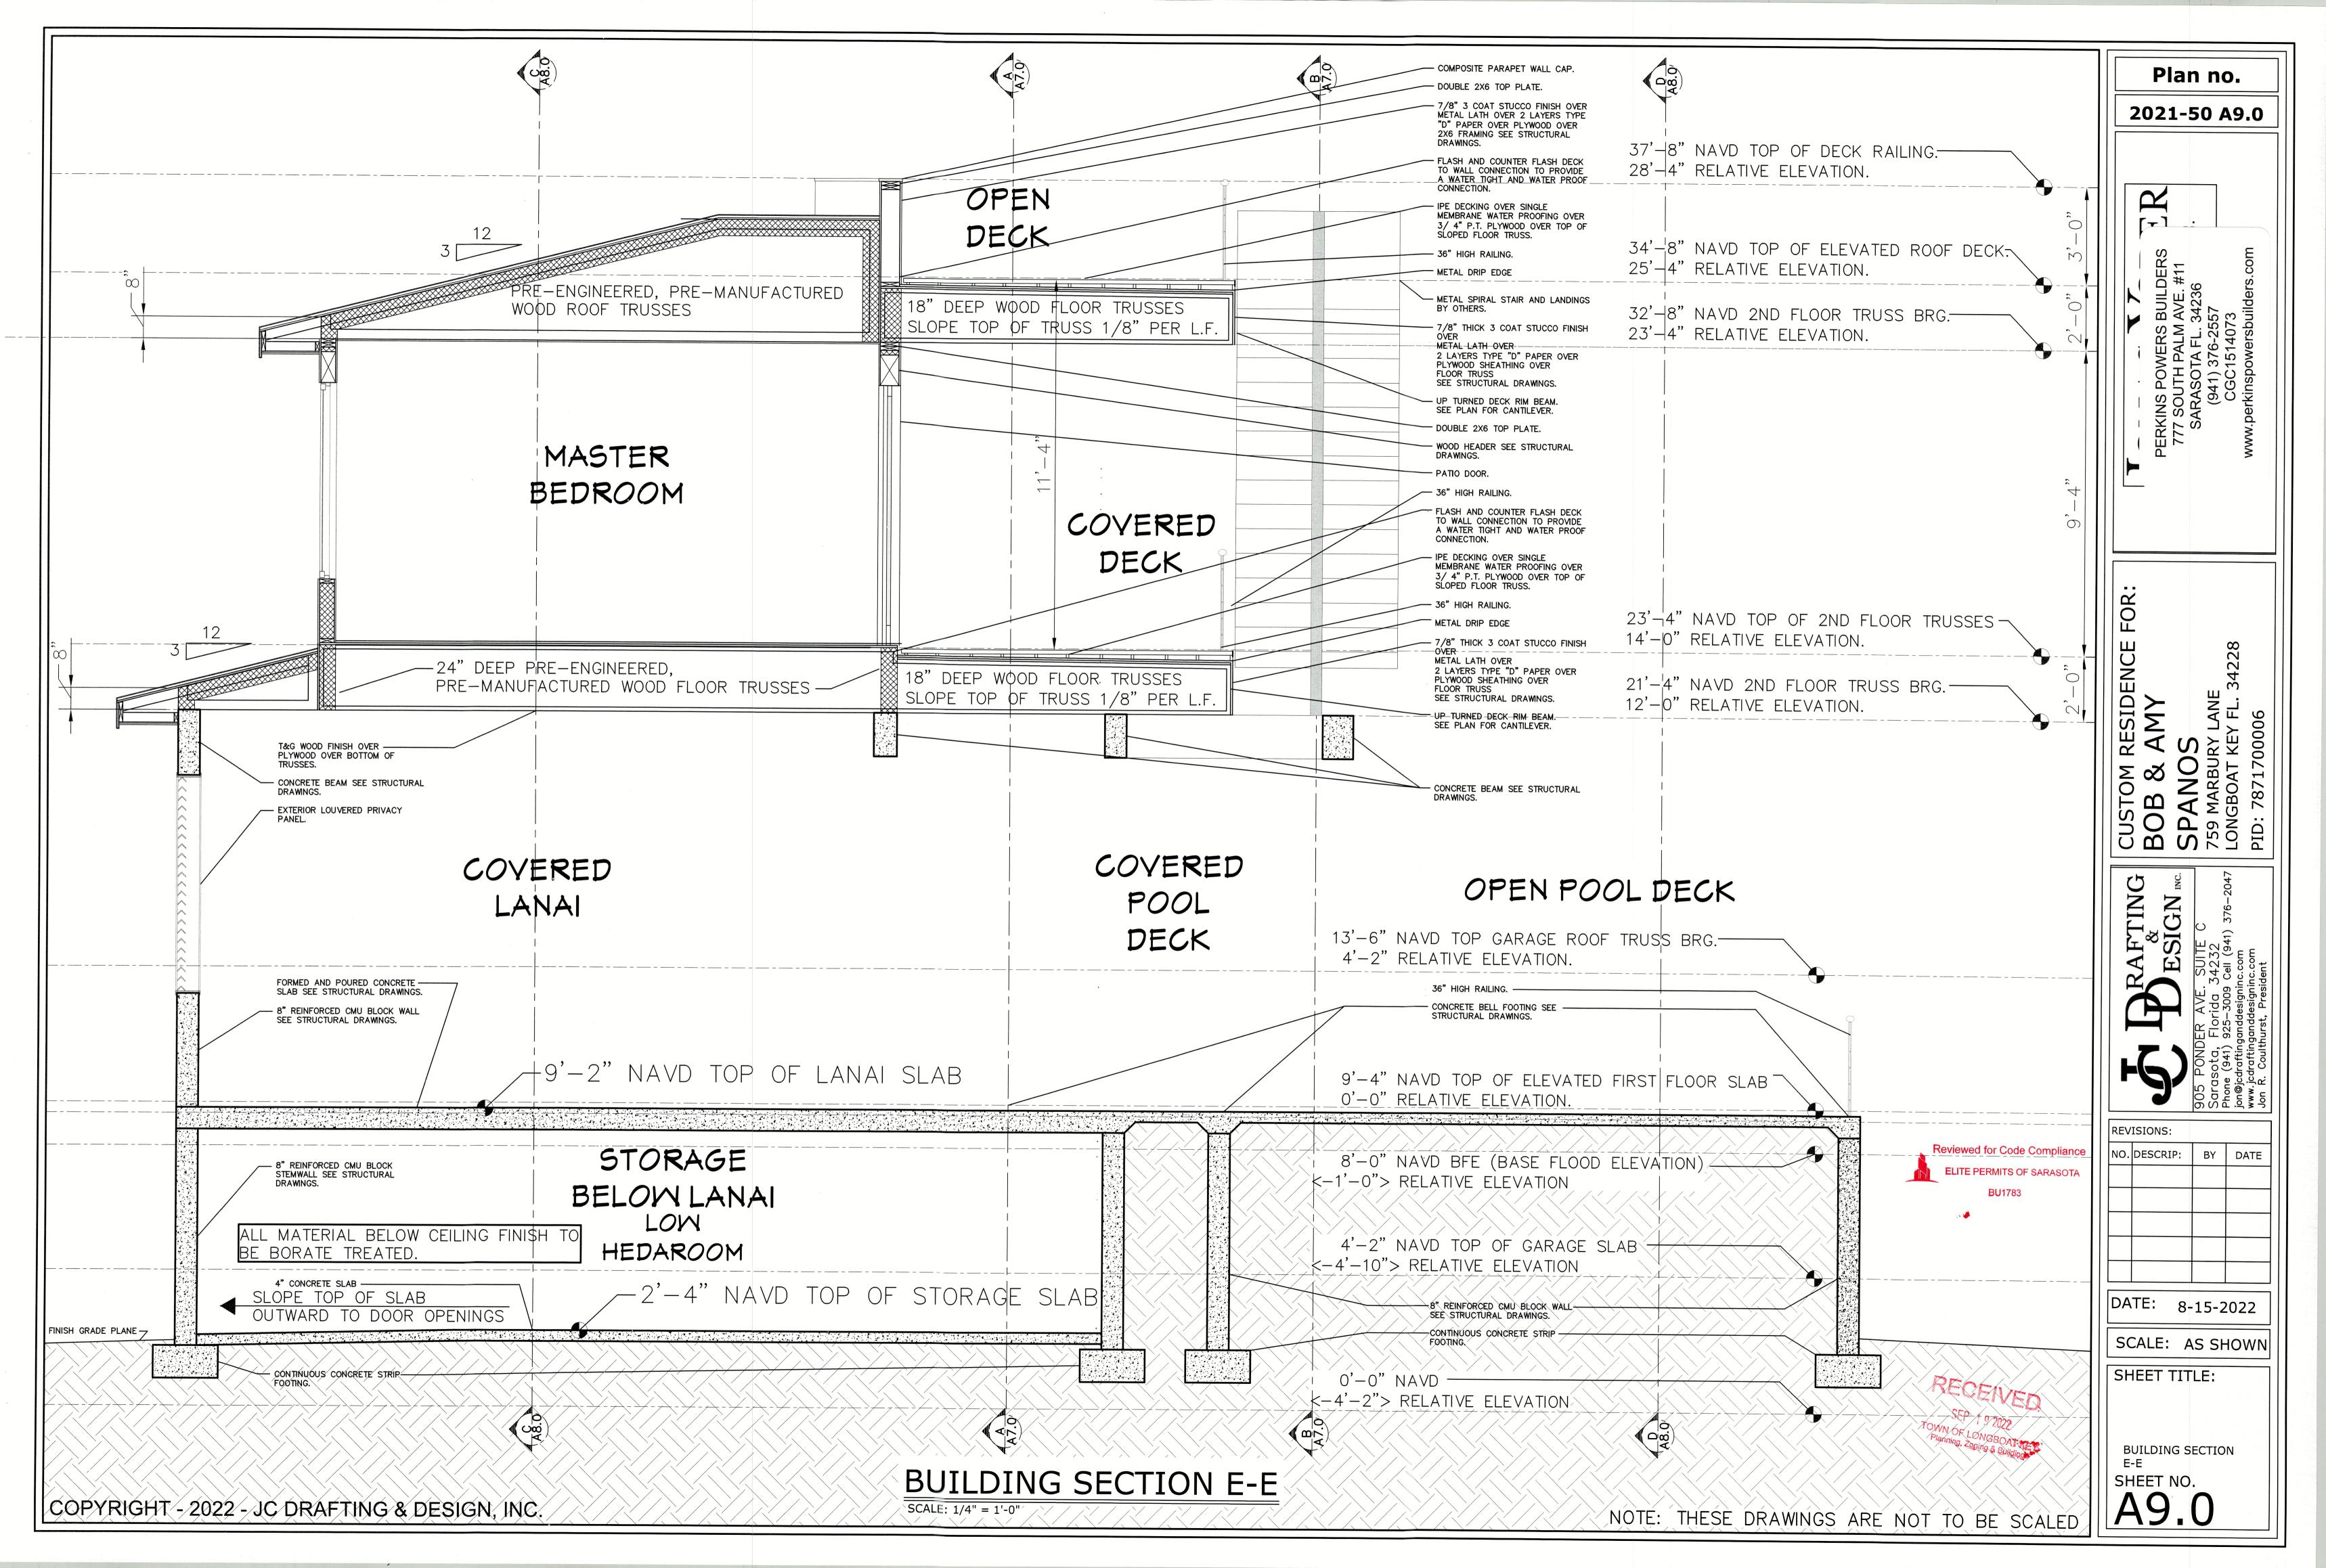
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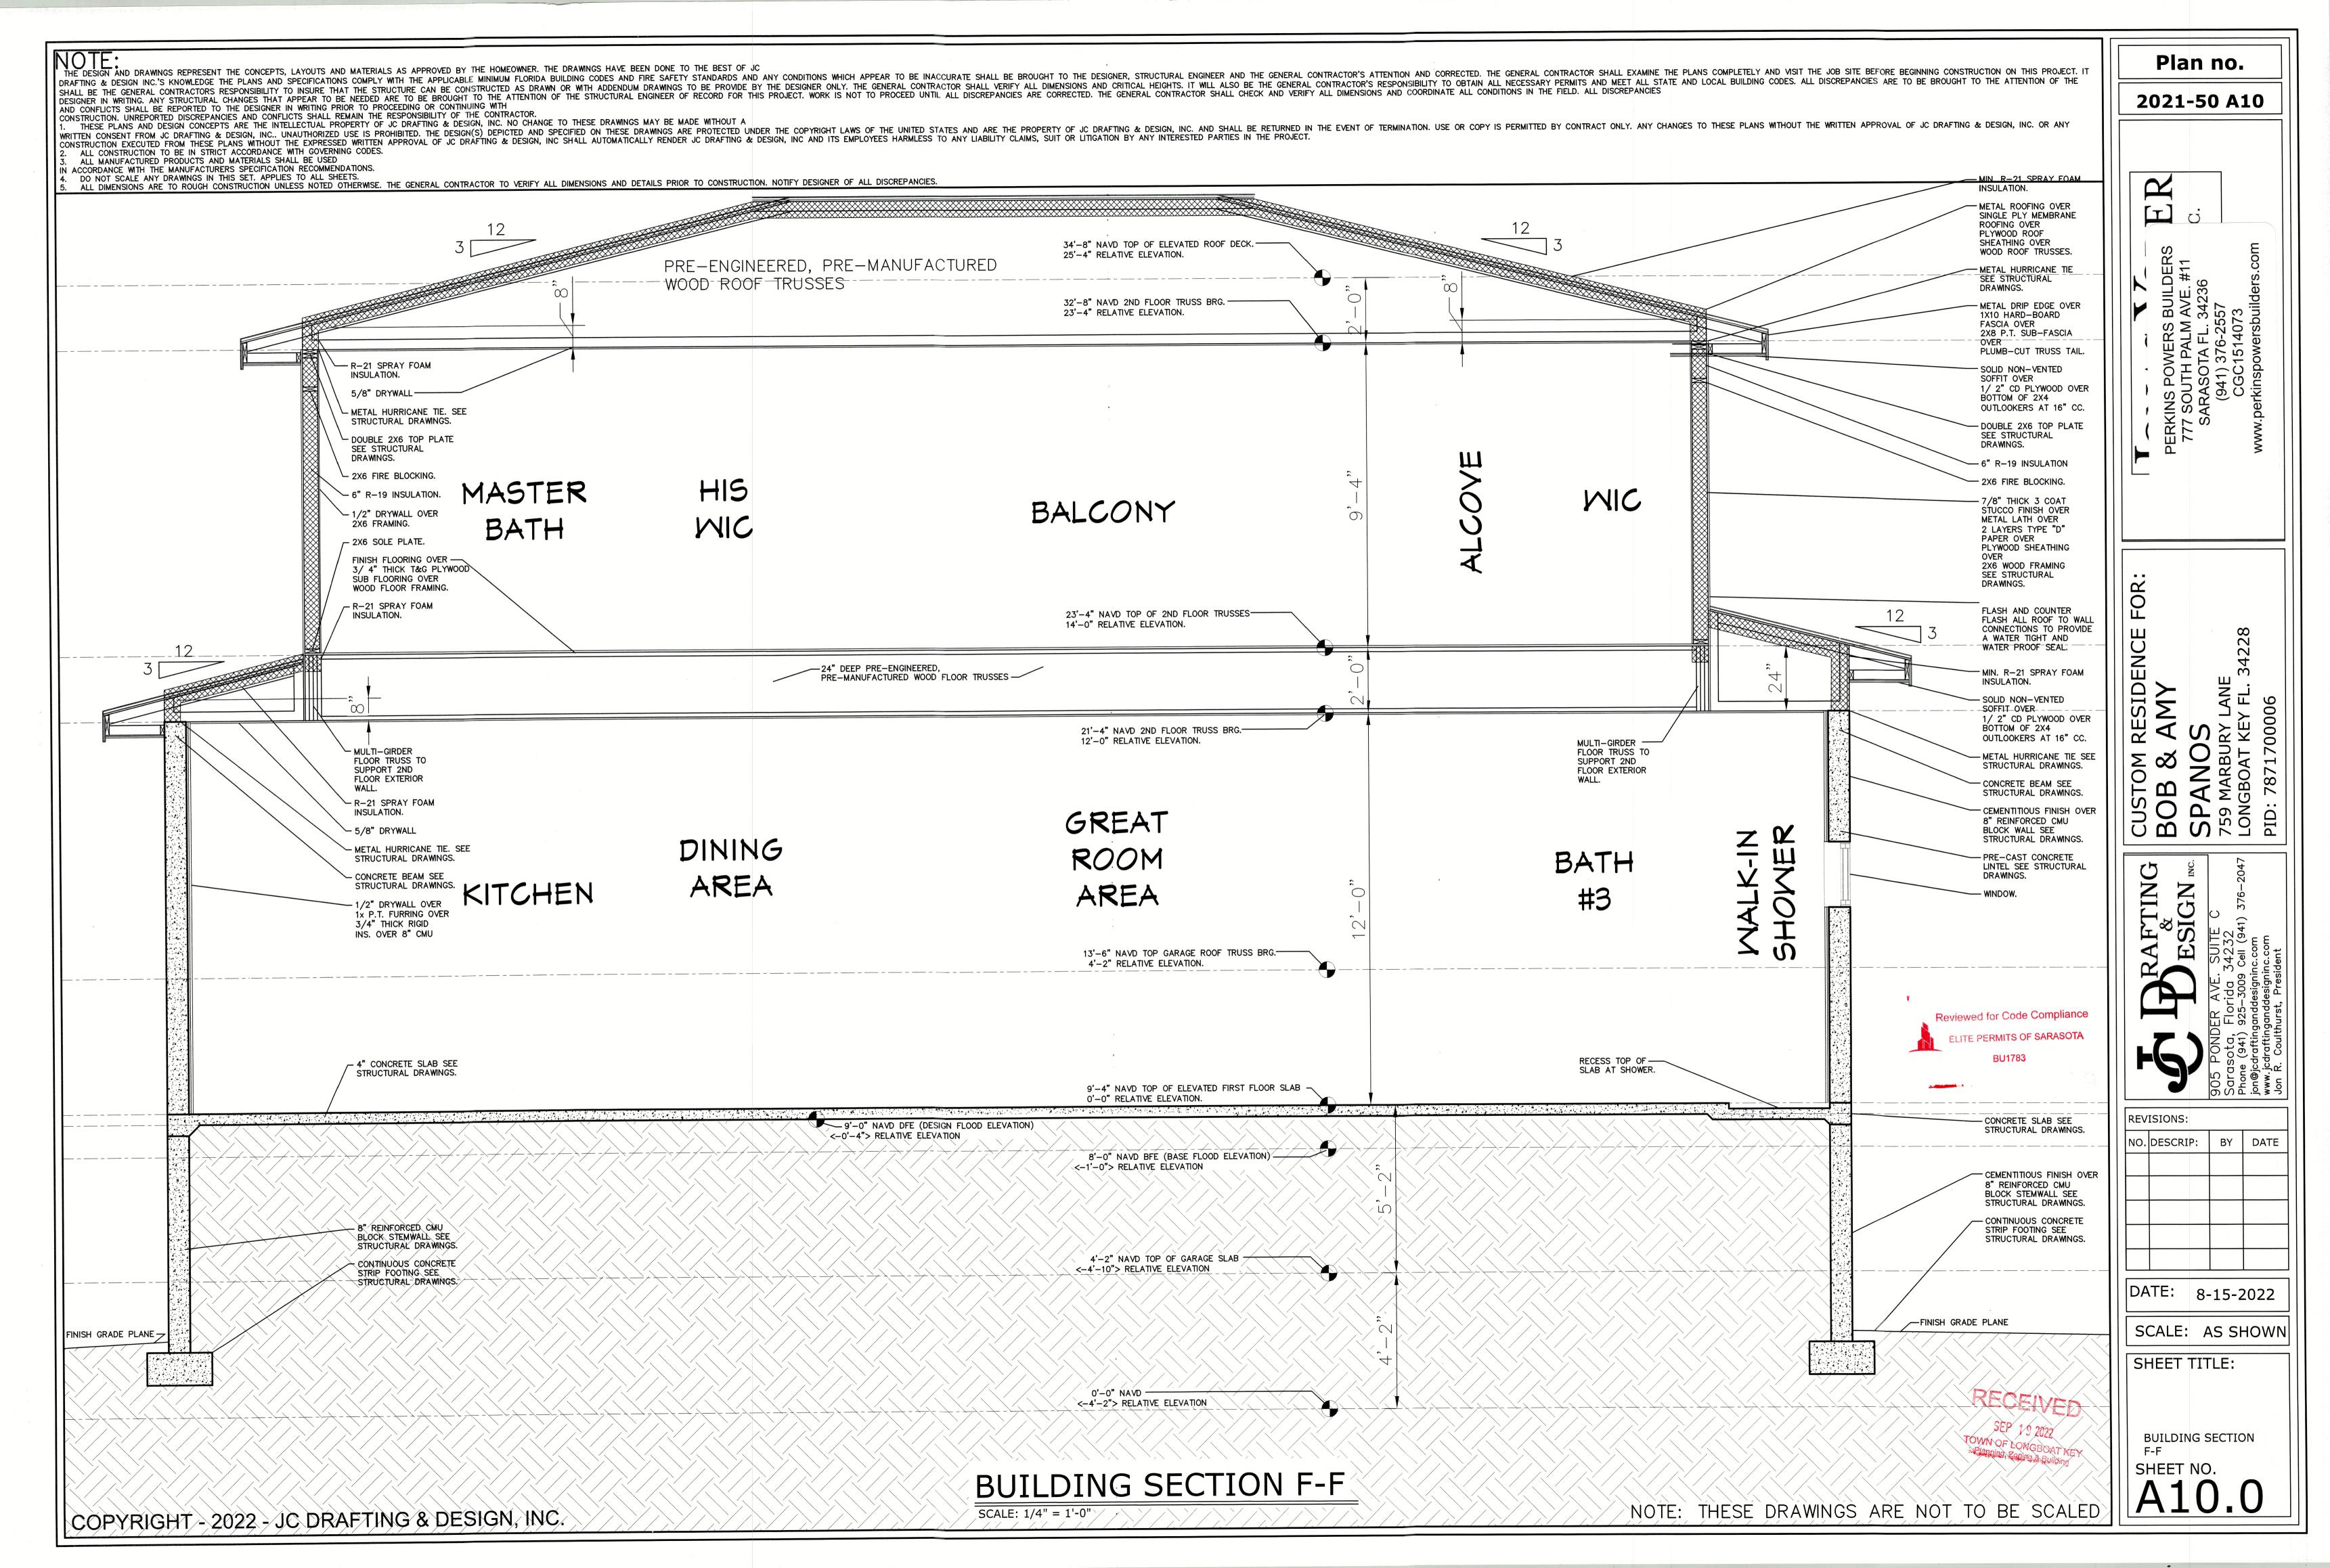











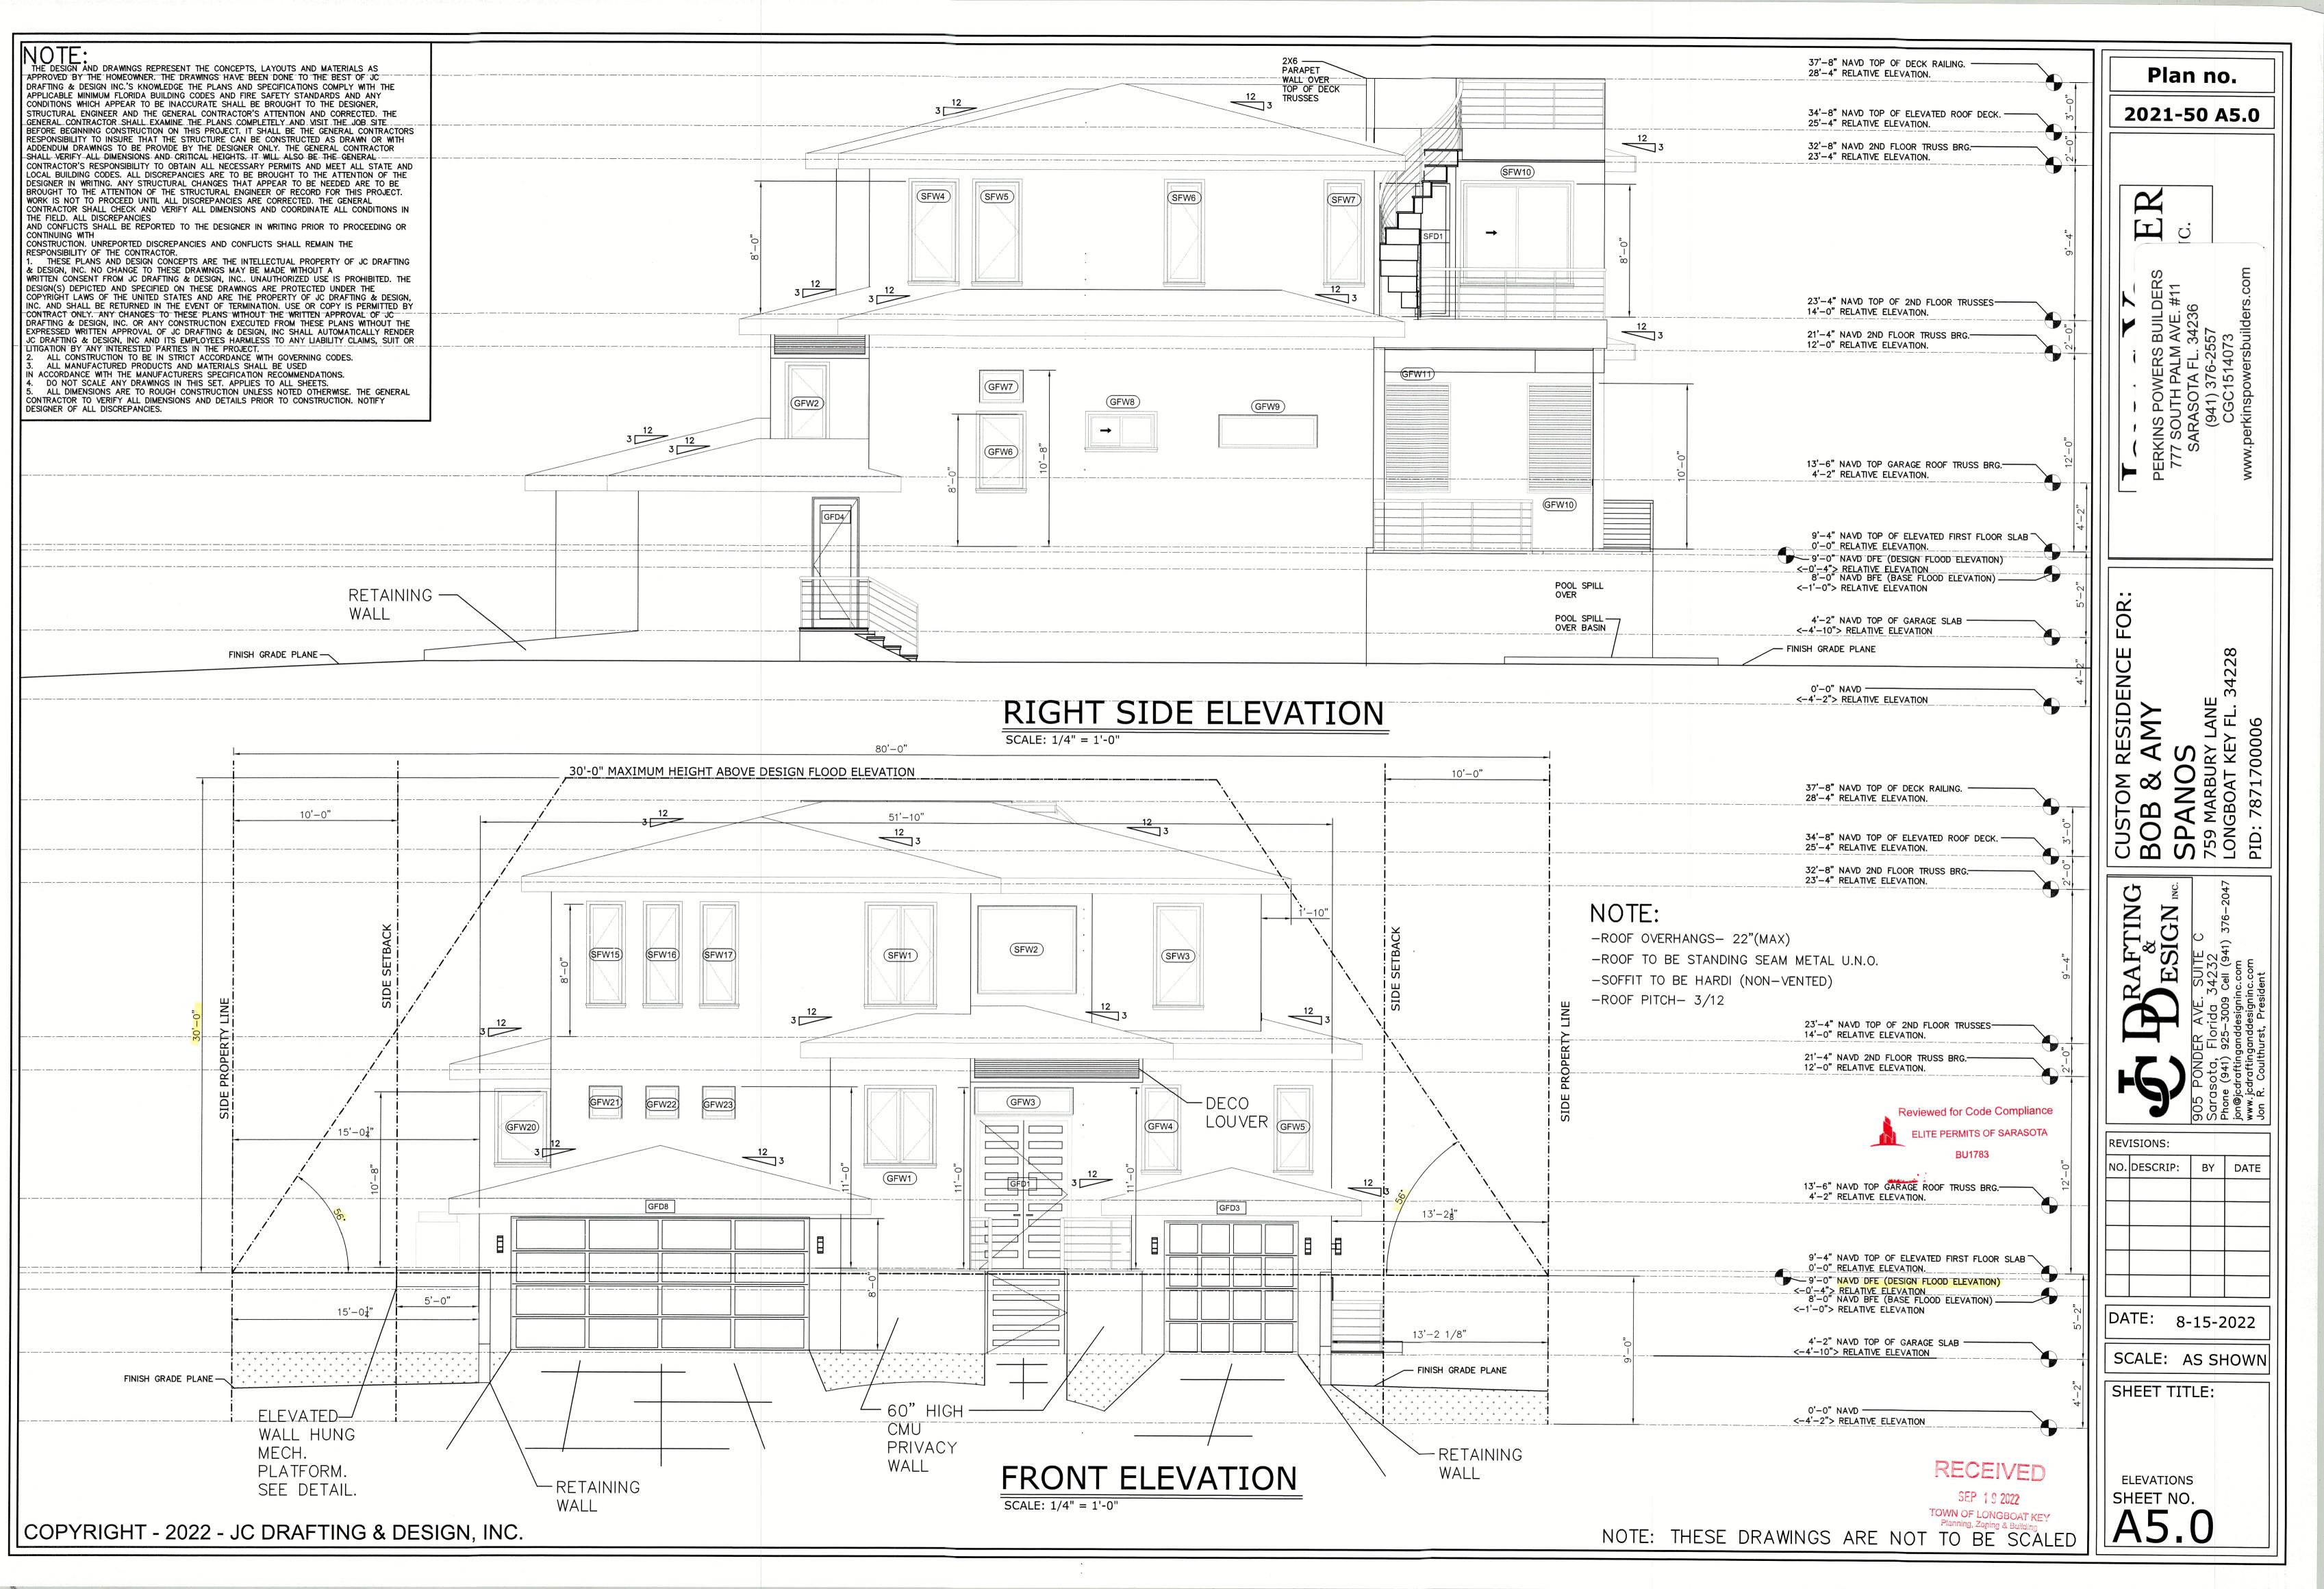

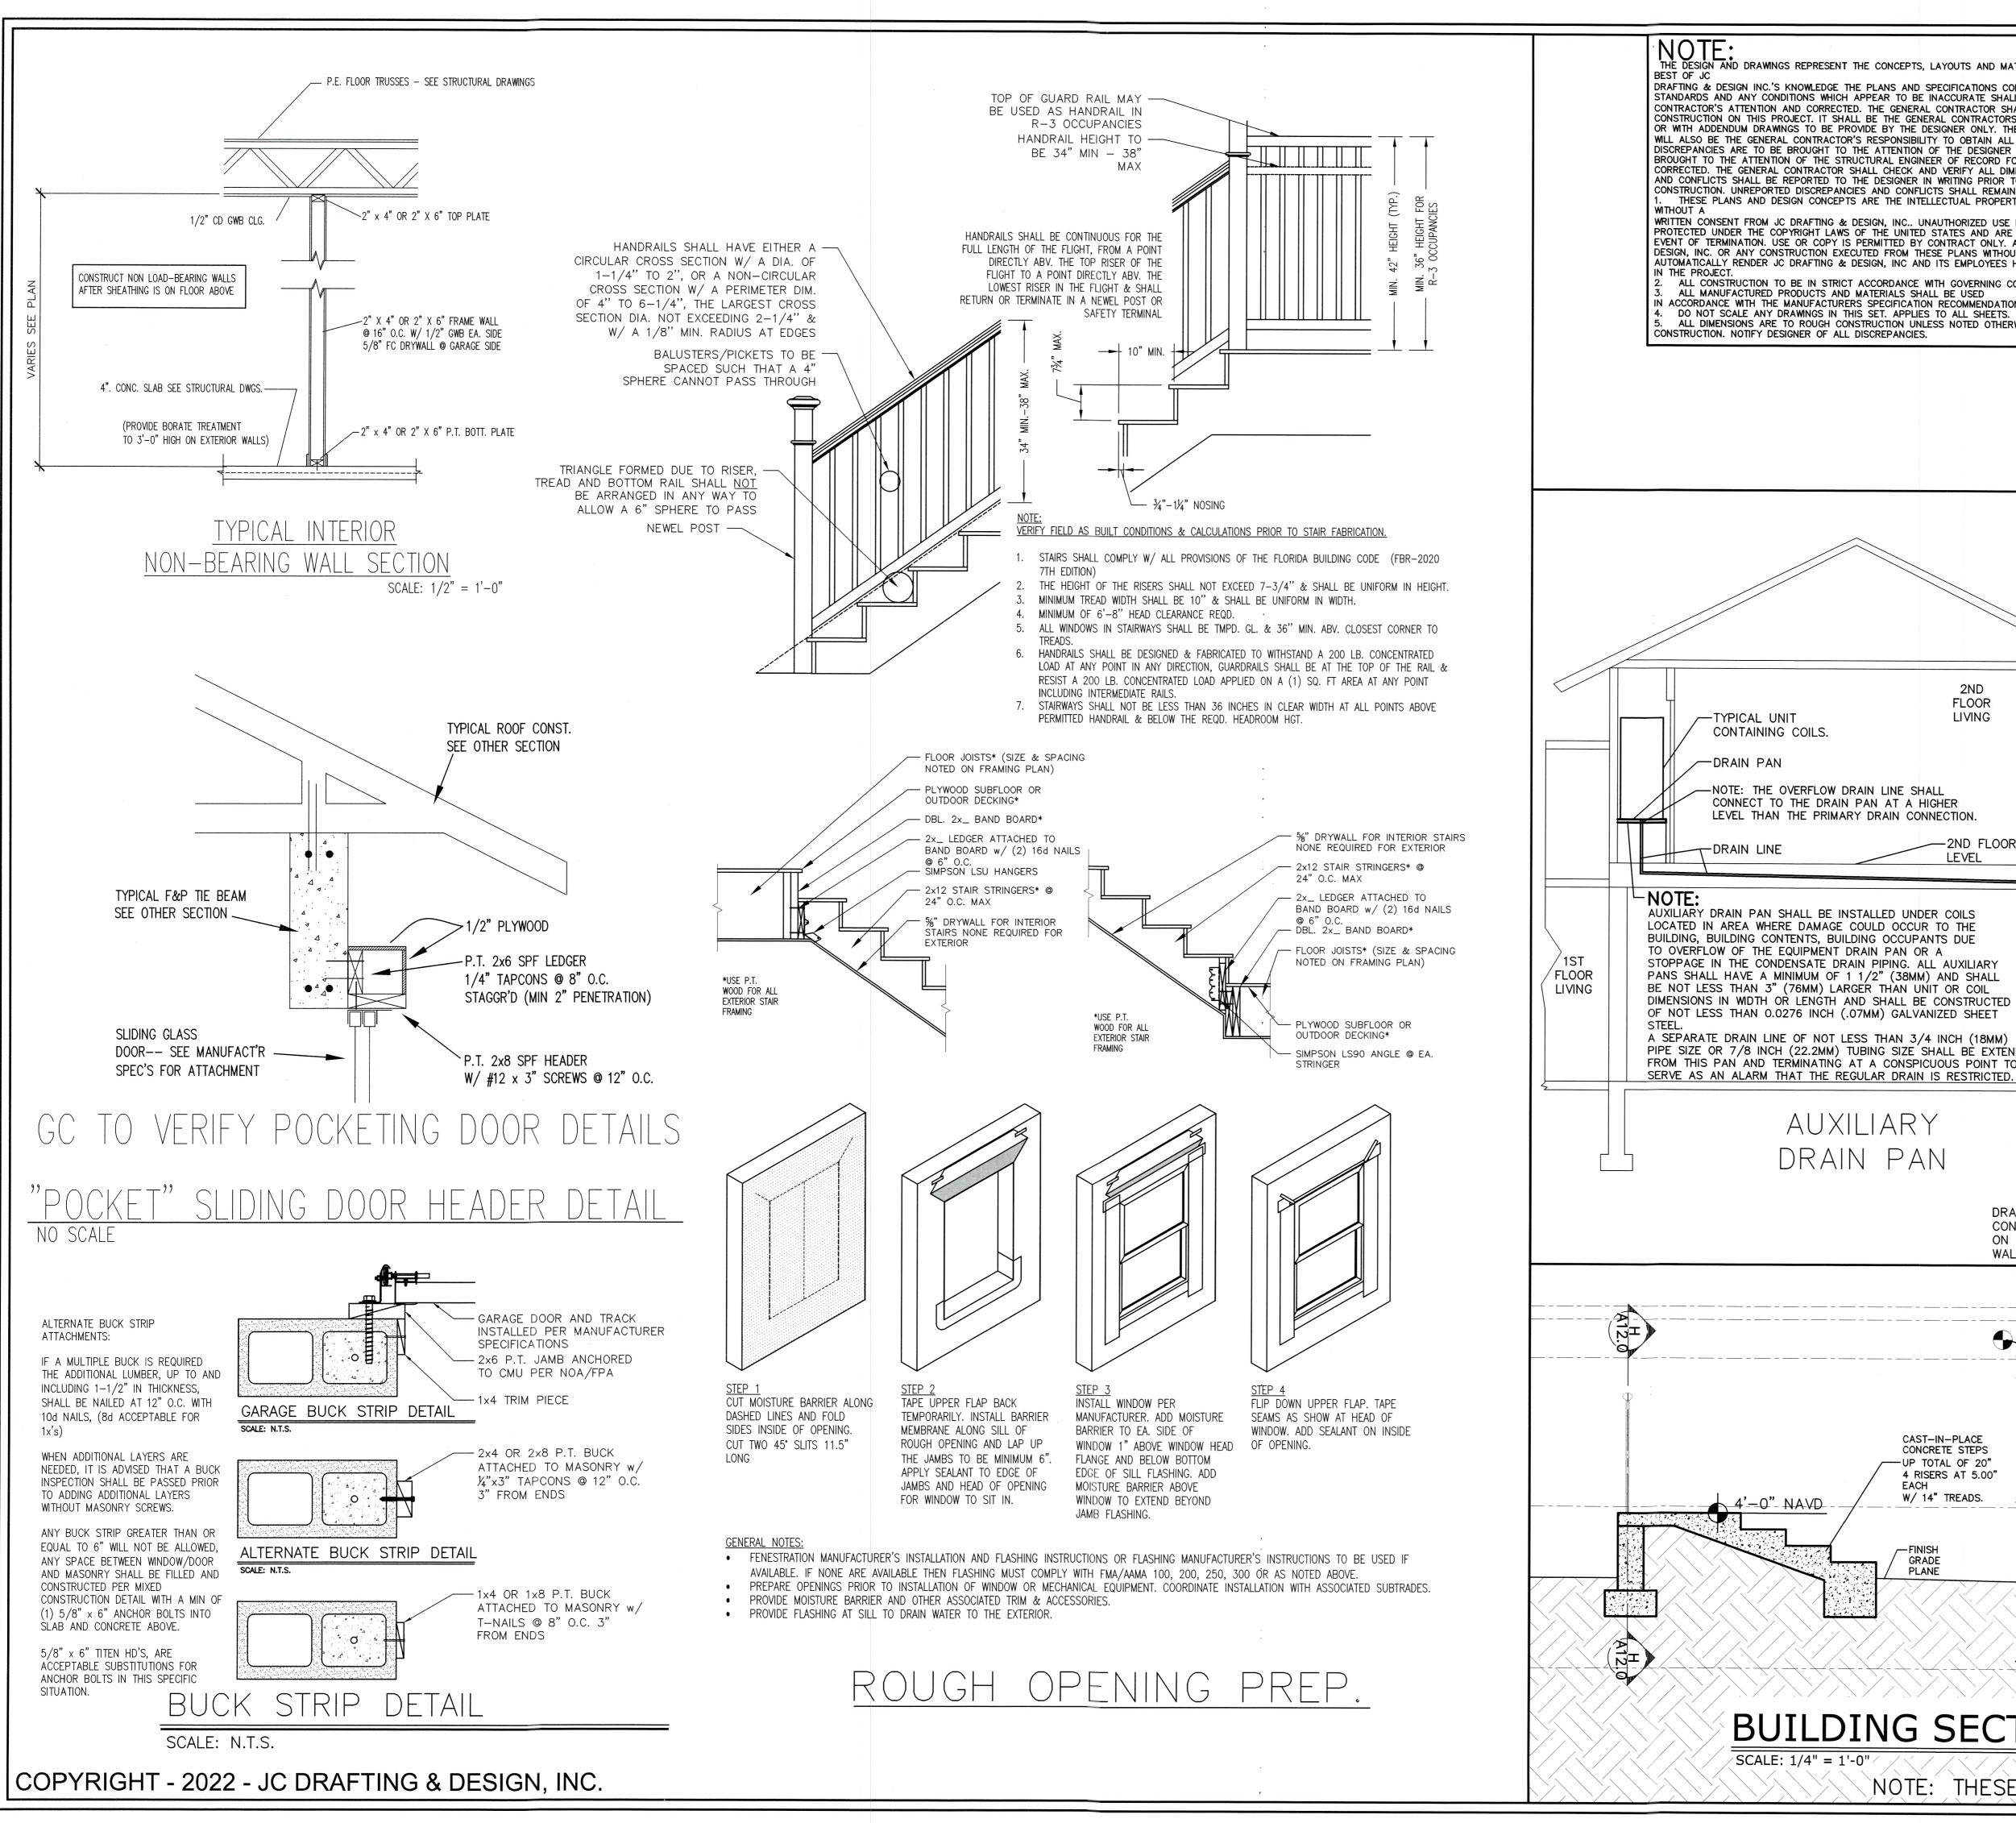

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2ND **FLOOR** LIVING TYPICAL UNIT CONTAINING COILS -NOTE: THE OVERFLOW DRAIN LINE SHALL CONNECT TO THE DRAIN PAN AT A HIGHER LEVEL THAN THE PRIMARY DRAIN CONNECTION. -2ND FLOOR LEVEL AUXILIARY DRAIN PAN SHALL BE INSTALLED UNDER COILS LOCATED IN AREA WHERE DAMAGE COULD OCCUR TO THE BUILDING, BUILDING CONTENTS, BUILDING OCCUPANTS DUE TO OVERFLOW OF THE EQUIPMENT DRAIN PAN OR A STOPPAGE IN THE CONDENSATE DRAIN PIPING. ALL AUXILIARY PANS SHALL HAVE A MINIMUM OF 1 1/2" (38MM) AND SHALL BE NOT LESS THAN 3" (76MM) LARGER THAN UNIT OR COIL DIMENSIONS IN WIDTH OR LENGTH AND SHALL BE CONSTRUCTED OF NOT LESS THAN 0.0276 INCH (.07MM) GALVANIZED SHEET A SEPARATE DRAIN LINE OF NOT LESS THAN 3/4 INCH (18MM) PIPE SIZE OR 7/8 INCH (22.2MM) TUBING SIZE SHALL BE EXTENDED FROM THIS PAN AND TERMINATING AT A CONSPICUOUS POINT TO SERVE AS AN ALARM THAT THE REGULAR DRAIN IS RESTRICTED AUXILIARY DRAIN PAN

GUARD RAIL & STAIR HAND-**RAIL SYSTEM NOTES:** HANDRAILS:

HEIGHT MEASURED VERTICALLY FROM THE TOP OF ALL FINISH SURFACES INCLUDING THE OUT-SIDE EDGE OF ALL STAIR TREAD NOSINGS AND SHALL BE NOT LESS THAN 34" AND NOT MORE THE 38" INCHES. RAILINGS SHALL BE PERMITTED TO BE INTERRUPTED BY A NEWEL POST AT THE TURN. THE USE OF A VOLUTE, TURNOUT, STARTING

EASING OR STARTING NEWEL SHALL BE ALLOWED OVER THE LOWEST TREAD. **EXCEPTIONS:** RAILINGS FOR STAIRWAYS SHALL BE CONTINUOUS FOR THE FULL HEIGHT OF THE FLIGHT, FROM

A POINT DIRECTLY ABOVE THE TOP OF THE FLIGHT TO A POINT DIRECTLY ABOVE THE LOWEST RISER OF THE FLIGHT. HANDRAIL ENDS SHALL BE RETURNED OR SHALL TERMINATE IN NEWEL POSTS OR SAFETY TERMINALS. HANDRAILS ADJACENT TO A WALL SHALL HAVE A SPACE OF NOT LESS THAN 1 1/2 INCH BETWEEN THE WALL AND THE

HANDRAIL GRIP SIZE: RAILINGS TO BE CIRCULAR SHALL HAVE A MIN. OUTSIDE DIAMETER OF 1 1/4 INCHES AND NOT GREATER THAN 2" RAILINGS TO NOT BE CIRCULAR SHALL HAVE A PERIMETER DIMENSION OF AT LEAST 4 INCHES AND NOT GREATER THEN 6 1/4 INCHES WITH A MAXIMUM CROSS SECTION OF DIMENSION OF

2 1/4 INCHES. BALUSTERS: SPACES BETWEEN ANY BALUSTER TO BE SO THAT A 4" OR GREATER SPHERE CAN NOT PASS THROUGH OPENING.


BOTTOM RAILINGS: SPACES BETWEEN ANY BOTTOM RAILING AND TOP OF FINISH SURFACE TO BE SO THAT A 2" OR GREATER SPHERE CAN NOT PASS THROUGH OPENING.

BOTTOM RAILINGS @ STAIRS: TRIANGULAR SPACES FORMED BY THE BOTTOM OF THE BOTTOM RAILING, TOP OF THE STAIR TREAD AND SIDE OF THE STAIR RISER TO BE SO THAT A 6" OR GREATER SPHERE CAN NOT PASS THROUGH OPENING MANUFACTURER & SUPPLIER:

ALL RAILINGS, BALUSTERS AND CONNECTORS ARE TO BE DESIGNED & SUPPLIED BY THE MANUFACTURER AND ARE NOT PART OF THESE

RAILING SYSTEMS SHALL BE DESIGNED AND CONSTRUCTED FOR A CONCENTRATED LOAD OF 200 Ib. APPLIED AT ANY POINT AND IN ANY DIRECTION AT THE TOP OF THE RAIL, AND 200 Ib. CONCENTRATED HORIZONTAL LOAD APPLIED ON A 1 SQ. FT. AREA AT ANY POINT IN THE SYSTEM, (LOADS NOT APPLIED SIMULTANEOUSLY.

* Planning, Zoning & Building

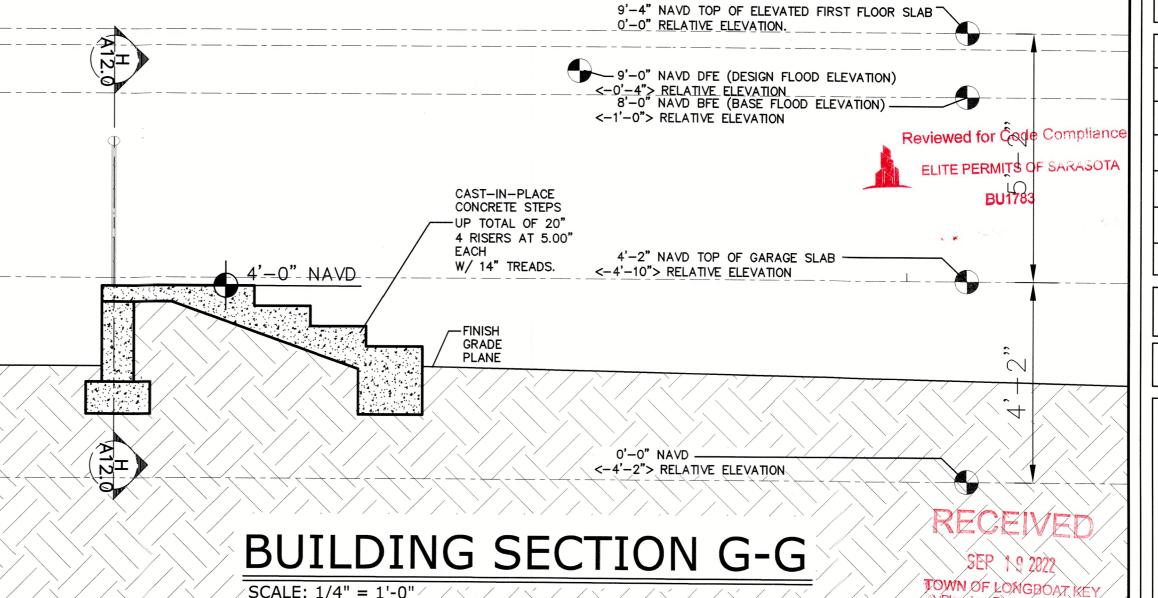

DRAIN LINE AT-

CONSPICUOUS POINT

ON EXISTING EXTERIOR

NOTE: THESE DRAWINGS ARE NOT TO BE SCALED

Plan no.

2021-50 A11.0

CUS BO SP/ 7591

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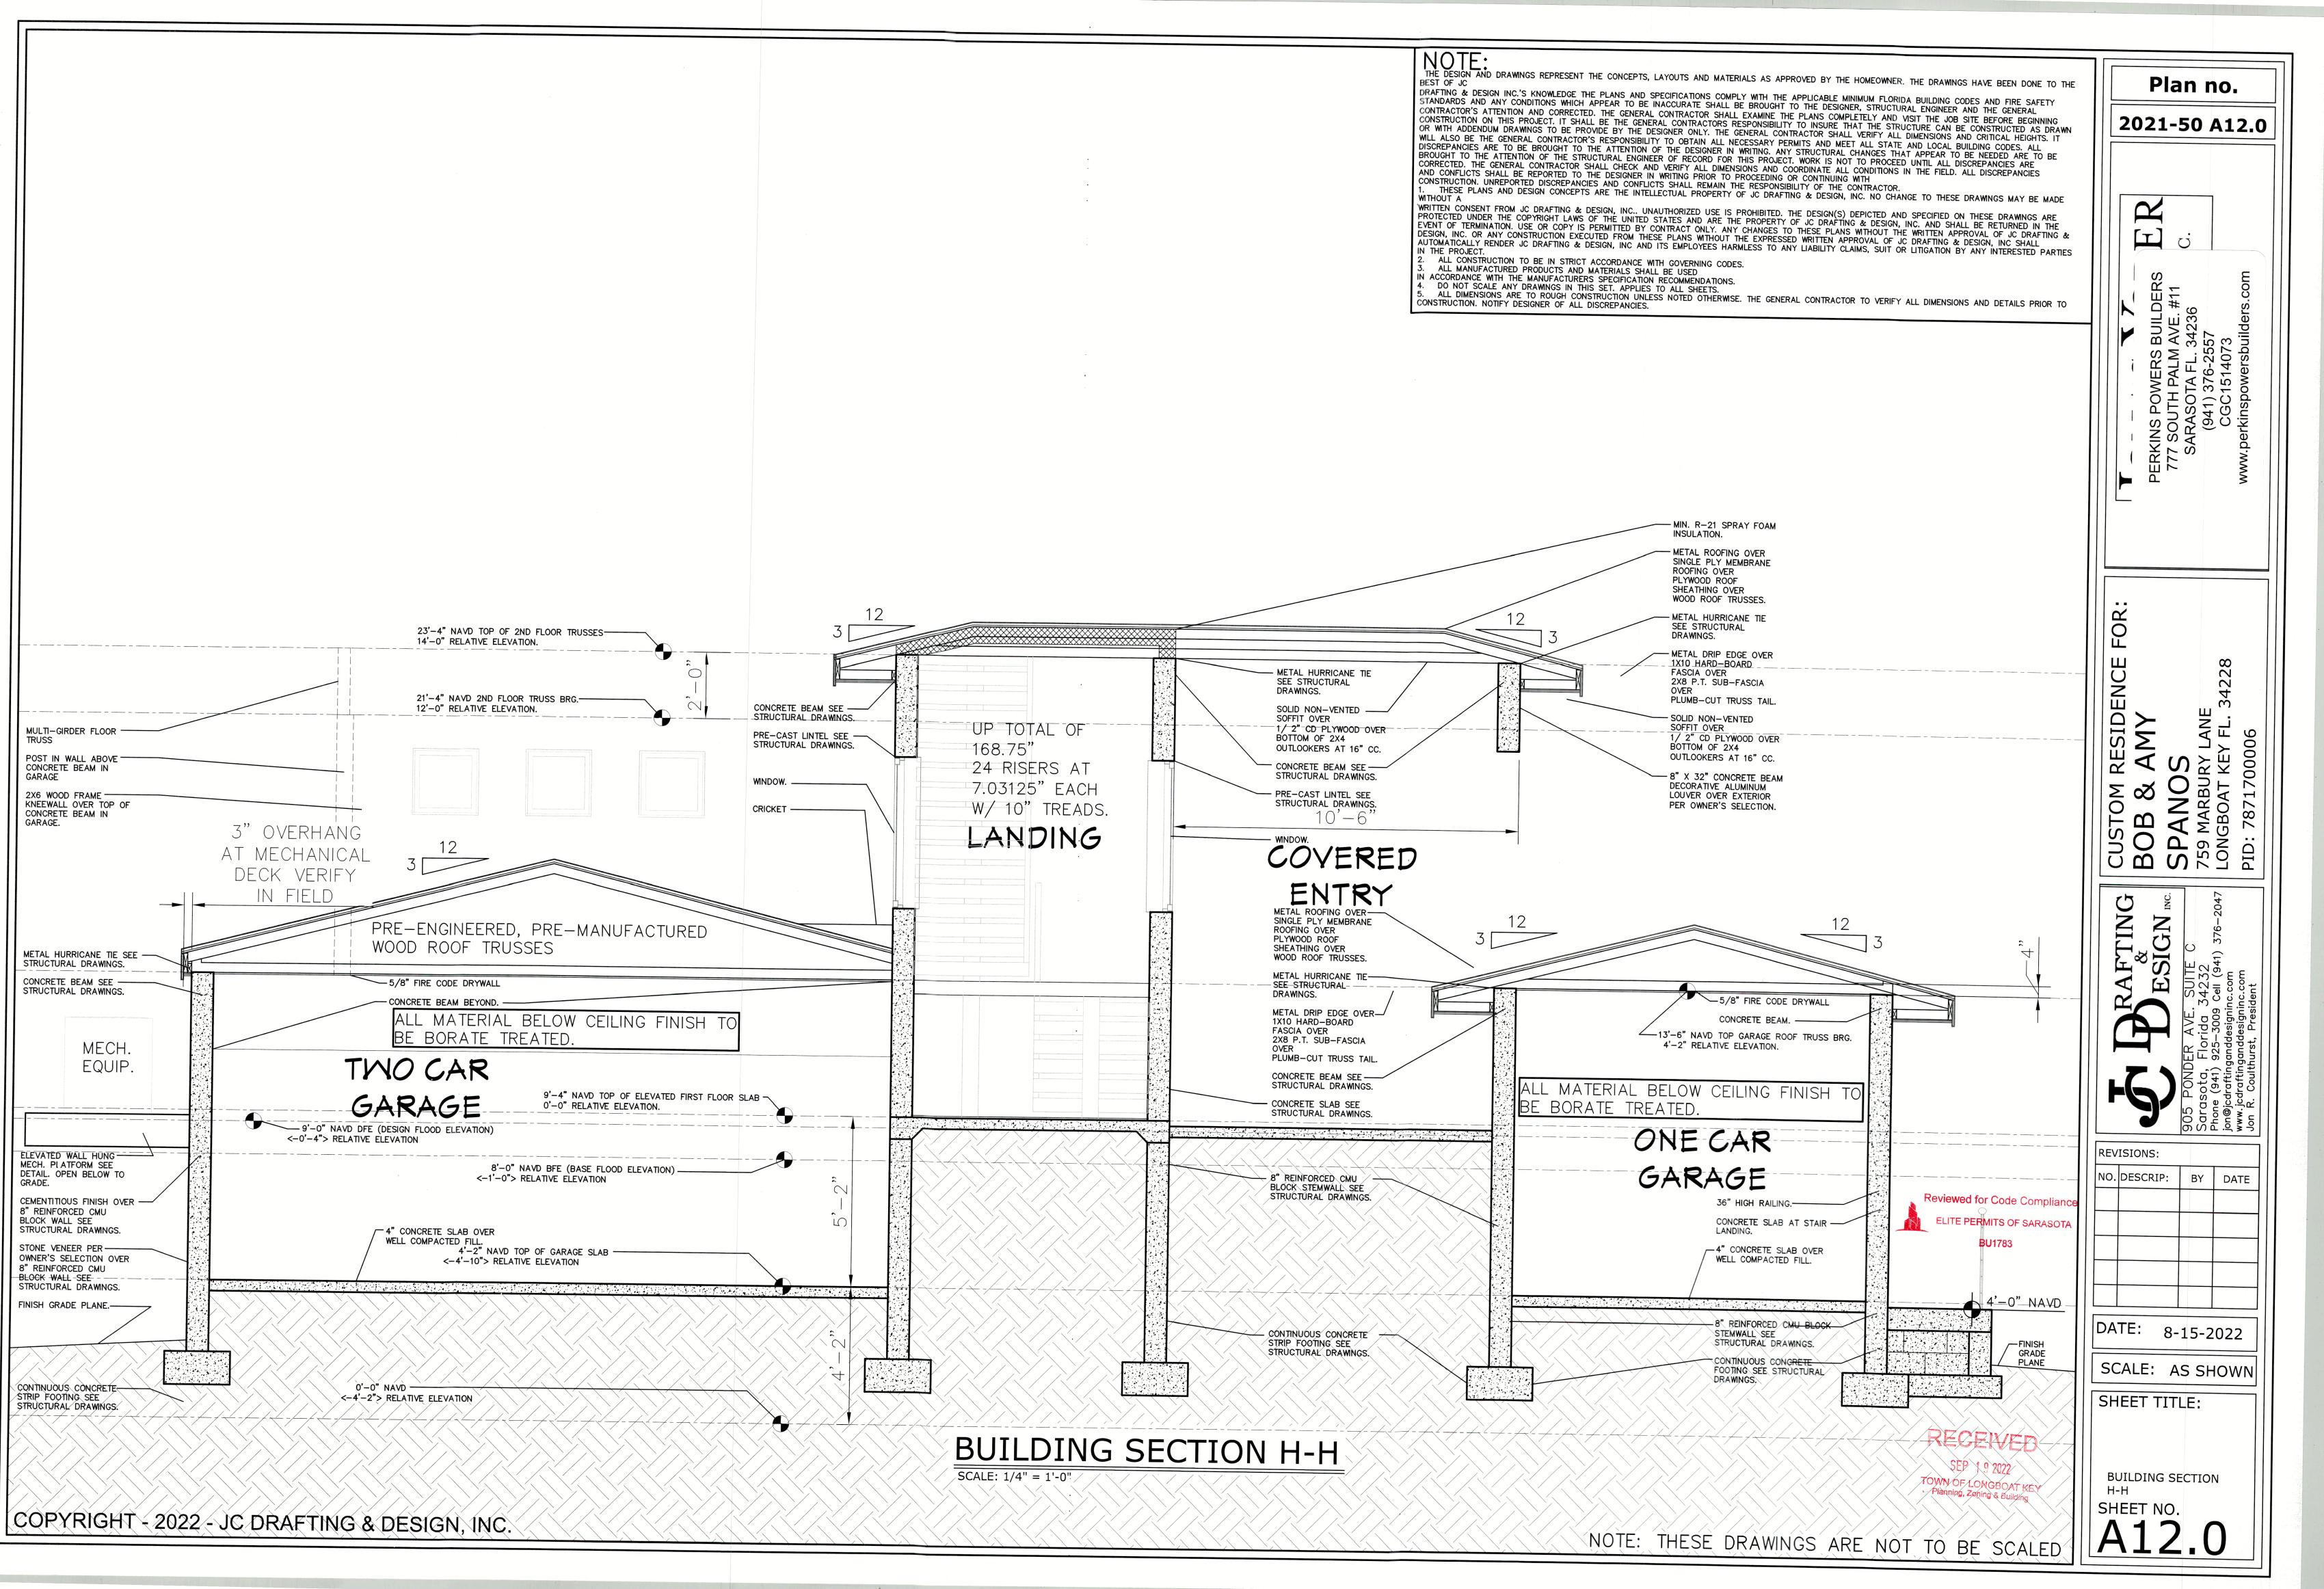
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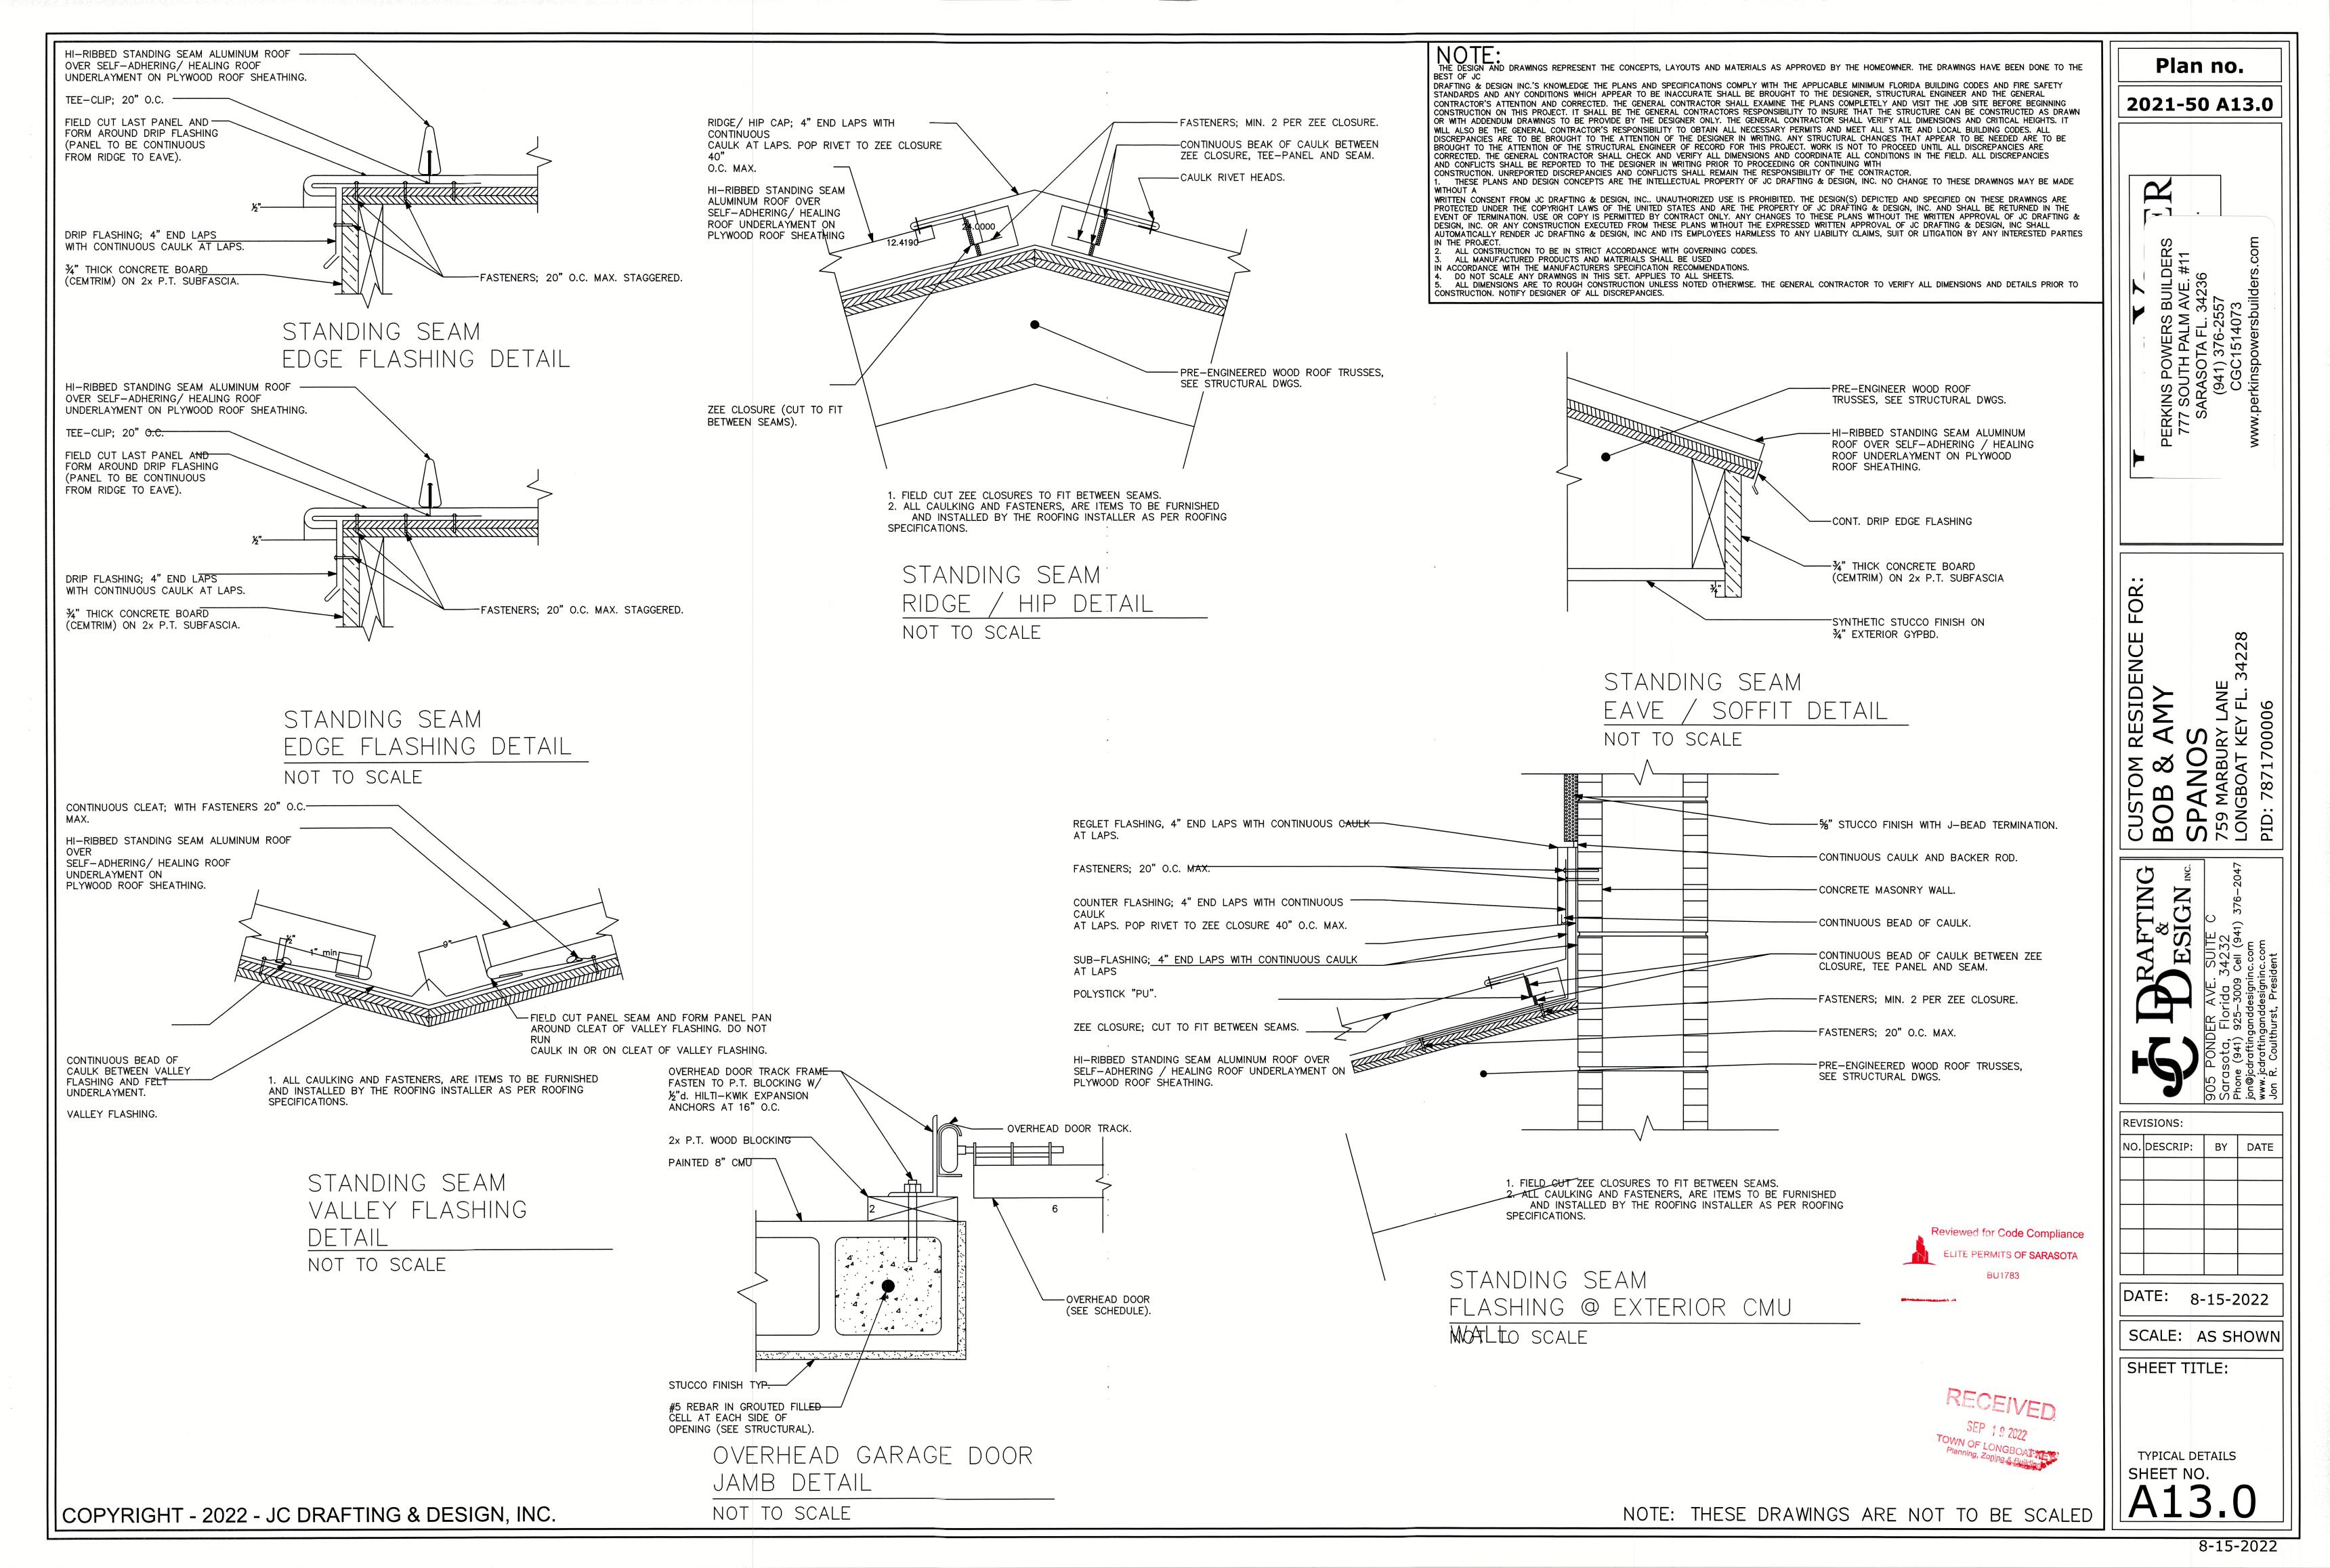
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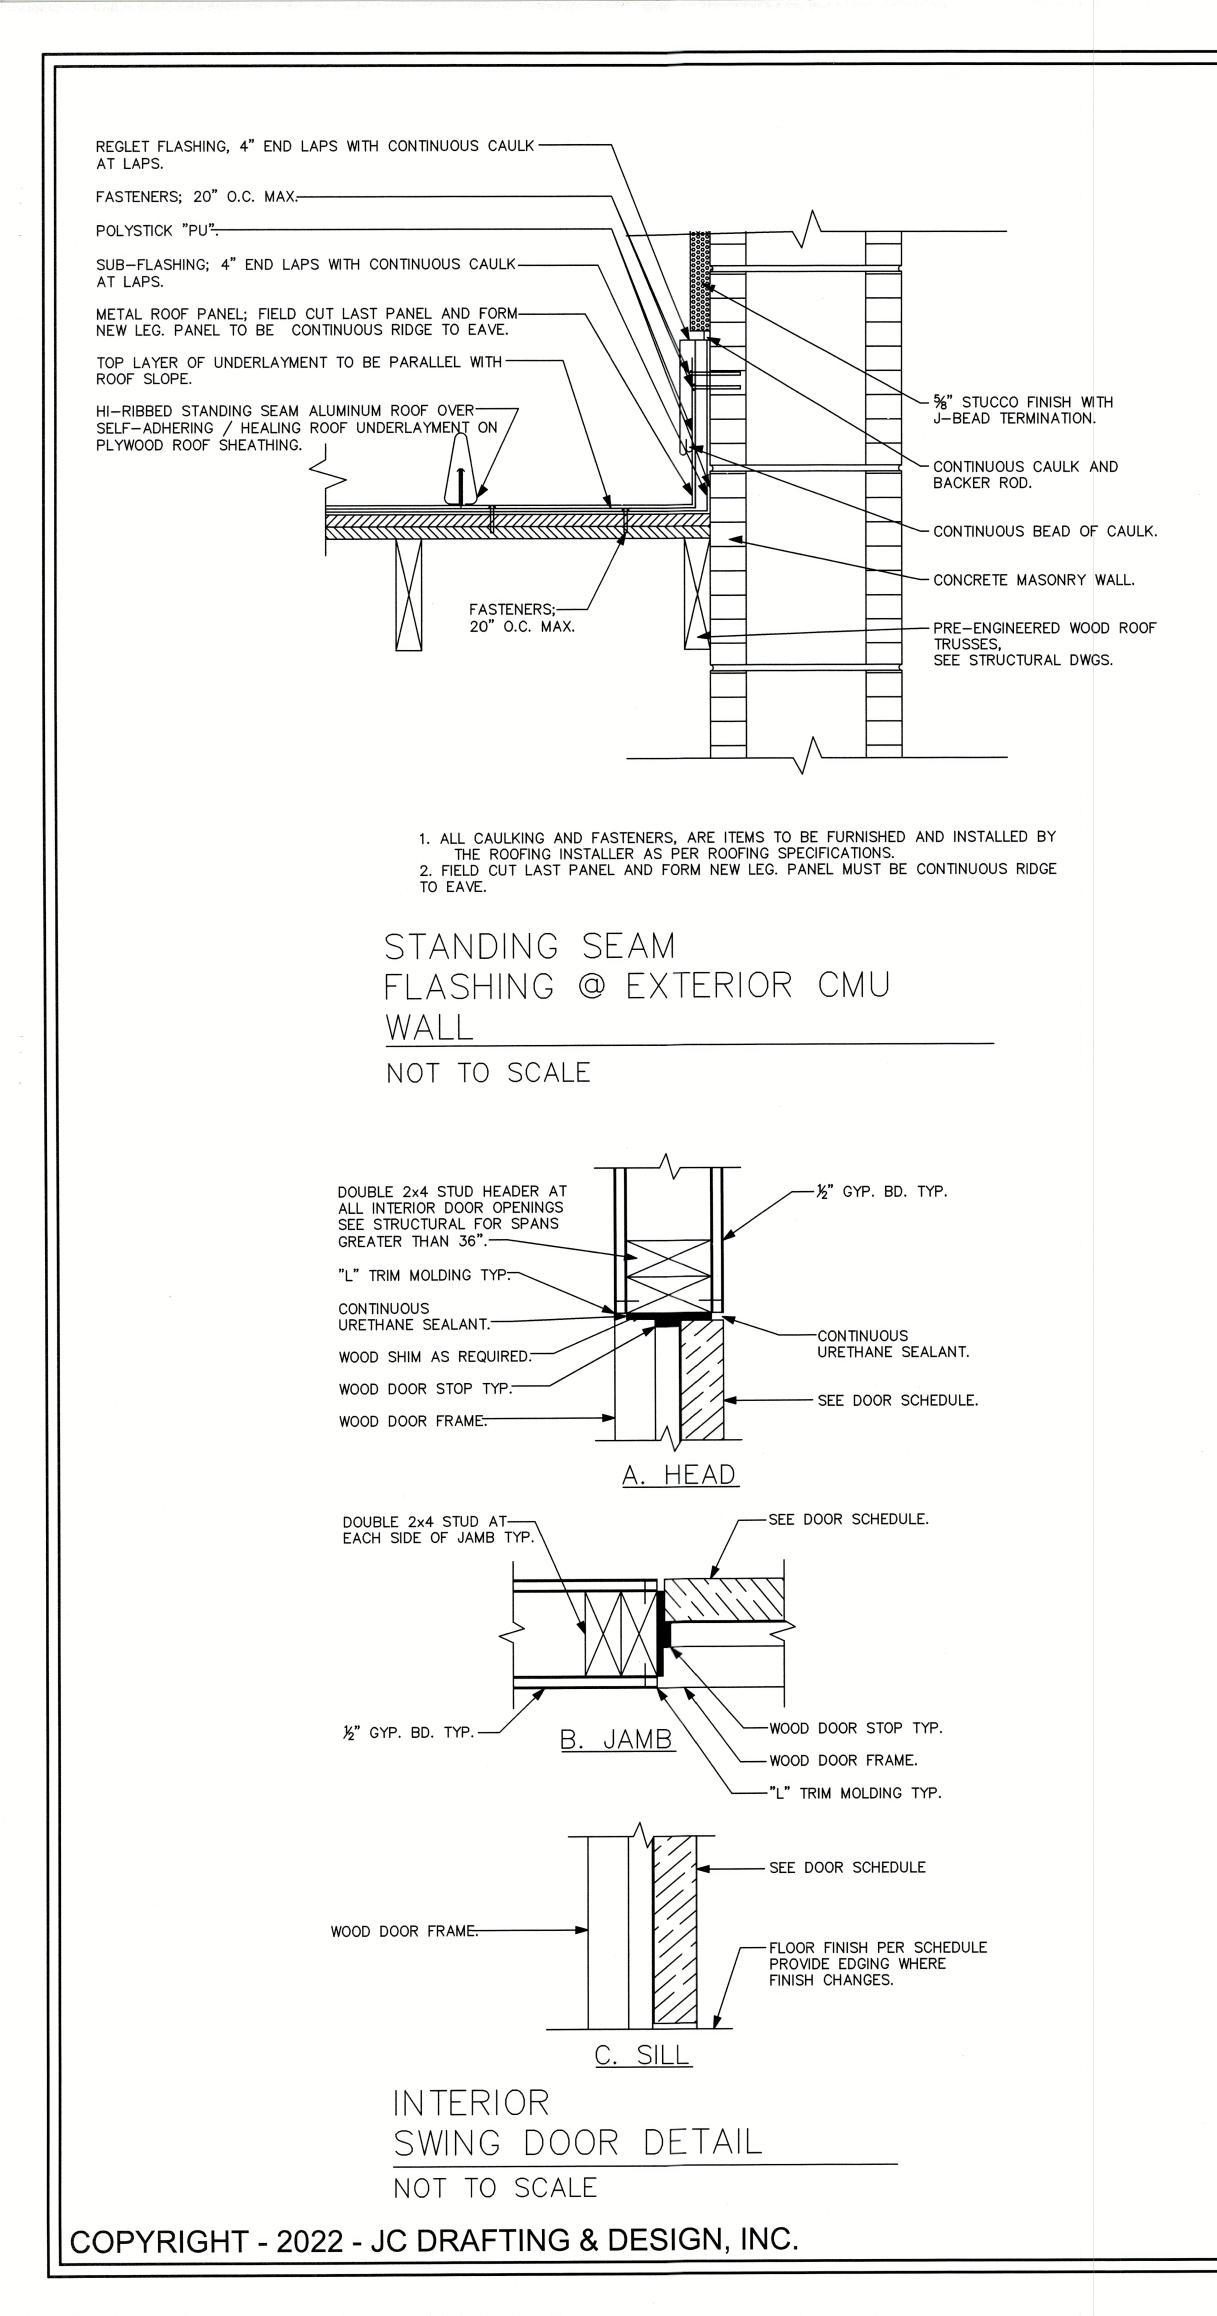
SCALE: AS SHOWN

SHEET TITLE:

BUILDING SECTION G-G AND TYPICAL **DETAILS** SHEET NO.







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2021-50 A14.0

CUS BO SP/ 759 N LONG PID:

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SCALE: AS SHOWN


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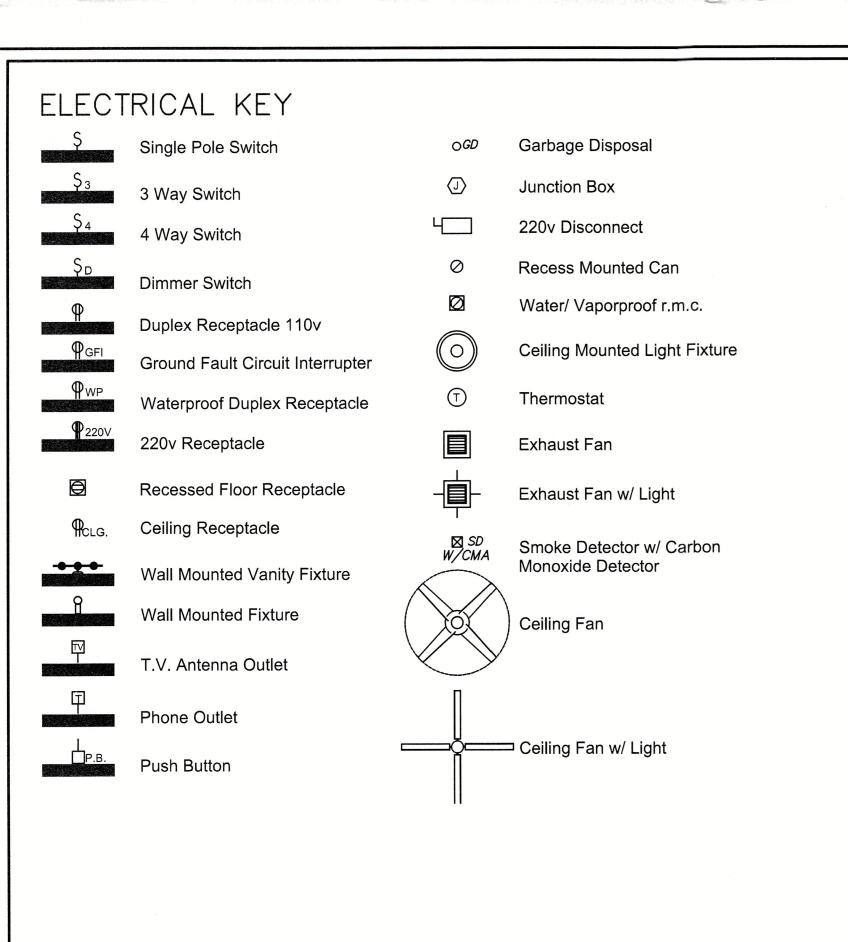
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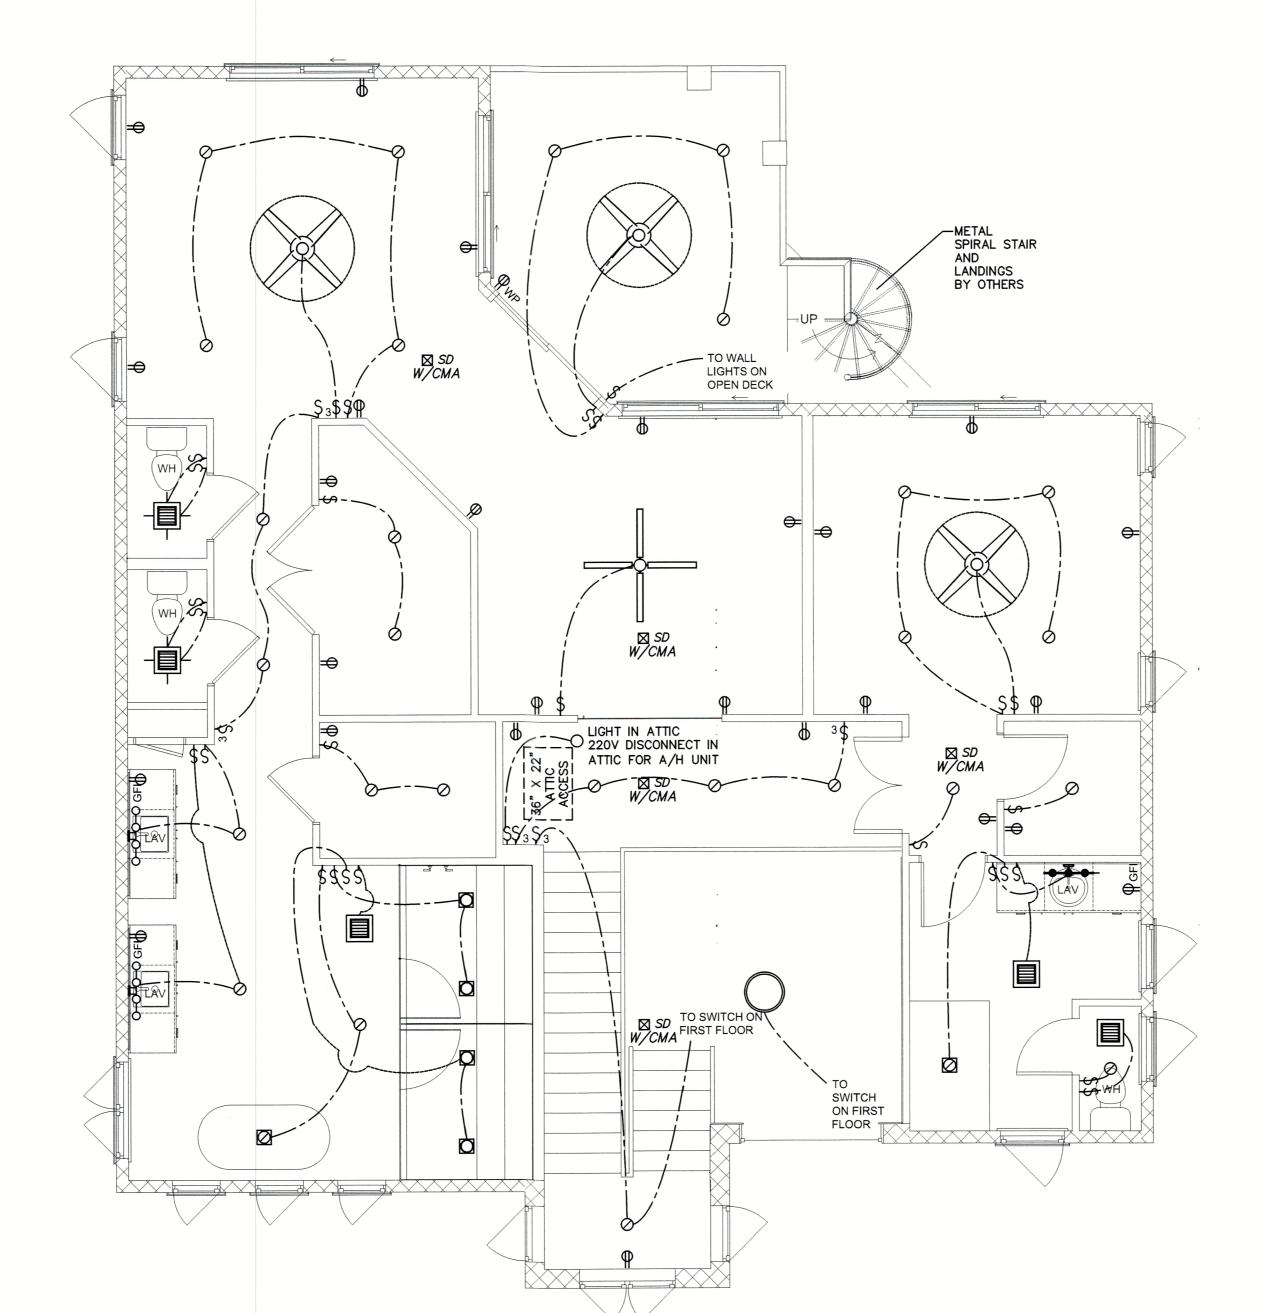
SHEET NO.

Reviewed for Code Compliance

LITE PERMITS OF SARASOTA






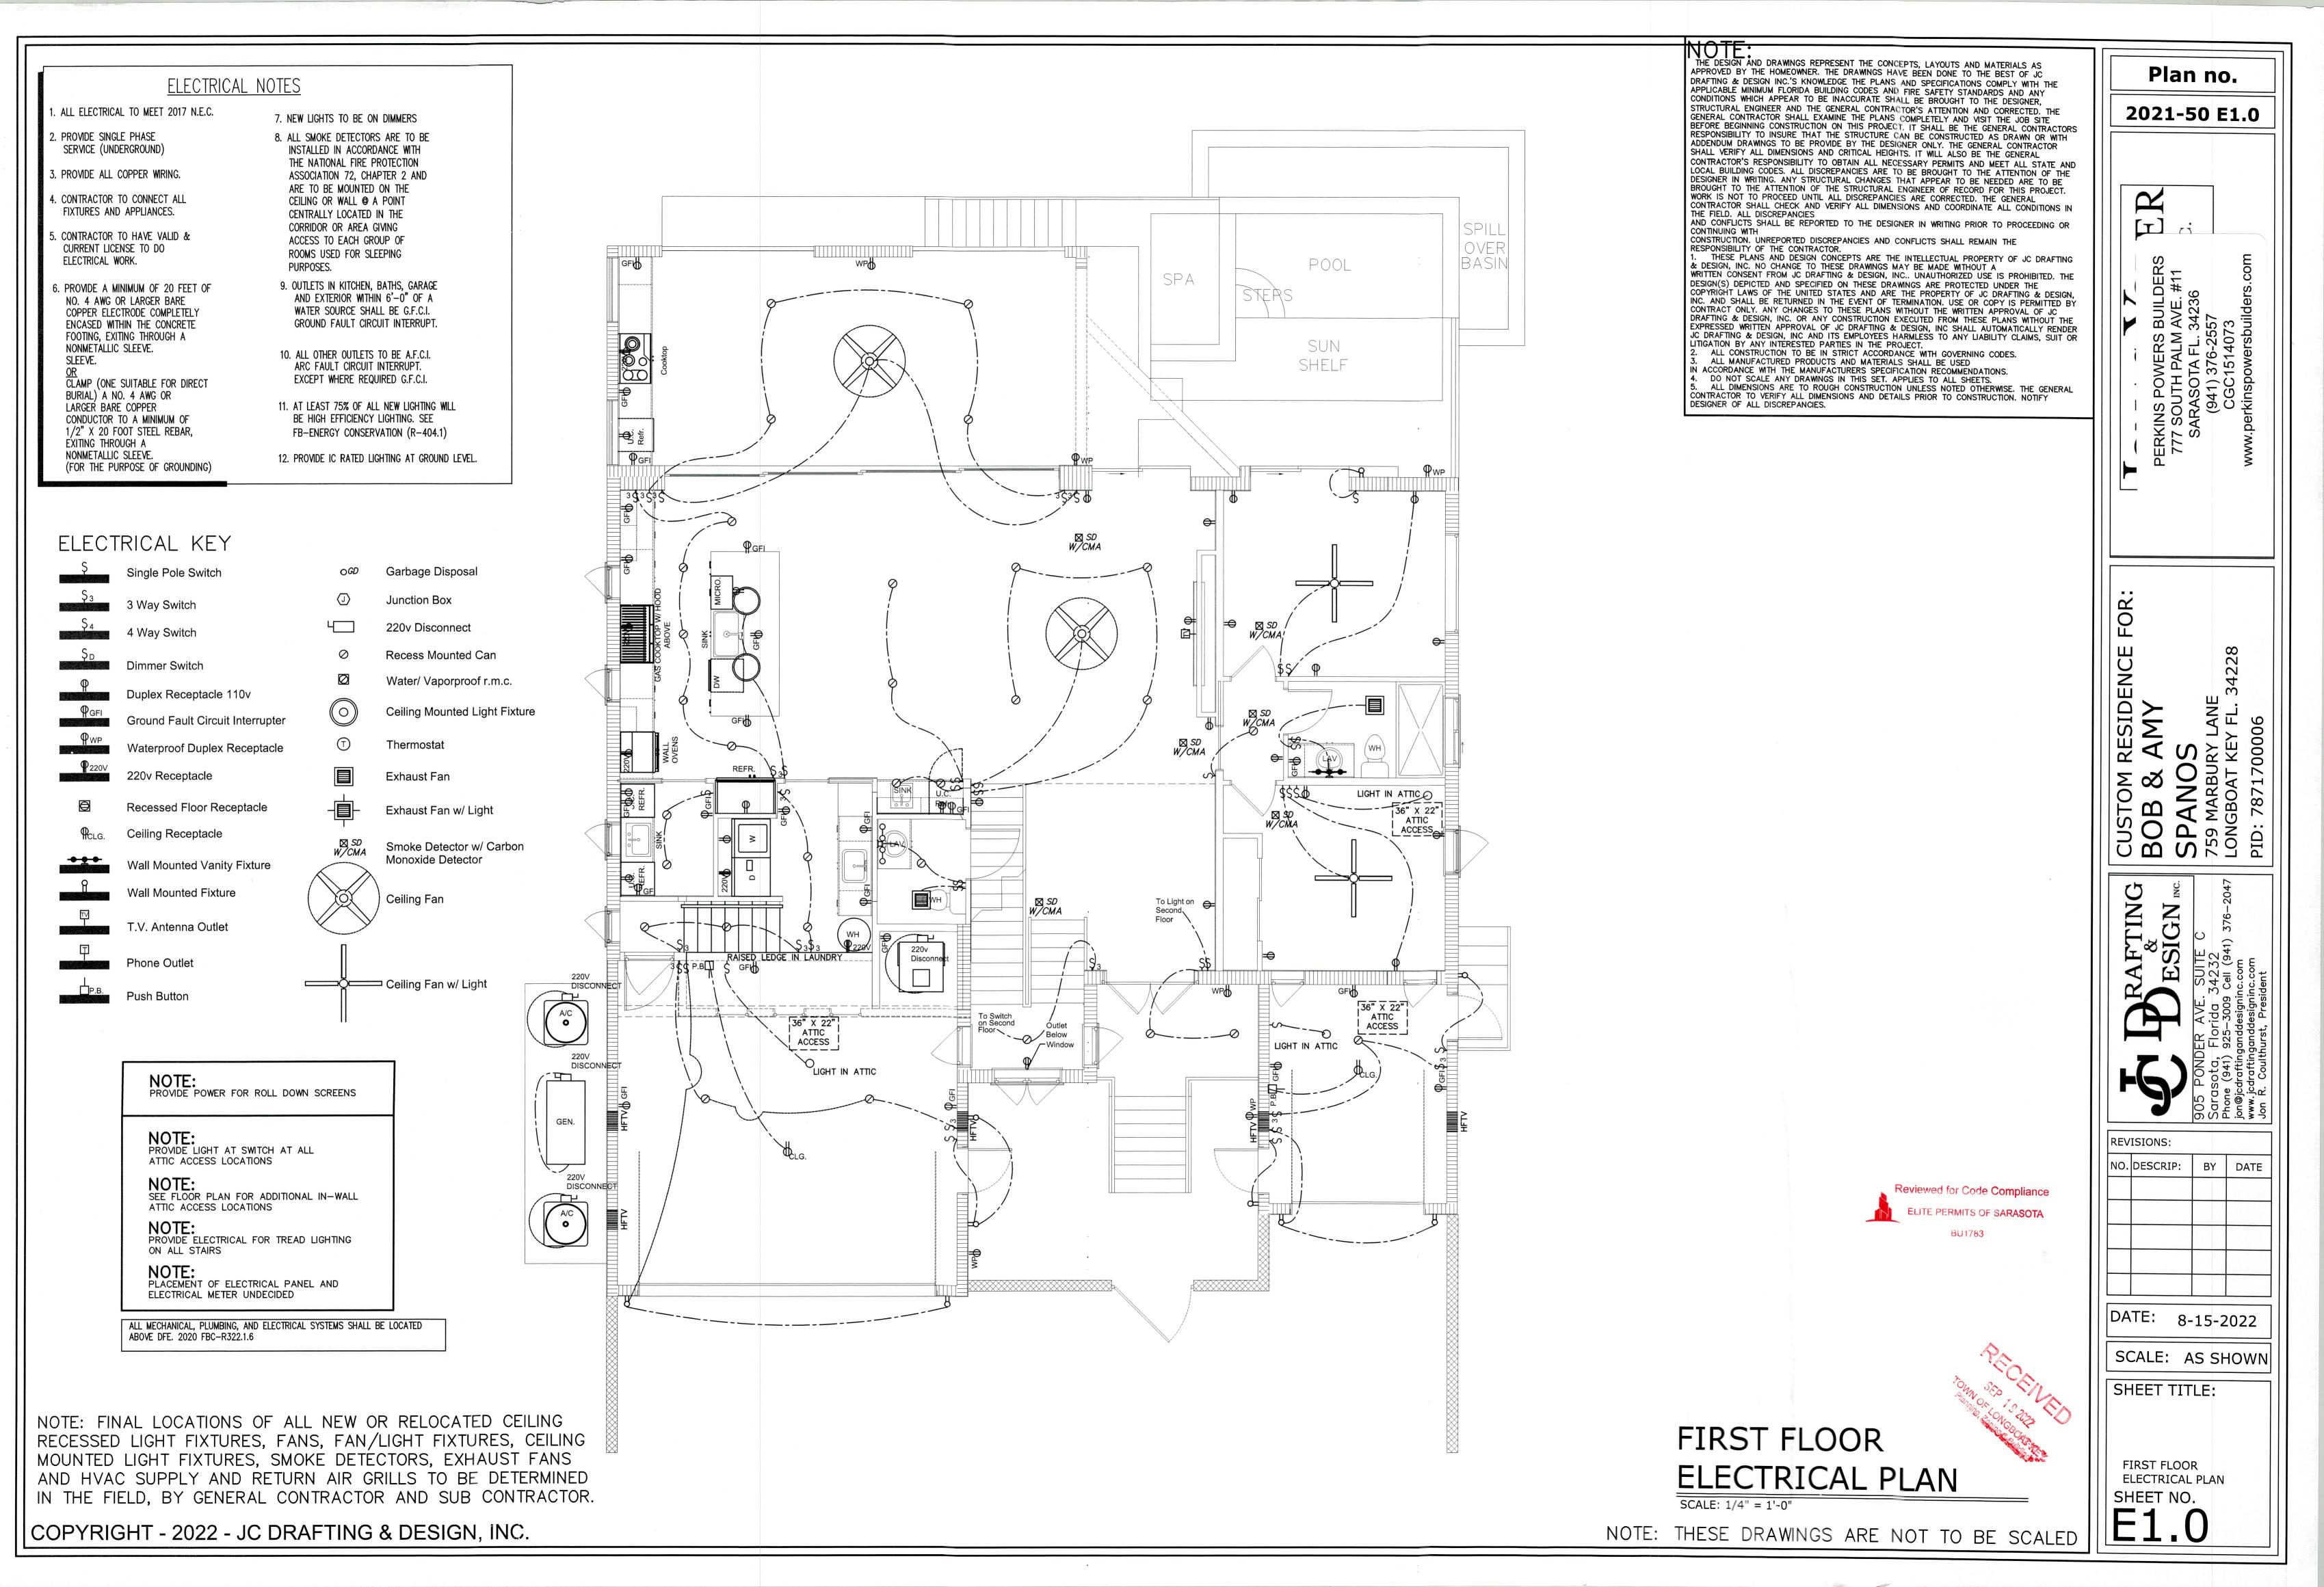

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OPEN DECK ELECTRICAL PLAN

SCALE: 1/4" = 1'-0"

Reviewed for Code Compliance ELITE PERMITS OF SARASOTA

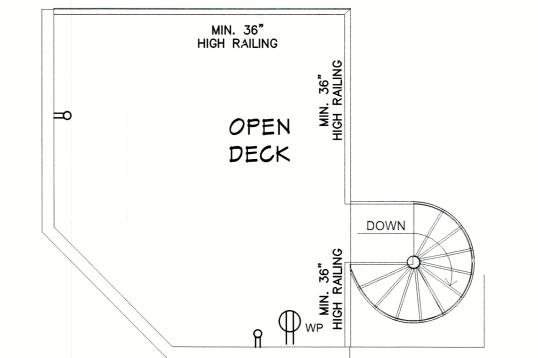

SECOND FLOOR ELECTRICAL PLAN

SCALE: 1/4" = 1'-0"

NOTE: THESE DRAWINGS ARE NOT TO BE SCALED

SHEET NO.

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NOTE: FINAL LOCATIONS OF ALL NEW OR RELOCATED CEILING

MOUNTED LIGHT FIXTURES, SMOKE DETÉCTORS, EXHAUST FANS

RECESSED LIGHT FIXTURES, FANS, FAN/LIGHT FIXTURES, CEILING

AND HVAC SUPPLY AND RETURN AIR GRILLS TO BE DETERMINED

IN THE FIELD, BY GENERAL CONTRACTOR AND SUB CONTRACTOR.

NOTE:
PROVIDE POWER FOR ROLL DOWN SCREENS

NOTE: SEE FLOOR PLAN FOR ADDITIONAL IN-WALL ATTIC ACCESS LOCATIONS

NOTE:
PROVIDE ELECTRICAL FOR TREAD LIGHTING

NOTE:
PLACEMENT OF ELECTRICAL PANEL AND
ELECTRICAL METER UNDECIDED

ALL MECHANICAL, PLUMBING, AND ELECTRICAL SYSTEMS SHALL BE LOCATED

NOTE:
PROVIDE LIGHT AT SWITCH AT ALL
ATTIC ACCESS LOCATIONS

ON ALL STAIRS

ABOVE DFE. 2020 FBC-R322.1.6

CUS BOI SP/ 759 N 10NG

Plan no.

2021-50 E2.0

BY DATE

DATE: 8-15-2022

SCALE: AS SHOWN

SHEET TITLE:

SECOND FLOOR ELECTRICAL PLAN

STRUCTURAL NOTES

GENERAL NOTES: THE STRUCTURAL DRAWINGS SHALL BE USED IN CONJUNCTION WITH ALL OTHER CONSTRUCTIONS DOCUMENTS. THIS INCLUDES, BUT IS NOT LIMITED TO, SPECIFICATIONS, RCHITECTURAL, MECHANICAL, ELECTRICAL, PLUMBING AND SITE DRAWINGS.

ALL CONDITIONS, ELEVATIONS, AND DIMENSIONS SHALL BE VERIFIED IN THE FIELD AND WITH THE OTHER CONSTRUCTION DOCUMENTS BY THE CONTRACTOR. ANY DISCREPANCIES RELATED TO THESE DRAWINGS SHALL BE BROUGHT TO THE ATTENTION OF STRUCTURAL ENGINEERING ALLIANCE, INC. (SEA) BEFORE PROCEEDING WITH THE AFFECTED PORTION OF WORK.

THE STRUCTURE IS DESIGNED TO BE SELF SUPPORTING AND STABLE AFTER CONSTRUCTION IS COMPLETED. THE CONTRACTOR IS RESPONSIBLE TO DETERMINE PROPER PROCEDURE AND SEQUENCE OF CONSTRUCTION TO ENSURE THE SAFETY OF THE BUILDING, ITS COMPONENTS AND PERSONNEL ON SITE. THIS INCLUDES TEMPORARY SUPPORT OF STRUCTURE DURING CONSTRUCTION WHICH MAY INCLUDE, BUT IS NOT LIMITED TO, TEMPORARY SHORING, BRACING AND TIE-DOWNS.

DESIGN LOADS: THE STRUCTURAL SYSTEMS FOR THIS BUILDING HAVE BEEN DESIGNED IN ACCORDANCE WITH THE FLORIDA BUILDING CODE, 2020 SEVENTH EDITION. THE FOLLOWING SUPERIMPOSED LOADS WERE UTILIZED IN THE DESIGN:

ROOF: LIVE LOAD 30 PSF DEAD LOAD 25 PSF SECOND FLOOR: LIVE LOAD 40 PSF

DEAD LOAD 25 PSF

ULTIMATE WIND SPEED: RISK CATEGORY: EXPOSURE: **ENCLOSED BUILDING** INTERNAL PRESSURE COEFFICIENTS: Kz, WIND DIRECTIONAL FACTOR:

FOUNDATION DESIGN: FOUNDATIONS ARE DESIGNED FOR AN ALLOWABLE SOIL BEARING PRESSURE OF 2000 PSF ON WELL COMPACTED FILL. BEFORE CONSTRUCTION COMMENCES, THE SOIL BEARING PRESSURE, SOIL CONDITIONS, AND SOIL COMPACTION REQUIREMENTS SHALL BE VERIFIED BY A LICENSED GEOTECHNICAL ENGINEER.

CONCRETE: SHALL BE PER AN APPROVED MIX DESIGN PROPORTIONED TO ACHIEVE A STRENGTH AT 28 DAYS AS LISTED BELOW WITH A PLASTIC AND WORKABLE MIX:

3000 psi FOR FOUNDATIONS AND SLABS ON GRADE. 4000 PSI FOR ALL OTHER STRUCTURAL CONCRETE

AND OTHER CONCRETE ELEMENTS. PROVIDE 48 BAR DIAMETER LAP SPLICES

CONCRETE SHALL BE PLACED AND CURED ACCORDING TO ACI STANDARDS AND SPECIFICATIONS.

REINFORCING STEEL: REINFORCING STEEL SHALL BE ASTM A 615, GRADE 60 DEFORMED BARS, FREE OF RUST SCALE, DIRT AND OIL AND PLACED IN ACCORDANCE WITH ACI STANDARDS. SUBMIT REINFORCING SHOP DRAWINGS FOR REVIEW AND ACCEPTANCE PRIOR TO FABRICATION. MECHANICAL COUPLERS SHALL MEET ACI 318 FOR TENSION SPLICE REQUIREMENTS.

PENETRATIONS: NO PENETRATIONS SHALL BE MADE IN ANY STRUCTURAL MEMBERS OR SLABS OTHER THAN THOSE LOCATED ON THESE DRAWINGS. IF ADDITIONAL PENETRATIONS ARE NECESSARY CONTACT SEA FOR RECOMMENDATIONS.

MASONRY WALLS: MASONRY UNITS SHALL MEET ASTM C 90 FOR HOLLOW LOAD BEARING TYPE MASONRY WITH UNIT STRENGTH OF 1900 PSI ON THE NET AREA (fm = 1500 psi). MORTAR SHALL BE TYPE "M"

GROUT FOR FILL CELLS SHALL MEET ASTM C 476 AND ACHIEVE A 2000 PSI MINIMUM COMPRESSIVE STRENGTH, GROUT DESIGN MIX SHALL BE SUBMITTED FOR REVIEW. USE MORTAR AND SPECIAL MASONRY UNITS AS NECESSARY TO CONFINE GROUT TO REQUIRED FILL CELLS WITHIN WALL. CELLS SHALL BE GROUT FILLED WITH VERTICAL REINFORCING BARS AT CORNERS, INTERSECTIONS, EACH SIDE OF OPENINGS OVER 2 FEET WIDE, AND AS INDICATED ON THE PLANS. LAP ALL VERTICAL REINFORCING ABOVE WITH EITHER VERTICAL REINFORCING FROM BELOW OR HOOKED DOWELS IN FOOTINGS

MASONRY SHALL BE PLACED IN RUNNING BOND PATTERN INCLUDING AT CORNERS AND INTERSECTIONS. PROVIDE 9 GAUGE GALVANIZED HORIZONTAL JOINT REINFORCING (DUR-O-WALL LADDER TYPE OR ENGINEER APPROVED SUBSTITUTION) AT ALTERNATE BLOCK COURSES.

EPOXY ANCHORING: EPOXY ANCHOR MATERIAL SHALL BE TWO PART EPOXY POLYMER INJECTION SYSTEM. ACCEPTABLE PRODUCTS ARE POWERS FASTENERS PE1000+, SIMPSON Strong-Tie SET, OR HILTI HIT RE 500 EPOXY DOWELING SYSTEM INSTALLED IN ACCORDANCE WITH THE MANUFACTURER'S RECOMMENDATIONS.

WEDGE ANCHORS: WEDGE ANCHORS SHALL BE MANUFACTURED BY HILTI OR POWERS FASTENERS. INSTALL ACCORDING TO MANUFACTURER'S RECOMMENDATIONS.

CONCRETE SCREWS: CONCRETE SCREWS SHALL BE MANUFACTURED BY SIMPSON, HILTI OR POWERS FASTENERS. INSTALL ACCORDING TO MANUFACTURER'S RECOMMENDATIONS.

WOOD: STRUCTURAL WOOD COMPONENTS SHALL HAVE THE FOLLOWING MINIMUM ALLOWABLE FIBER STRESSES FOR NO.2 SOUTHERN PINE CONFORMING TO NATIONAL DESIGN SPECIFICATION FOR

SHEAR Fy = 90 PSI BENDING 2X4 Fb = 1500 PSI BENDING 2X6 Fb = 1250 PSI BENDING 2X8 Fb = 1200 PSI BENDING 2X10 Fb = 1050 PSI

WOOD CONSTRUCTION, LATEST EDITION:

WOOD IN CONTACT WITH CONCRETE OR MASONRY SHALL BE ISOLATED FROM SAME OR PRESSURE TREATED


PRE-ENGINEERED WOOD TRUSS SYSTEM SHALL BE DESIGNED BY TRUSS MANUFACTURER'S SPECIALTY ENGINEER. THIS SYSTEM INCLUDES, BUT MAY NOT BE LIMITED TO, TRUSSES, TRUSS-TO-TRUSS CONNECTIONS AND PERMANENT TRUSS BRACING. AN ERECTION DRAWING SHALL INCLUDE AND IDENTIFY ALL TRUSS SYSTEM COMPONENTS. TRUSS SYSTEM SHALL BE DESIGNED TO CONFIGURATION AND LOAD CARRYING CAPACITY SHOWN ON THE DRAWINGS. ALTERNATE TRUSS LAYOUTS ARE ACCEPTABLE ONLY AS A CHANGE ORDER WHICH WILL INCLUDE ENGINEERING CHARGES FOR REDESIGN OF THE STRUCTURE BY SEA

ROOF AND WALL SHEATHING SHALL BE APA SPAN RATED SHEATHING, ARE DESIGNED AS DIAPHRAGMS AND SHALL COMPLY WITH THE PROVISIONS OF CHAPTER 23 OF THE FLORIDA BUILDING CODE AND SHALL BE FASTENED IN ACCORDANCE WITH THE MINIMUM REQUIREMENTS OF TABLES 2306.3.1 AND 2306.3.2 AND AS SHOWN ON THESE DRAWINGS.

MANUFACTURED STRUCTURAL WOOD COMPONENTS: LAMINATED VENEER LUMBER (LVL) SHALL BE '1.9E MICROLLAM LVL' MANUFACTURED BY TRUSJOIST MACMILLAN AND HAVE THE FOLLOWING MINIMUM

Fb = 2600 psi Fc = 750 psiBEARING MODULUS OF ELASTICITY E = 1,900,000 psi

WOOD FRAMING CONNECTORS: MODEL NUMBERS FOR WOOD FRAMING CONNECTORS ARE INDICATED ON THE STRUCTURAL DRAWINGS AND SHALL BE MANUFACTURED BY SIMPSON strong-tie Co. UNLESS SHOWN OTHERWISE, INSTALL CONNECTOR INDICATED IN ACCORDANCE WITH AND WITH NUMBER OF FASTENERS RECOMMENDED BY THE MANUFACTURER U.N.O. ON THESE DRAWINGS, EXPOSED FASTENERS AND CONNECTORS SHALL BE HOT DIPPED GALVANIZED OR STAINLESS STEEL

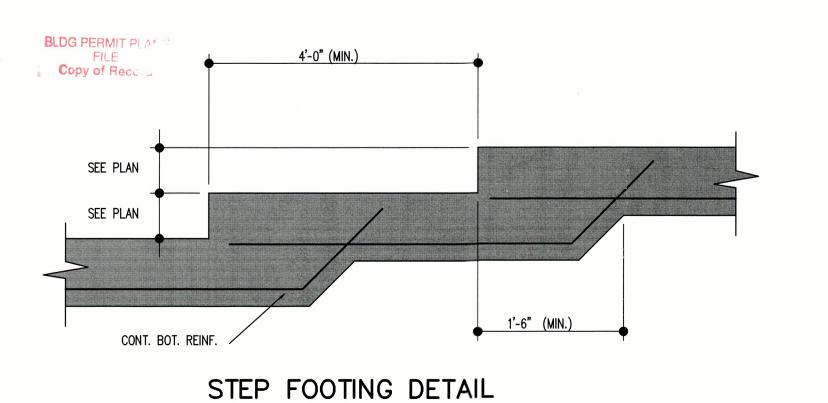



-2" THICK P.T. BUCK WIDTH AND LOCATION AS REQUIRED, 1/4" Ø TAPCONS WITH 1½" PENETRATION (MIN.), AT 4" FROM ENDS & 8" O.C. BETWEEN

PROVIDE AT JAMBS, HEADS, & SILLS AS REQUIRED BY WINDOW/DOOR N.O.A.

TYPICAL WINDOW BUCK




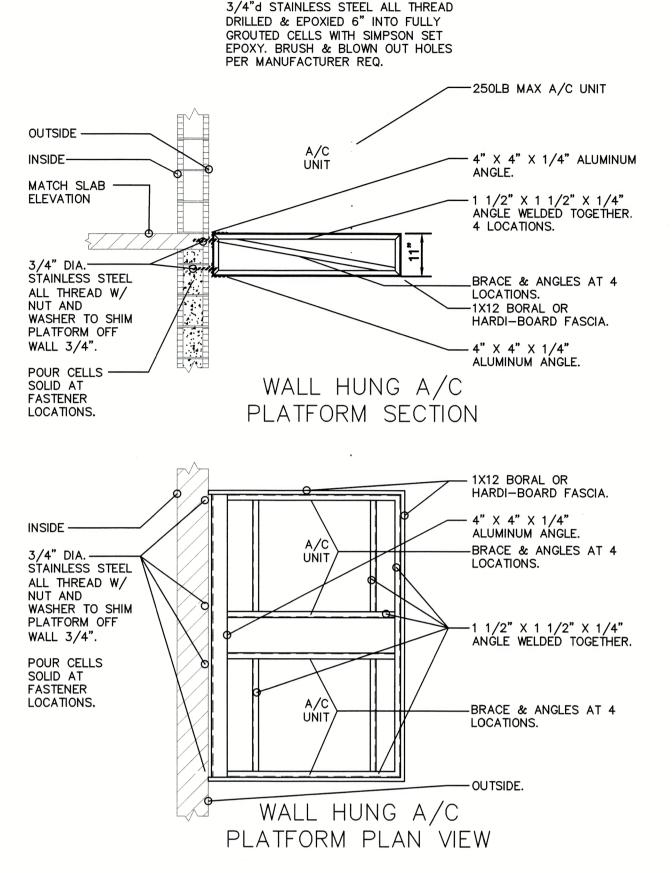

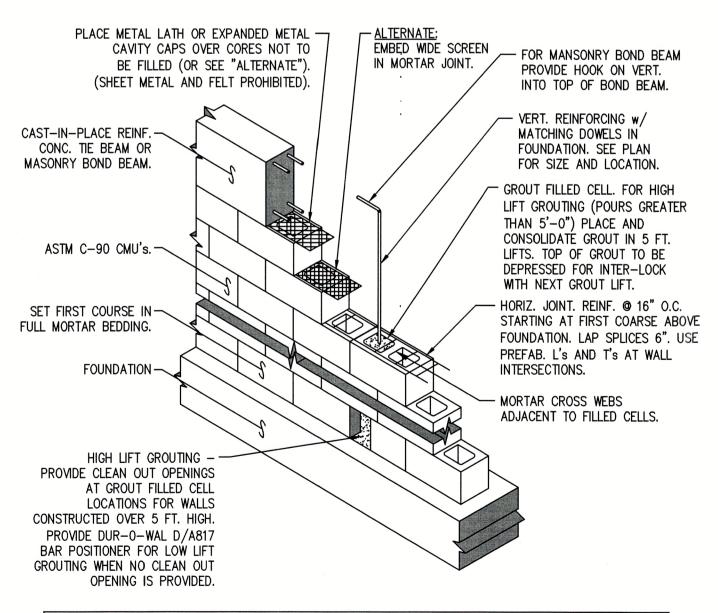


1). PROVIDE CLEAN OUTS IN LOW LIFT GROUTING IF MORTOR FINS AND DEBRIS IS EXCESSIVE. 2). FOR HIGH LIFT GROUTING, GROUT LIFT HEIGHT MAY BE INCREASED TO 12'-8" IF CONDITIONS ARE IN ACCORDANCE WITH ACI 530-05 SUBSECTION 3.5D OF SPECIFICATIONS FOR MASONRY STRUCTURES. 3). CONSOLIDATE AND RECONSOLIDATE GROUT POUR BY MECHANICAL VIBRATION IN ACCORDANCE WITH ACI 530-05 SUBSECTION 3.5E OF SPECIFICATIONS FOR MASONRY STRUCTURES.

TYP. MASONRY WALL CONSTRUCTION

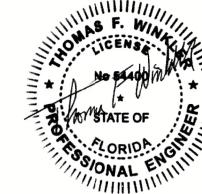

WIND LOAD SCHEDULE SPANOS RES						
SCHEDULE OF COMPONENTS AND CLADDING LOADS						
ZONE	ZONE DESCRIPTION	ZONE DESCRIPTION TRIBUTARY AREA (SF)		OUT (PRESSURE) (- PSF)		
1	ROOF INTERIOR ZONE	LESS THAN 20 20 - 100 MORE THAN 100	22.37 20.73 15.79	35.53 33.90 32.25		
2	ROOF, EDGE ZONE	LESS THAN 20 20 - 100 MORE THAN 100	22.37 20.73 15.79	61.86 56.92 45.40		
	ROOF, OVERHANG, EDGE ZONE	LESS THAN 20 20 - 100 MORE THAN 100		78.31 78.31 78.31		
3	ROOF, CORNER ZONE	LESS THAN 20 20 - 100 MORE THAN 100	22.37 20.73 15.79	91.46 85.87 71.72		
3	ROOF, OVERHANG CORNER ZONE	LESS THAN 20 20 - 100 MORE THAN 100		127.66 114.50 88.16		
4	WALL, INTERIOR ZONE	LESS THAN 20 20 - 100 MORE THAN 100	38.82 37.18 32.90	42.11 40.47 36.85		
5	WALL, EDGE ZONE	LESS THAN 20 20 - 100 MORE THAN 100	38.82 37.18 32.90	51.99 48.69 40.47		



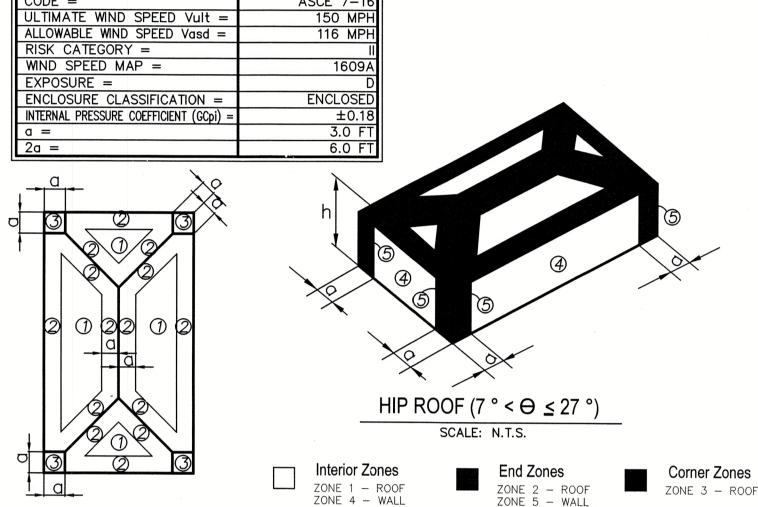

ABBREVIATIONS

A.B. = ANCHOR BOLT ALT. = ALTERNATEAPPROX. = APPROXIMATELY ARCH. = ARCHITECTARCHT'L. = ARCHITECTURAL BAL. = BALANCEB.C. = BOTTOM CHORDBLDG. = BUILDINGCOLUMN SYMBOLS BM. = BEAMBOTT = BOTTOMBRG. = BEARING CH. = CHANNELC.I.P. = CAST IN PLACEC.J. = CONSTRUCTION JOINT CL = CENTERLINECLR. = CLEARCMU = CONCRETE MASONRY UNIT COL. = COLUMNCONC. = CONCRETE CONFIG. = CONFIGURATION CONT. = CONTINUOUSCONTR. = CONTRACTOR CONSTR. = CONSTRUCTION CTR. = CENTERDBL. = DOUBLE DTL. = DETAILDIA. = DIAMETER DIM. = DIMENSION

DN. = DOWN

EA. = EACH

EQ. = EQUAL

DWG. = DRAWING

E.E. = EACH END

E.F. = EACH FACE

E.S. = EACH SIDE

E.W. = EACH WAY

EXIST. = EXISTING

EXP. = EXPANSION

FDN. = FOUNDATION

GALV. = GALVANIZED

HC = HOLLOW CORE

HORIZ. = HORIZONTAL

I.J. = ISOLATION JOINT

INFO. = INFORMATION

INT. = INTERIOR

L.W. = LONG WAY

MAT'L. = MATERIAL

MAX. = MAXIMUM

M.D. = MID-DEPTH

MFR. = MANUFACTURER

JT. = JOINT

L = ANGLELG. = LONG

HG = HIP GIRDER

H.P. = HIGH POINT

G.C. = GENERAL CONTRACTOR

H.D.G. = HOT DIPPED GALVANIZED

HSS = HOLLOW STRUCTURAL SECTION

EXT. = EXTERIOR

FIN. = FINISH

FLR. = FLOOR

F.S. = FAR SIDE

FTG. = FOOTING

FT. = FOOT

GA. = GAGE

E.J. = EXPANSION JOINT

EL./ELEV. = ELEVATION

CONSTRUCTION

JOINT (KJ)

ISOLATION JOINT (IJ)

) — INDICATES COLUMN BELOW

- 1/2" PREMOLDED

FILLER

or Pier

- INDICATES COLUMN THRU

- INDICATES COLUMN ABOVE

NOT TO SCALE JOINT FILLER - SAW CUT

SAW CUT AS SOON AS POSSIBLE WITHOUT RAVELING CONCRETE. (4 TO 16 HOURS AFTER POUR)

CONTROL JOINT (CJ) NOT TO SCALE

ZONE 5 - WALL MIN. = MINIMUMMISC. = MISCELLANEOUS N.S. = NEAR SIDEN.I.C. = NOT IN CONTRACTN.T.S. = NOT TO SCALE0.C. = ON CENTERO.H. = OPPOSITE HAND OPNG. = OPENINGP.A.F. = POWDER ACTUATED FASTENER PART. = PARTITION

PART'L. = PARTIALPL = PLATEplf = POUNDS PER LINEAR FOOT psf = POUNDS PER SQUARE FOOT psi = POUNDS PER SQUARE INCH

P.T. = POST TENSION OR PRESSURE TREATED REINF. = REINFORCING REQ'D. = REQUIREDREV. = REVISED / REVISION R.O. = ROUGH OPENINGSCHED. = SCHEDULESECT. = SECTION


SIM. = SIMILARS.J. = CONTRACTION JOINT SQ. = SQUARES.M.S. = SHEET METAL SCREW STD. = STANDARDSW = SHEARWALLS.W. = SHORT WAY

STL. = STEELSTRUCT. = STRUCTURAL T.C. = TOP CHORDT/O = THRU OUTT.O. = TOP OF ... T = TOP

TEMP. = TEMPERATURE TYP. = TYPICAL U.N.O. = UNLESS NOTED OTHERWISE VERT. = VERTICAL V.S. = VALLEY SET

W = WIDE FLANGEw/=WITHWD. = WOODWP = WORK POINT W.W.F. = WELDED WIRE FABRIC

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Thomas F Winkler Winkler

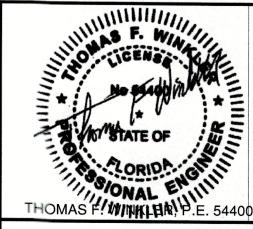TO THE BEST OF MY KNOWLEDGE AND ABILITY, THE COMPLETED STRUCTURE DEPICTED ON THE PLANS COMPLIES WITH THE APPLICABLE MINIMUM BUILDING CODES

STRUCTURAL ENGINEERING ALLIANCE, IN

Florida Certificate of Authorization # 293

consulting, design, drafting & inspection

7125 FRUITVILLE ROAD

SARASOTA, FL 342

TEL: 941-932-7274

thomaswinklerpe@gmail.co

PMB 1472

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Plan no. 2021-50 S1.0

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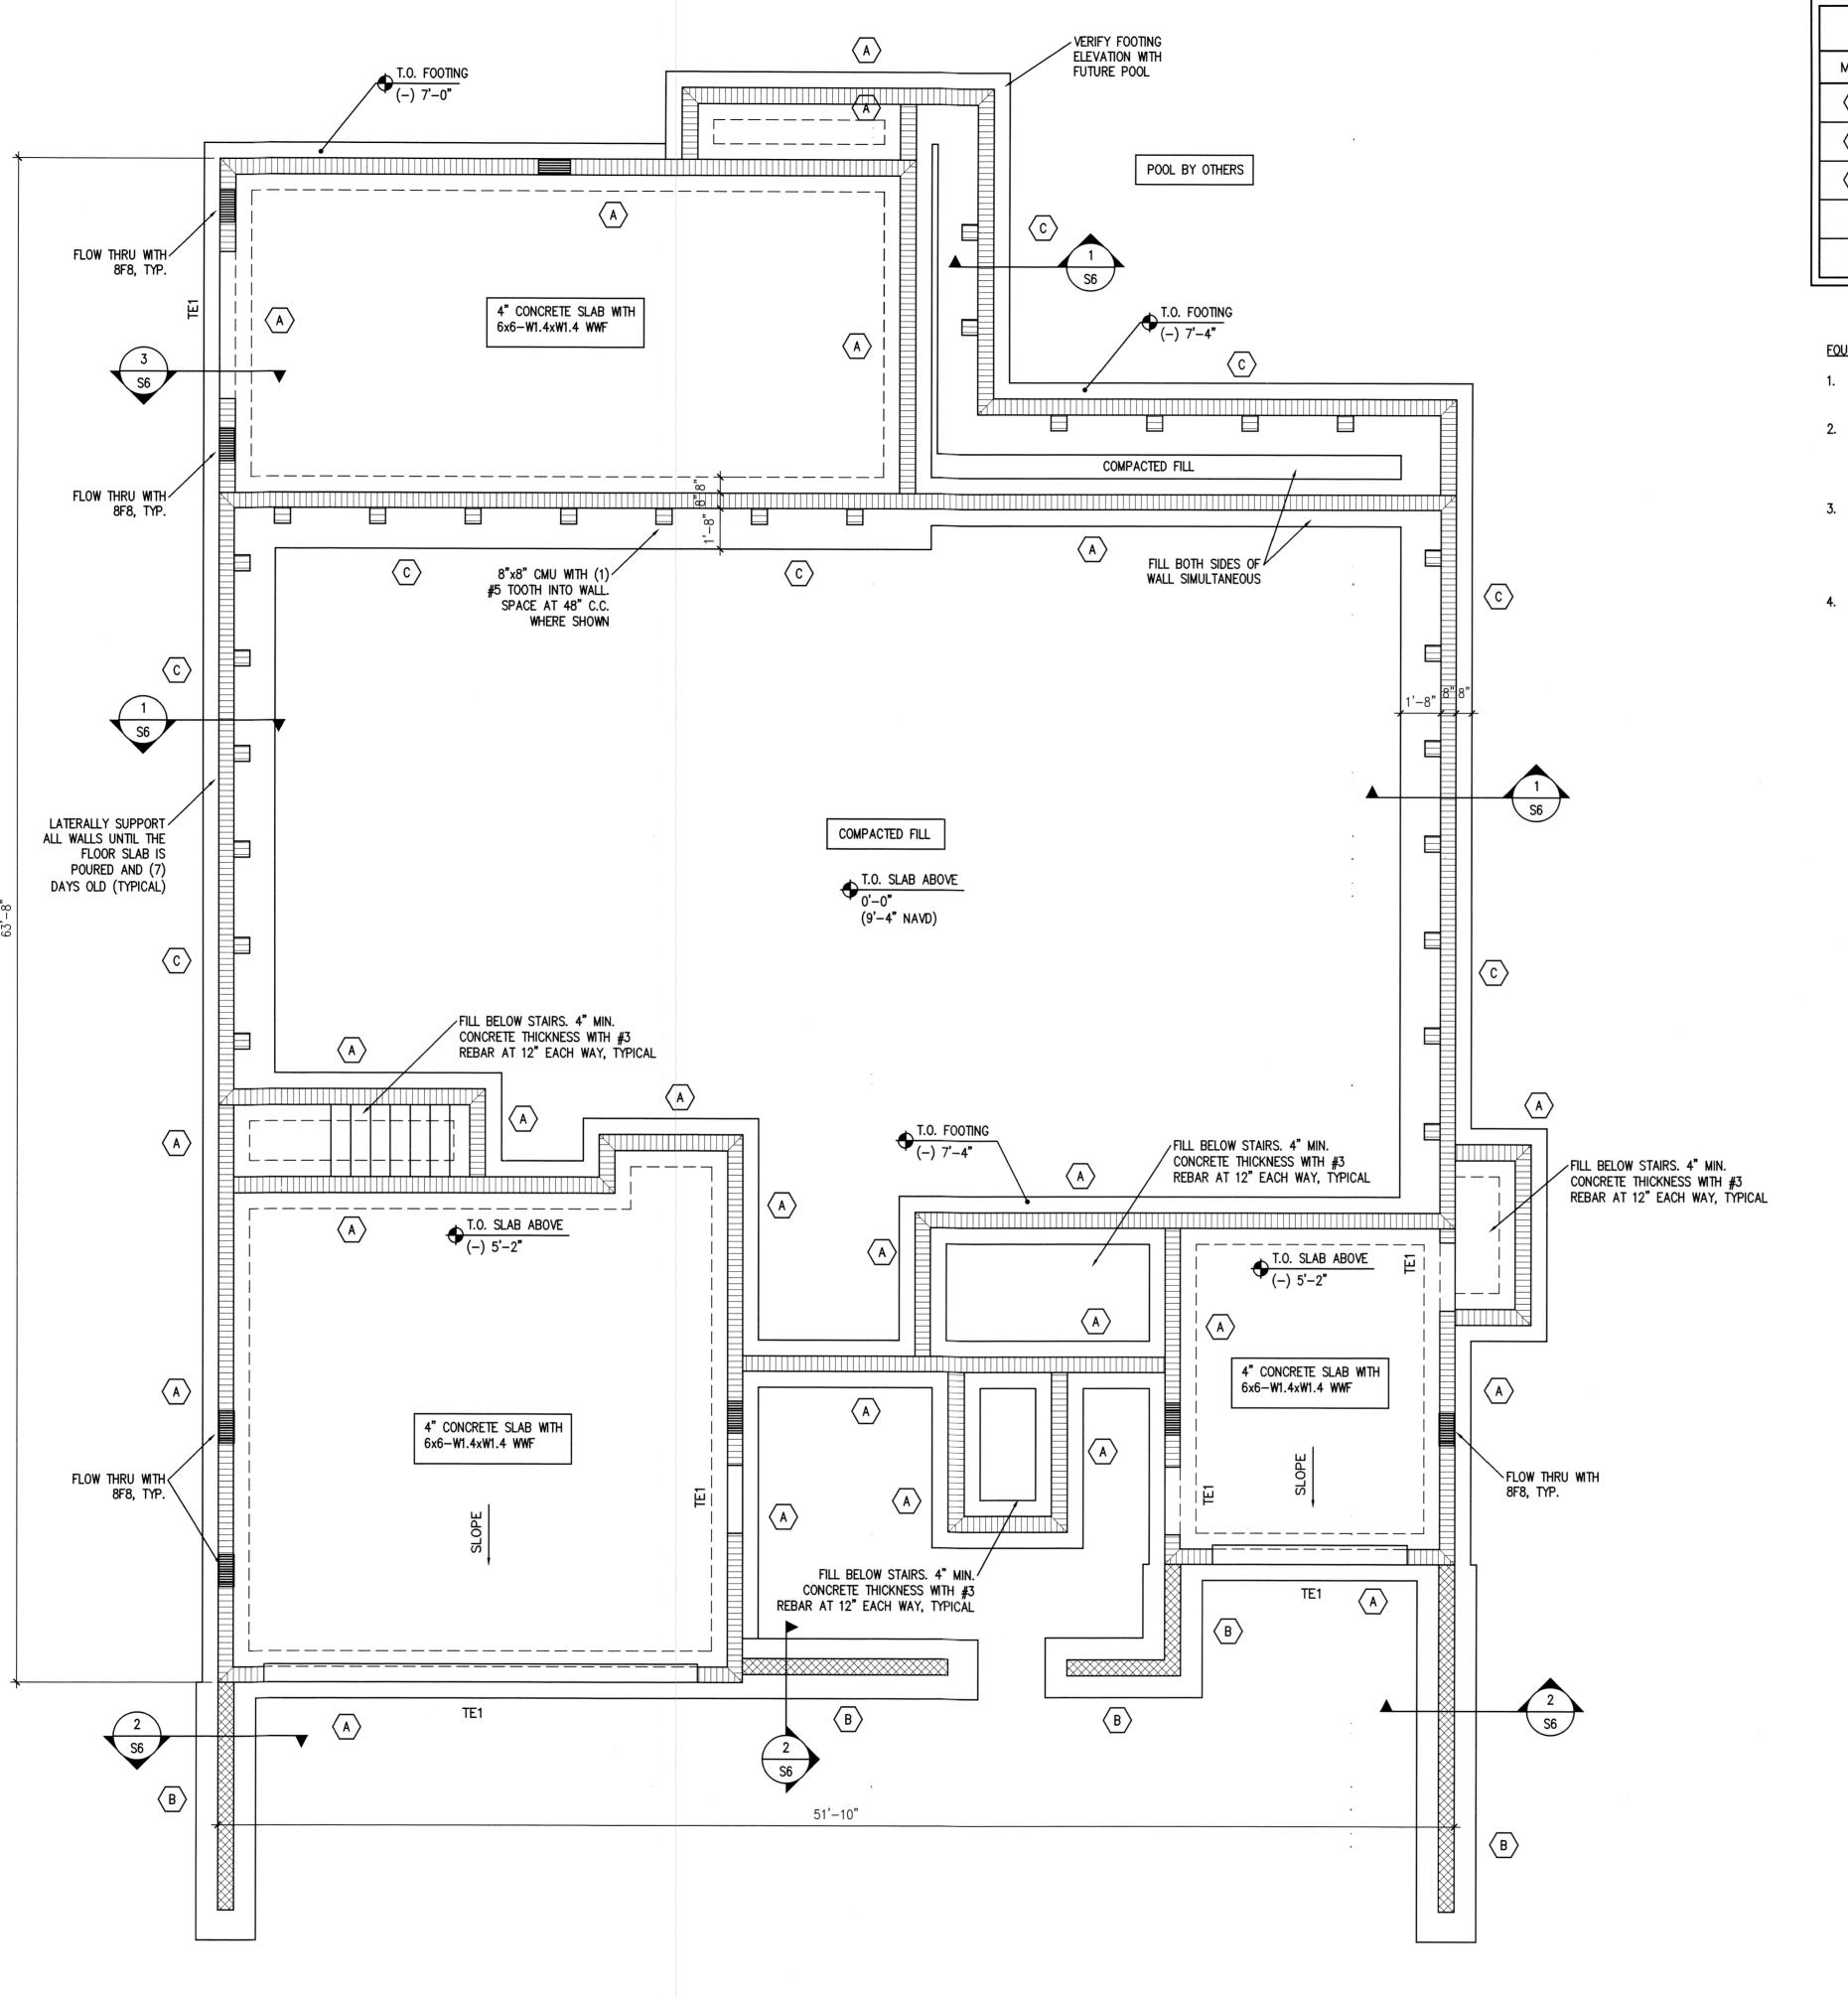
LIN Z 田

Reviewed for Code ConREVISIONS: ELITE PERMITS OF SARASOIA. DESCRIP: BY DATE REVISIONS 10/04/22

DATE: 08-15-2022

SCALE: AS SHOWN

SHEET TITLE: STRUCTURAL NOTES AND TYPICAL DETAILS




FOUNDATION PLAN
SCALE: 1/4"=1'-0"

	FOOTING SCHEDULE						
MARK	SIZE (W x L x D)	REINFORCEMENT	REMARKS				
A	2'-0" × CONT × 12"	(3) #5's, CONT.					
B	2'-6" x CONT x 12"	(4) #5 CONT, #5 @ 24" SW					
(C)	3'-0" × CONT × 12"	(5) #5 CONT, #5 @ 16" SW					
TE1	8" x CONT x 8"	(1) #5's, CONT.	THICKENED EDGE				

FOUNDATION PLAN NOTES:


- 1. VERIFY ALL DIMENSIONS, ELEVATIONS AND CONDITIONS WITH 'A' SHEETS. FOR ADDITIONAL DIMENSIONS, SEE 'A' SHEETS
- 2. DENOTES 8" CMU WALL WITH #5 REBAR IN GROUT FILLED WALL AT CORNERS, EDGES OF DOORS & WINDOWS, INTERSECTIONS AND AT 16" C.C. (BELOW 0'-0") AT 0'-0" ELEVATION WALL CHANGES TO 32" C.C.
- 3. SLAB SHALL BE A 4" CONCRETE SLAB ON GRADE WITH 6"x6" W1.4xW1.4 WWF ON VAPOR BARRIER ON COMPACTED MATERIAL. PROVIDE SAWN CONTROL JOINTS WITHIN 12 HOURS OF POURING. JOINT PATTERN SHALL BE APPROX SQUARE AND NOT TO EXCEED 10' SPACING
- 4. DENOTES 8" RETAINING WALL OR PRIVACY WALL. RETAINING WALL TO HAVE 3'-0" MAXIMUM SOIL DIFFERENCE ACROSS WALL. PRIVACY WALL TO B 60" MAXIMUM HEIGHT ABOVE GRADE. PROVIDE #5 REBAR AT 16" C.C. WITH A KNOCK OUT BLOCK WITH (1) #5 AT TOP OF WALL

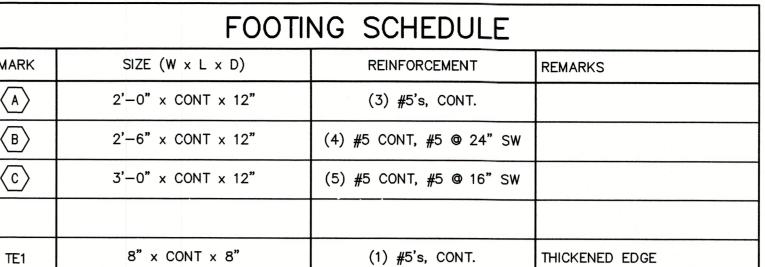

Reviewed for Code Compliance ELITE PERMITS OF SARASOTA



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Thomas F Winkler
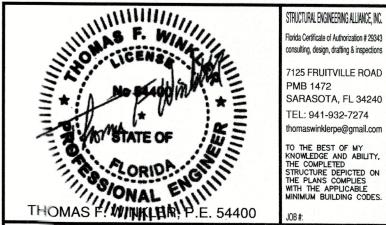
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TEL: 941-932-7274

homaswinklerpe@gmail.com

Plan no.

2021-50 S2.0

4228

SIDENCE CUS BO SP 759 LONG PID:

RAFTING & ESIGN INC.

REVISIONS:

NO. DESCRIP: BY DATE


DATE: 08-15-2022

SCALE: AS SHOWN

SHEET TITLE:

FOUNDATION PLAN

SHEET NO. S2.0

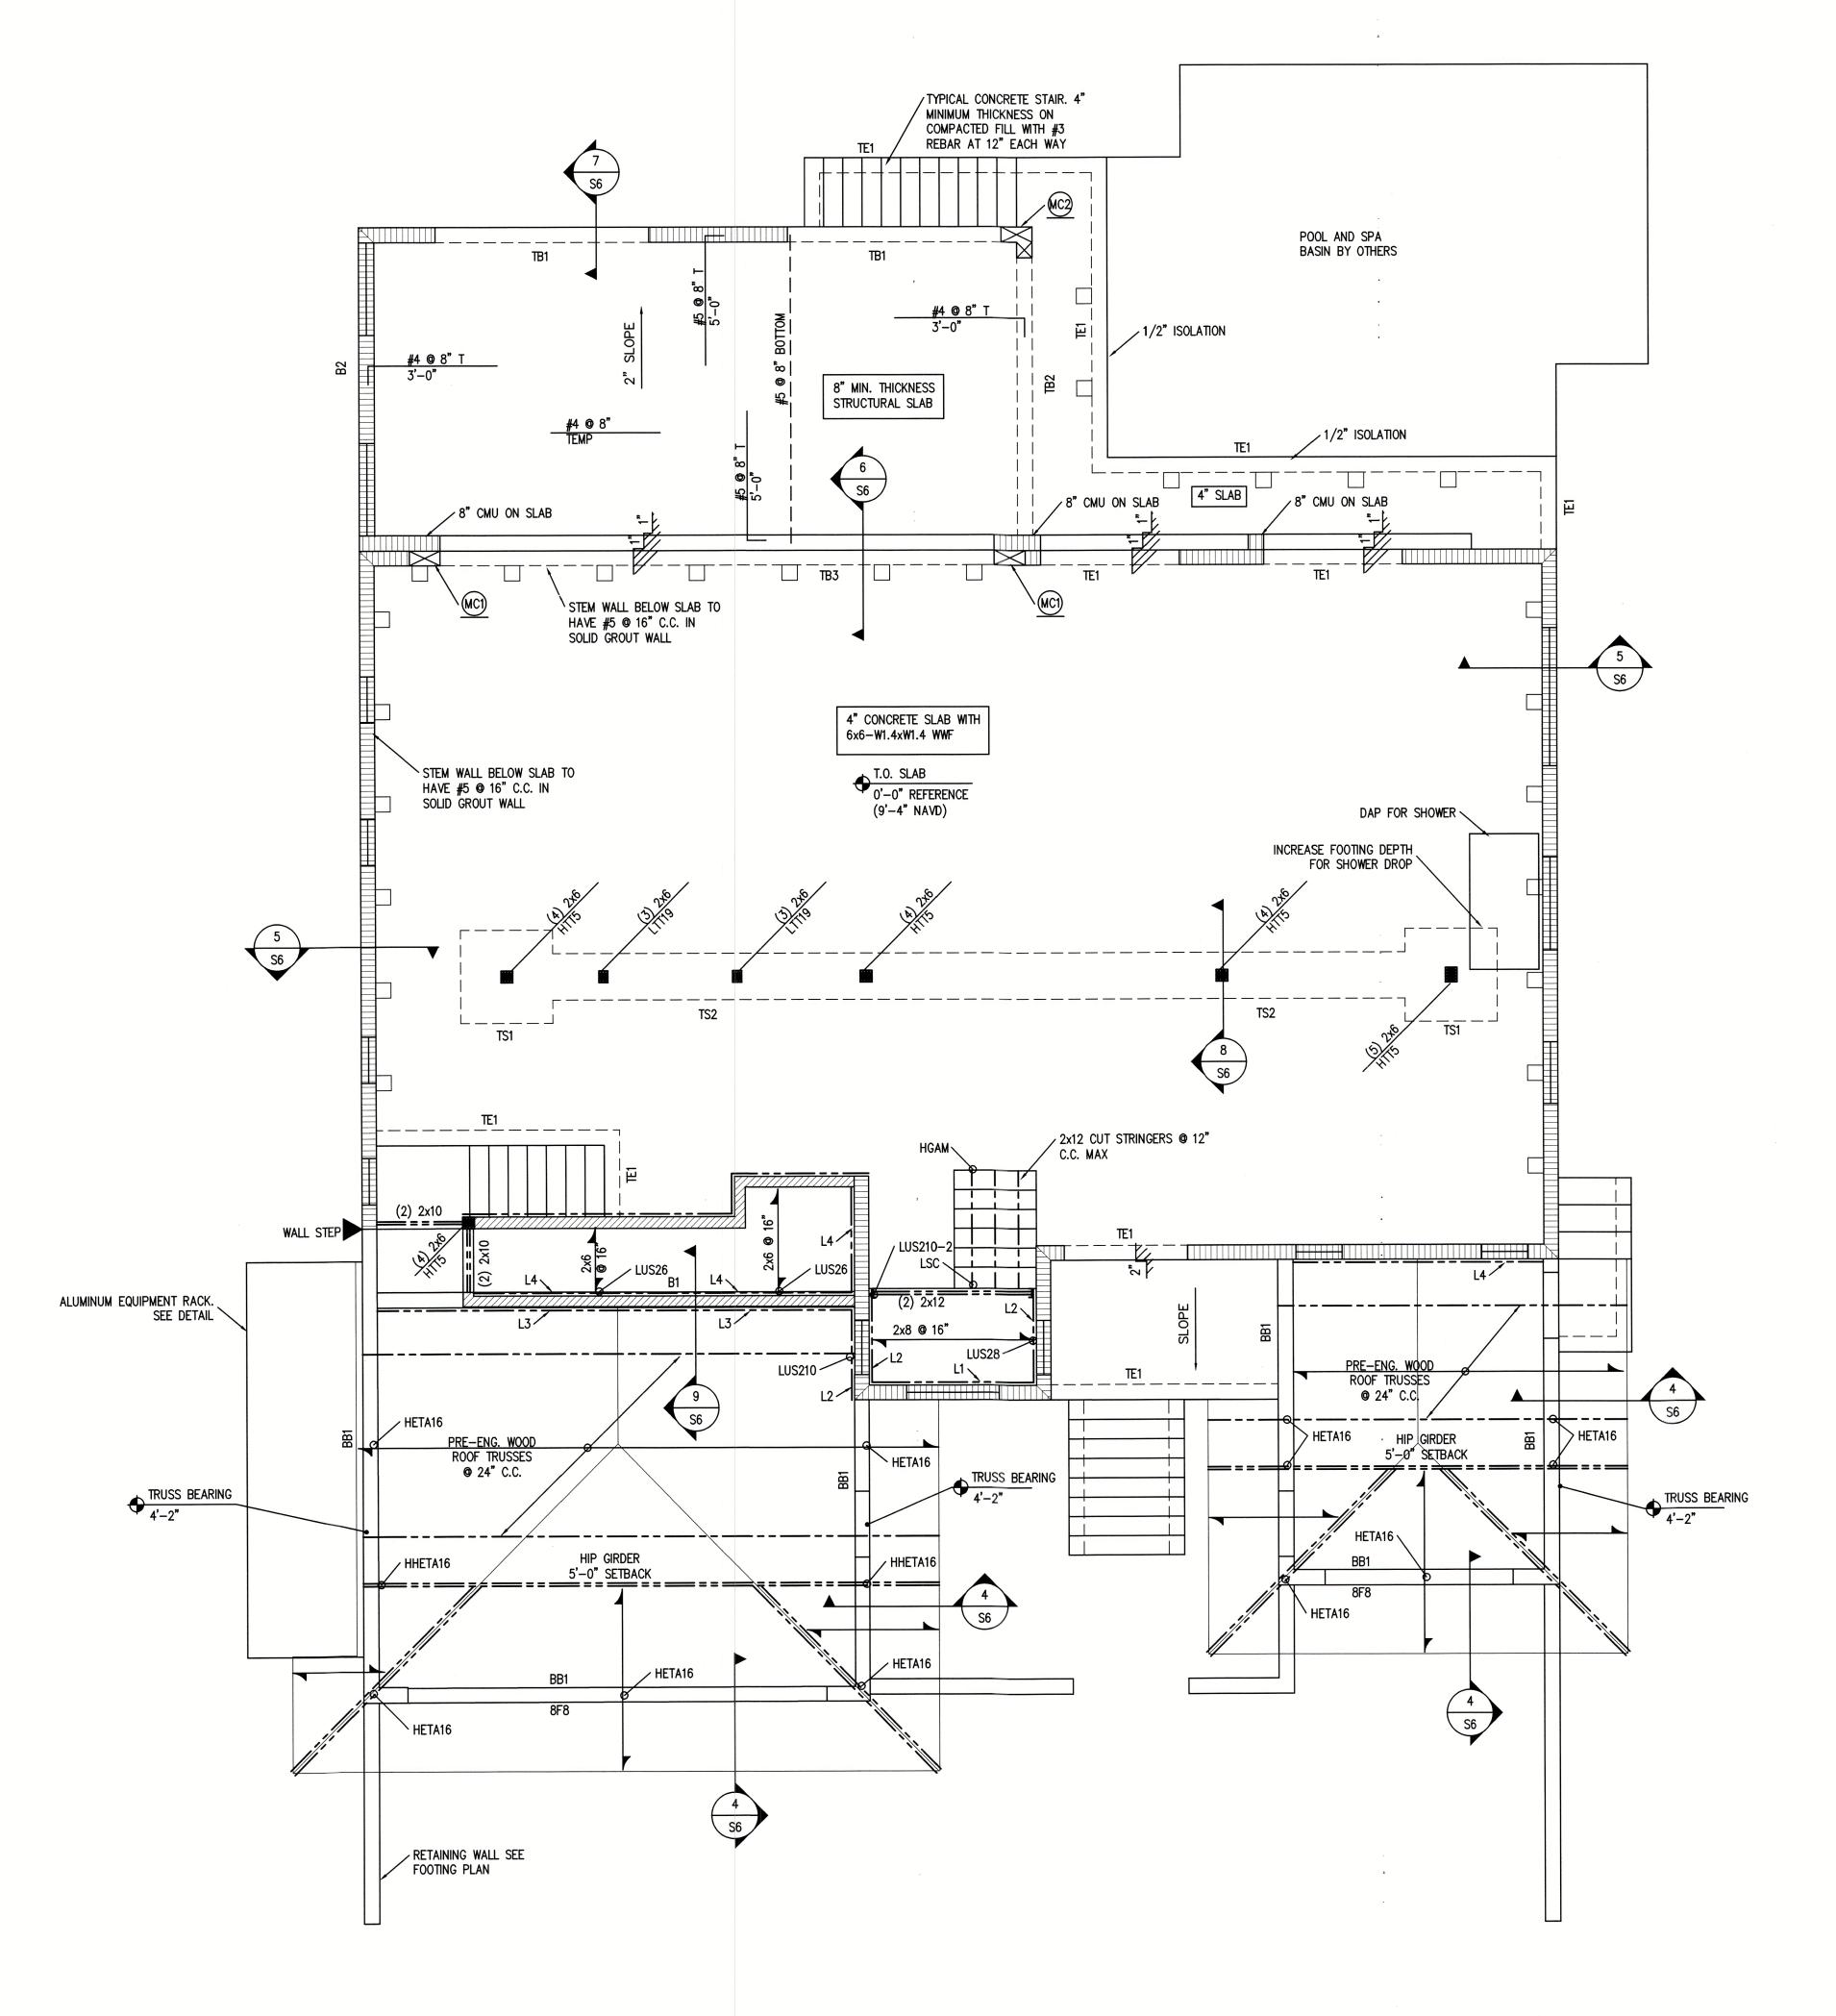

FIRST FLOOR FRAMING PLAN


SCALE: 1/4"=1'-0"

BEAM	ELEVATION	SIZE W x H	REINFOR	CEMENT	CLOSED HOOP	DEMARKS
NUMBER	(TOP OF BEAM)	(INCH)	TOP	воттом	SIZE AND SPACING	REMARKS
B1	4'-2"	8" × 28"	(2) #6	(2) #8	#3 © 10"	-
B2	SLOPED	8"x16" MIN	(2) #6	(2) #6	#3 @ 7"	_
TB1	(-) 0'-4"	8" × 16"	(2) #5	(2) #5	#3 © 16"	_
TB2	VARIES	8" × 16" MIN	(2) #5	(2) #5	#3 © 16"	_
TB3	0'-0"	8" × 16"	(2) #5	(2) #5	#3 © 16"	


	FOOTING SCHEDULE							
MARK	SIZE (W x L x D)	REINFORCEMENT	REMARKS					
TS1	4'-0" x 4'*0" x 12"	(5) #5 EACH WAY	THICKENED SLAB					
TS2	2'-0" x CONT x 12"	(3) #5 CONT.	THICKENED SLAB					
TE1	8" x CONT x 8"	(1) #5 CONT.	THICKENED SLAB					


PLAN NOTES:

- 1. VERIFY ALL DIMENSIONS, ELEVATIONS, CONDITIONS, DROPS & SLOPES WITH 'A' SHEETS
- 2. DENOTES 8" CMU WALL WITH #5 REBAR IN GROUT FILLED CELLS AT EDGES, DOOR & WINDOW JAMBS, CORNERS, INTERSECTIONS AND AT 32" C.C. MAX SPACING
- 3. DENOTES 2x6 @ 16" C.C. WOOD FRAME BEARING WALL WITH SOLID BLOCKING AT 48" C.C. ATTACH TO CONCRETE BELOW WITH LTT19 AT EVERY OTHER STUD (32: C.C.) PROVIDE 1/2"ø x 5" TITEN
- 4. SLAB SHALL BE A 4" CONCRETE SLAB WITH 6"x6" W1.4xW1.4 WWF PLACED ON VAPOR BARRIER ON COMPACTED FILL. LATERALLY SUPPORT MASONRY STEM WALLS BELOW UNTIL SLAB IS POURED AND 7 DAYS OLD. PROVIDE SAWN CONTROL JOINTS WITHIN 12 HOURS OF POURING CONCRETE. JOINT PATTERN SHALL BE APPROX SQUARE AND 10' SPACING.
- 5. L1 DENOTES 2x6 PT LEDGER WITH 1/2"ø x 5" TITENS @ 16"
- 6. L2 DENOTES (2) 2x10 PT LEDGER WITH 1/2" x 8" TITENS @ 12" STAGGERED
- 7. L3 DENOTES 2x6 PT LEDGER WITH (3) 16d NAILS AT 16" C.C.
- 8. L4 DENOTES 2x6 PT LEDGER WITH 1/4"x3-1/2" TAPCONS @ 8"
- 9. 8F8 DENOTES 8" PRECAST LINTEL WITH (1) #5 GROUTED SOLID UP TO BEAM ABOVE
- 10. BUILT UP COLUMNS SUCH AS (4) 2x6 SHALL BE ATTACHED TOGETHER WITH 12d NAILS @ 3" C.C. STAGGERED

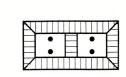

(4) #5 VERT

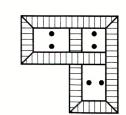

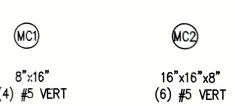








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|Thomas F Winkler
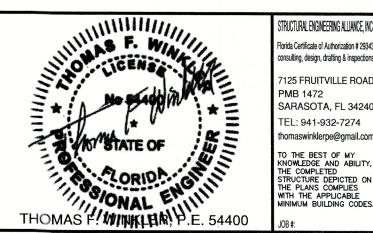
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Florida Certificate of Authorization # 2934

7125 FRUITVILLE ROAD

SARASOTA, FL 34240 EL: 941-932-7274

Plan no.

2021-50 S3.0

CUS'
BOI
759 N
LONG
PID:


RAFTING & ESIGN INC.

REVISIONS: NO. DESCRIP: BY DATE

DATE: 08-15-2022

SCALE: AS SHOWN

SHEET TITLE: 2ND FLOOR **FRAMING**

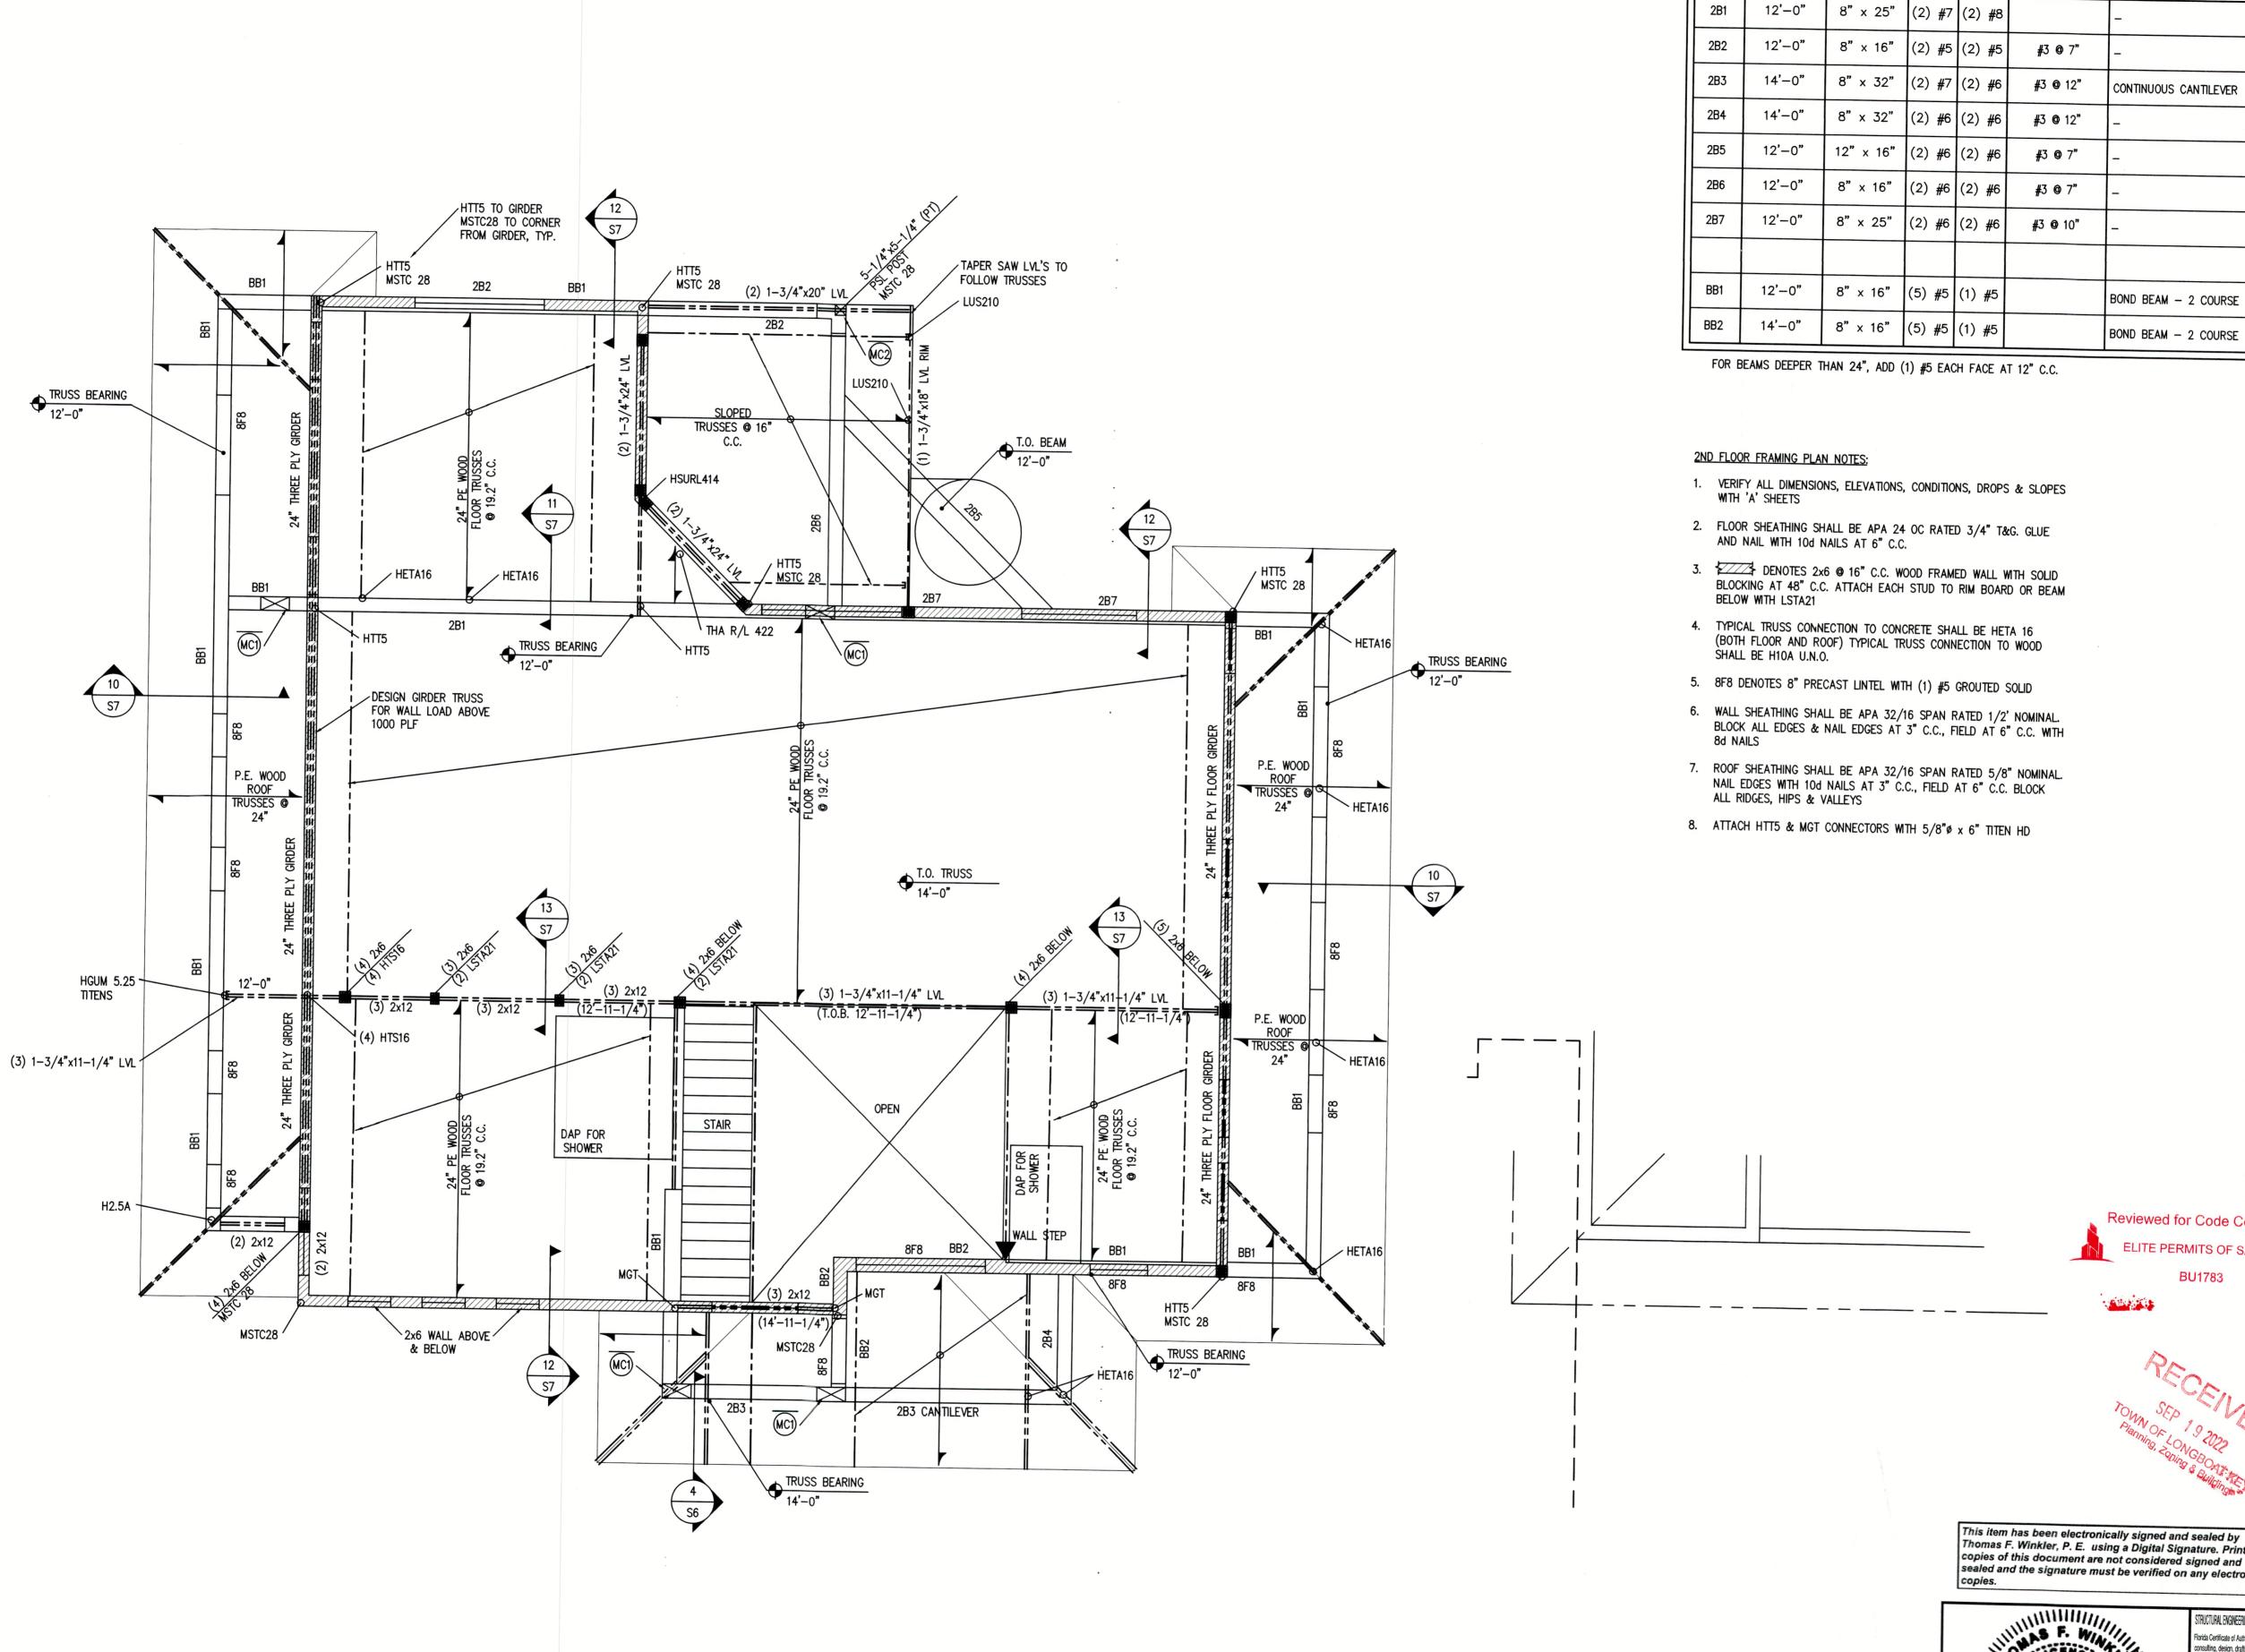

2ND FLOOR FRAMING PLAN
SCALE: 1/4"=1'-0"

BEAM SCHEDULE SIZE W x H (INCH) REINFORCEMENT BEAM ELEVATION NUMBER (TOP OF BEAM) CLOSED HOOP TOP BOTTOM SIZE AND SPACING REMARKS CONTINUOUS CANTILEVER

> Reviewed for Code Compliance ELITE PERMITS OF SARASOTA

> > BU1783

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125 FRUITVILLE ROAD

SARASOTA, FL 34240 EL: 941-932-7274

SCALE: AS SHOWN STRUCTURAL ENGINEERING ALLIANCE, INC Florida Certificate of Authorization # 29343 consulting, design, drafting & inspections

SHEET TITLE: SECOND FLOOR

FRAMING PLAN

Plan no.

2021-50 S4.0

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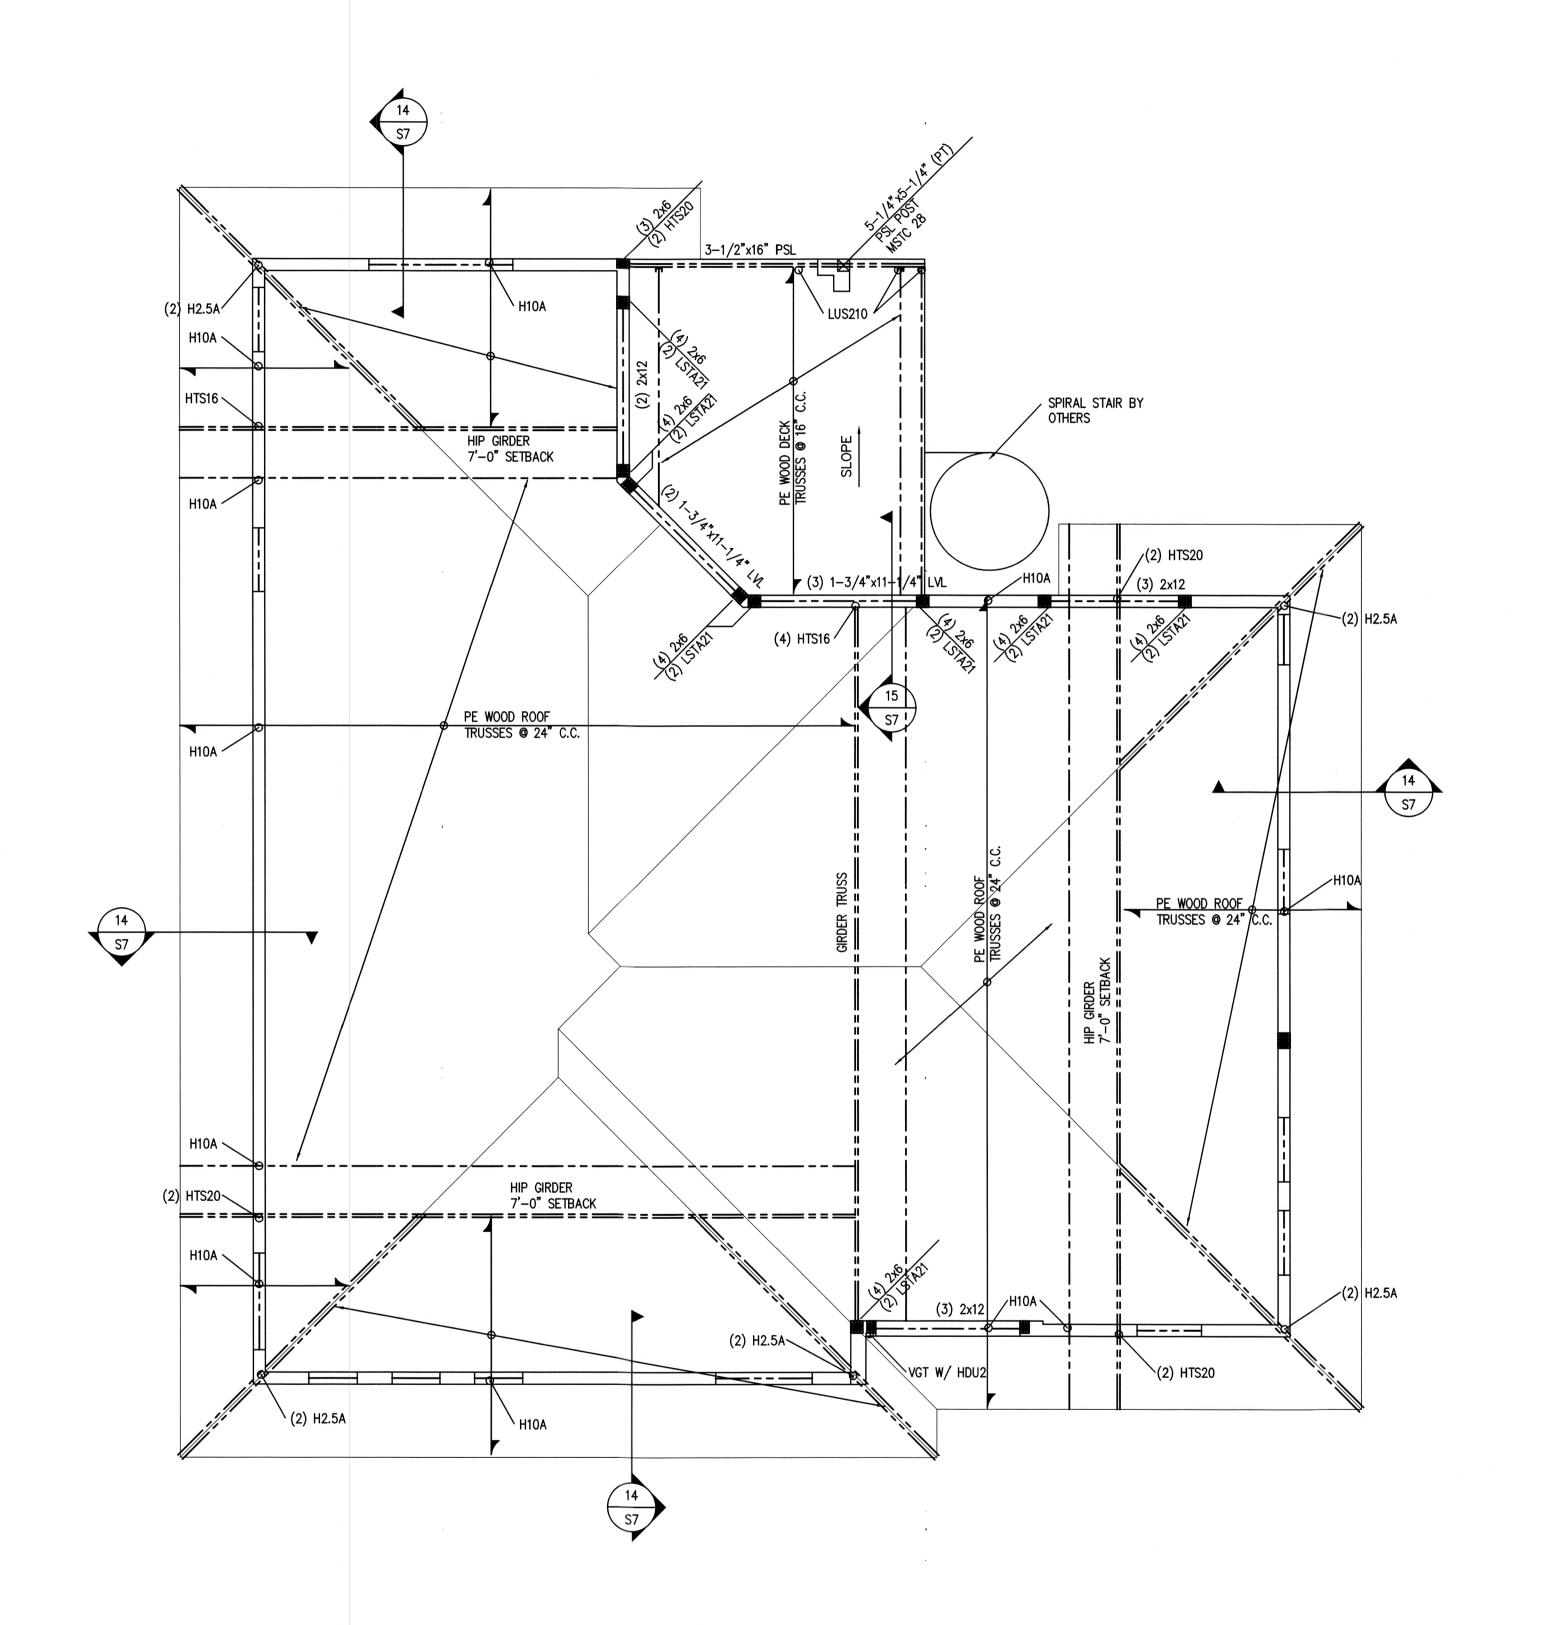
CUSTOM RESIDE BOB & AMY SPANOS
759 MARBURY LANE LONGBOAT KEY FL. 3'PID: 7871700006

RAFTING & ESIGN INC.

REVISIONS:

NO. DESCRIP: BY DATE

DATE: 08-15-2022



ROOF FRAMING PLAN
SCALE: 1/4"=1'-0"

ROOF FRAMING PLAN NOTES:

- VERIFY ALL DIMENSIONS, ELEVATIONS, CONDITIONS, DROPS & SLOPES WITH 'A' SHEETS
- 2. TYPICAL WINDOW OR DOOR HEADER SHALL BE (2) 2x10'S WITH LSTA21 EACH END WITH (3) 2x6 JAMBS (U.N.O.)
- 3. ROOF SHEATHING SHALL BE APA 32/16 SPAN RATED 5/8" NOMINAL. ATTACH WITH 10d NAILS AT 3" C.C. ON EDGES, 6" C.C. IN FIELD
- 4. WALL SHEATHING SHALL BE APA 32/16 SPAN RATED 1/2" NOMINAL. BLOCK ALL EDGES & NAIL ALL EDGES WITH 8d @3", FIELD @ 6"
- 5. FLOOR SHEATHING ON DECK SHALL BE APA 24 OC RATED 3/4" NOMINAL T&G. ATTACH WITH GLUE & 10d NAILS AT 6" C.C.

Plan no.

2021-50 S5.0



.228

FOR: RESIDENCE AMY CUST(BOBSPA)
SPAN
759 MA
LONGB(PID: 78)

RAFTING & ESIGN INC. Reviewed for Code Compliance

ELITE PERMITS OF SARASOTA

STRUCTURAL ENGINEERING ALLIANCE, INC Florida Certificate of Authorization # 29343 consulting, design, drafting & inspections

7125 FRUITVILLE ROAD PMB 1472 SARASOTA, FL 34240

TEL: 941-932-7274 thomaswinklerpe@gmail.com

TO THE BEST OF MY KNOWLEDGE AND ABILITY, THE COMPLETED STRUCTURE DEPICTED ON THE PLANS COMPLIES WITH THE APPLICABLE MINIMUM BUILDING CODES.

Digitally signed by Thomas F Winkler

Date: 2022.08.14 20:26:40 -04'0

This item has been electronically signed and sealed by Thomas F. Winkler, P. E. using a Digital Signature. Printed copies of this document are not considered signed and sealed and the signature must be verified on any electronic

THOMAS F. WINKLER, P.E. 54400

Thomas F

Winkler


REVISIONS: NO. DESCRIP: BY DATE

DATE: 08-15-2022


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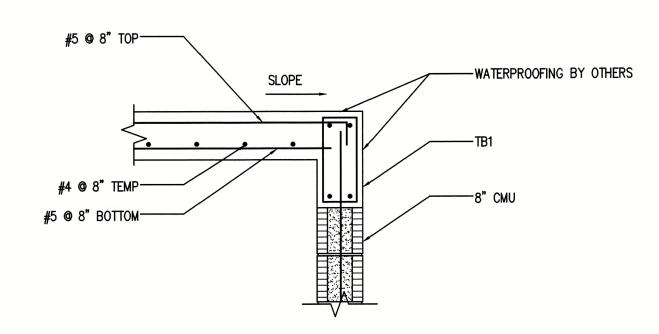
HIGH ROOF FRAMING PLAN






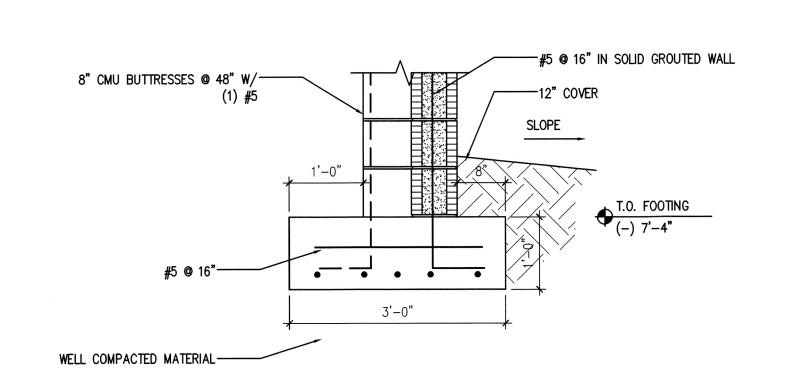


4 SECTION S6 SCALE: 3/4"=1'-0"

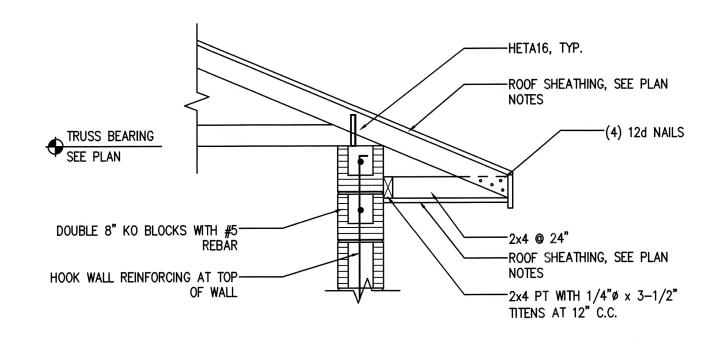


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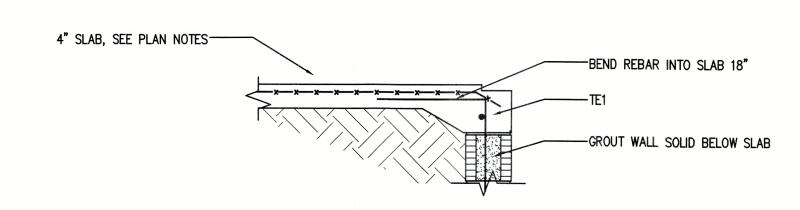
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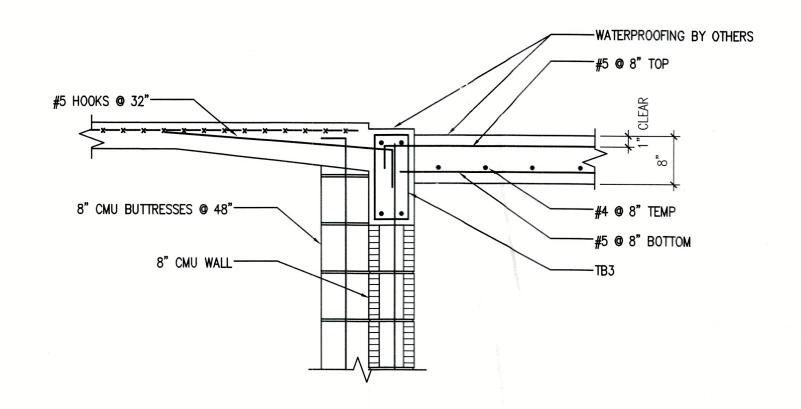


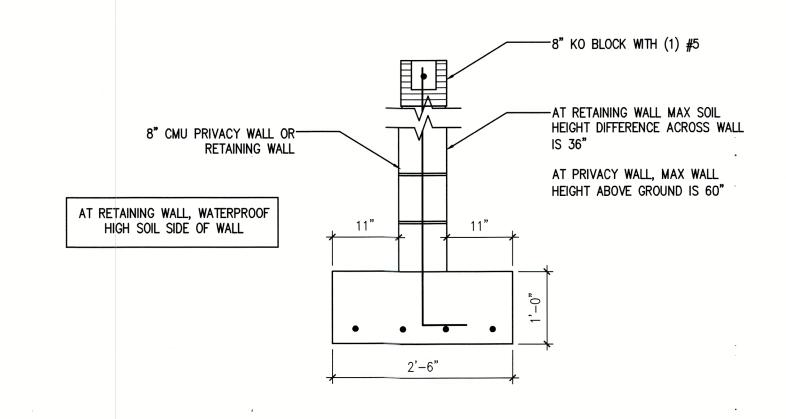


8 SECTION S6 SCALE: 3/4"=1'-0"

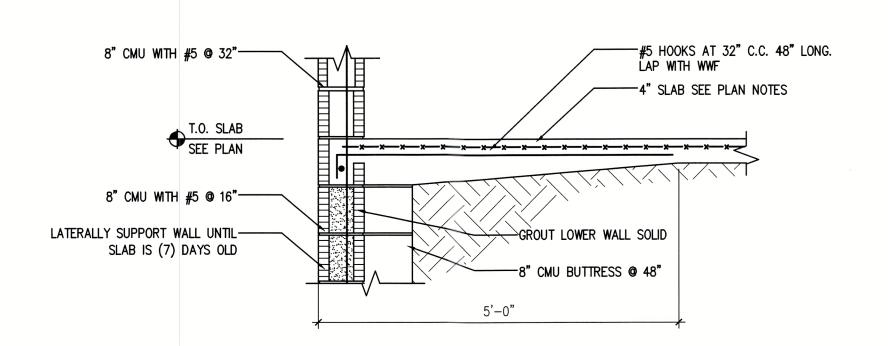


3 SECTION S6 SCALE: 3/4"=1'-0"

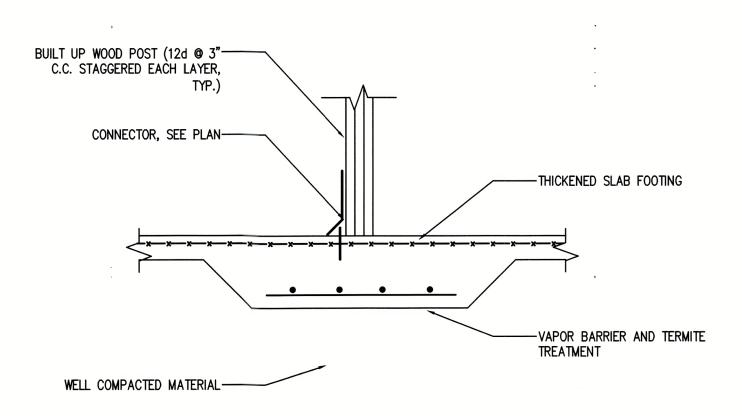

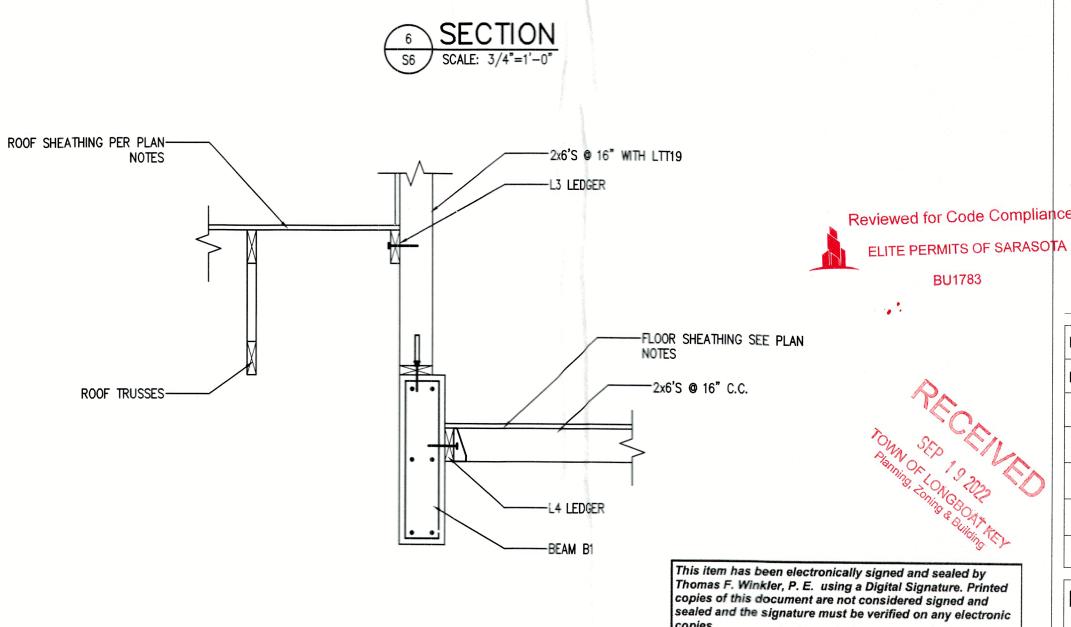

9 SECTION S6 SCALE: 3/4"=1'-0"

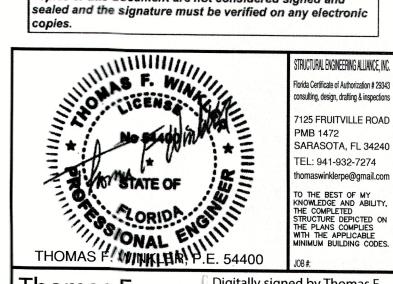

Thomas F Winkler

Digitally signed by Thomas F Winkler Date: 2022.08.14 20:27:20 -04'00'

Plan no. 2021-50 S6.0

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34228

FOR:

STOM RESIDENCE CUS BO SP 759 LONG

RAFTING & ESIGN INC.


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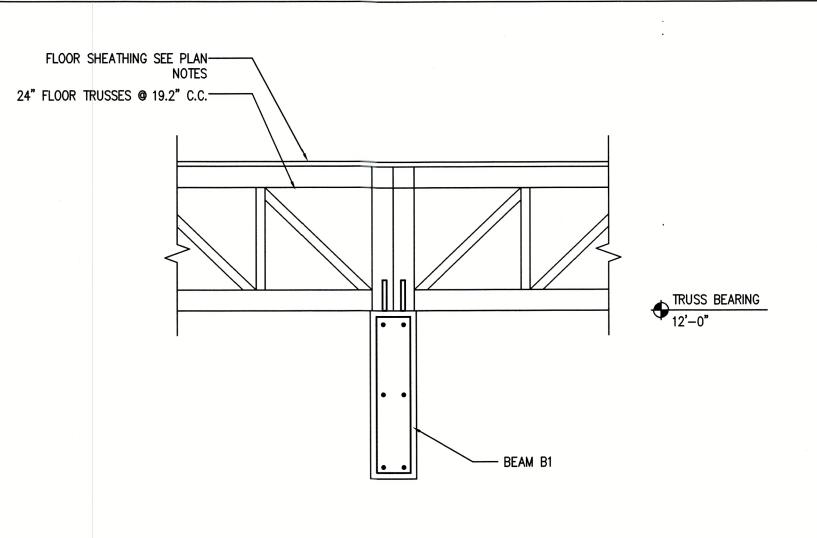
DATE: 08-15-2022


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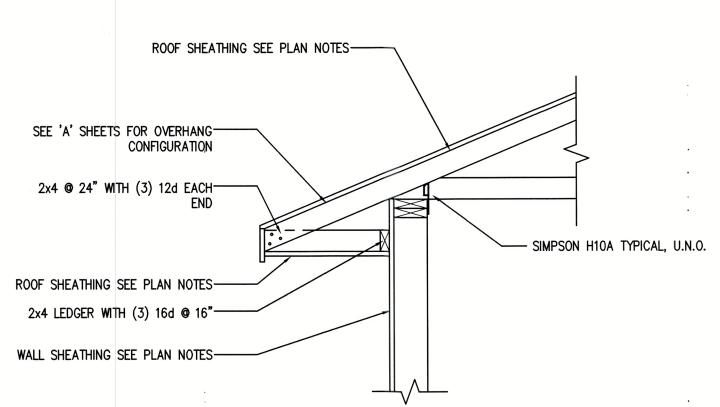
SHEET NO. S6.0








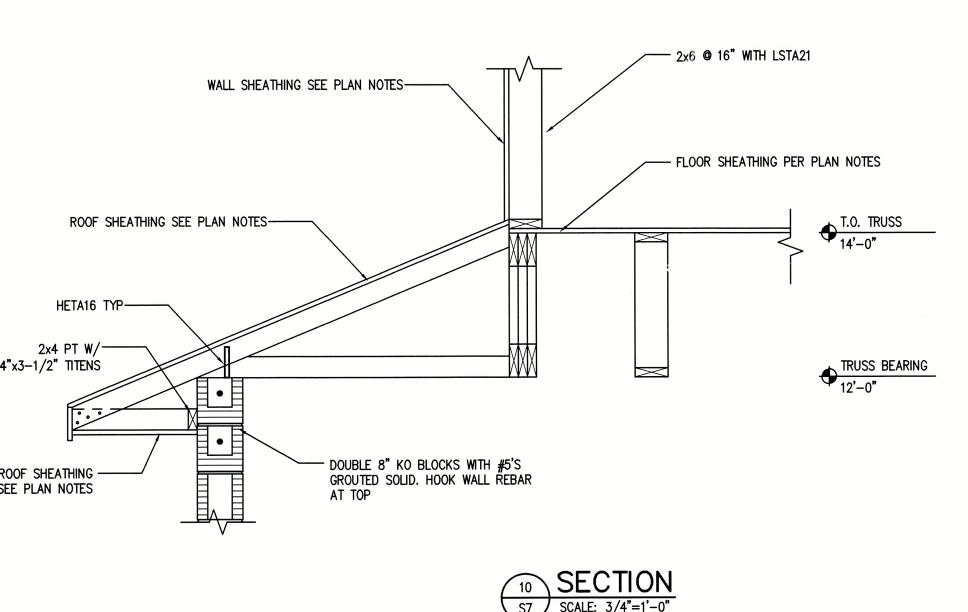

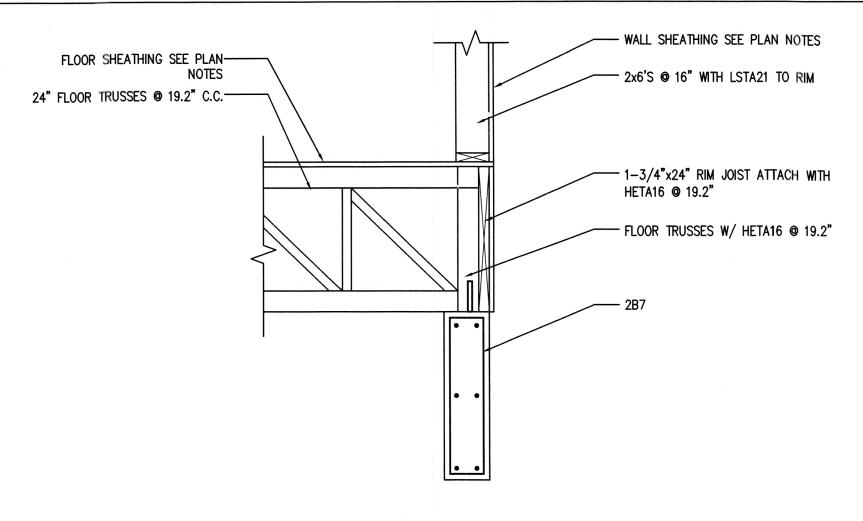

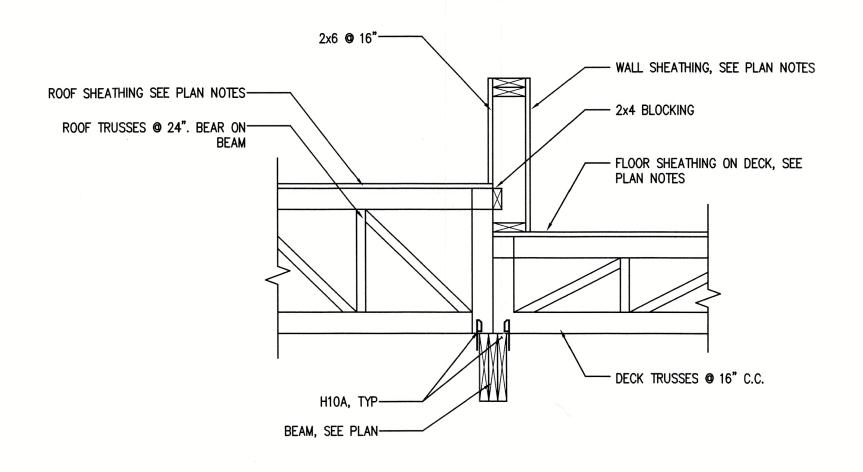












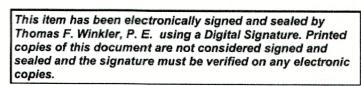

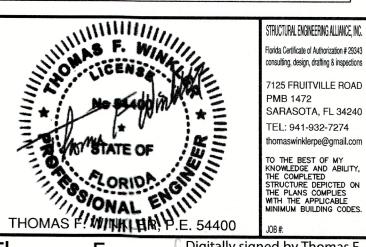

thomaswinklerpe@gmail.com TO THE BEST OF MY
KNOWLEDGE AND ABILITY,
THE COMPLETED
STRUCTURE DEPICTED ON
THE PLANS COMPLES
WITH THE APPLICABLE
MINIMUM BUILDING CODES. THOMAS F. WINKLER P.E. 54400 Digitally signed by Thomas F Thomas F Date: 2022.08.14 20:27:44 Winkler

-04'00'

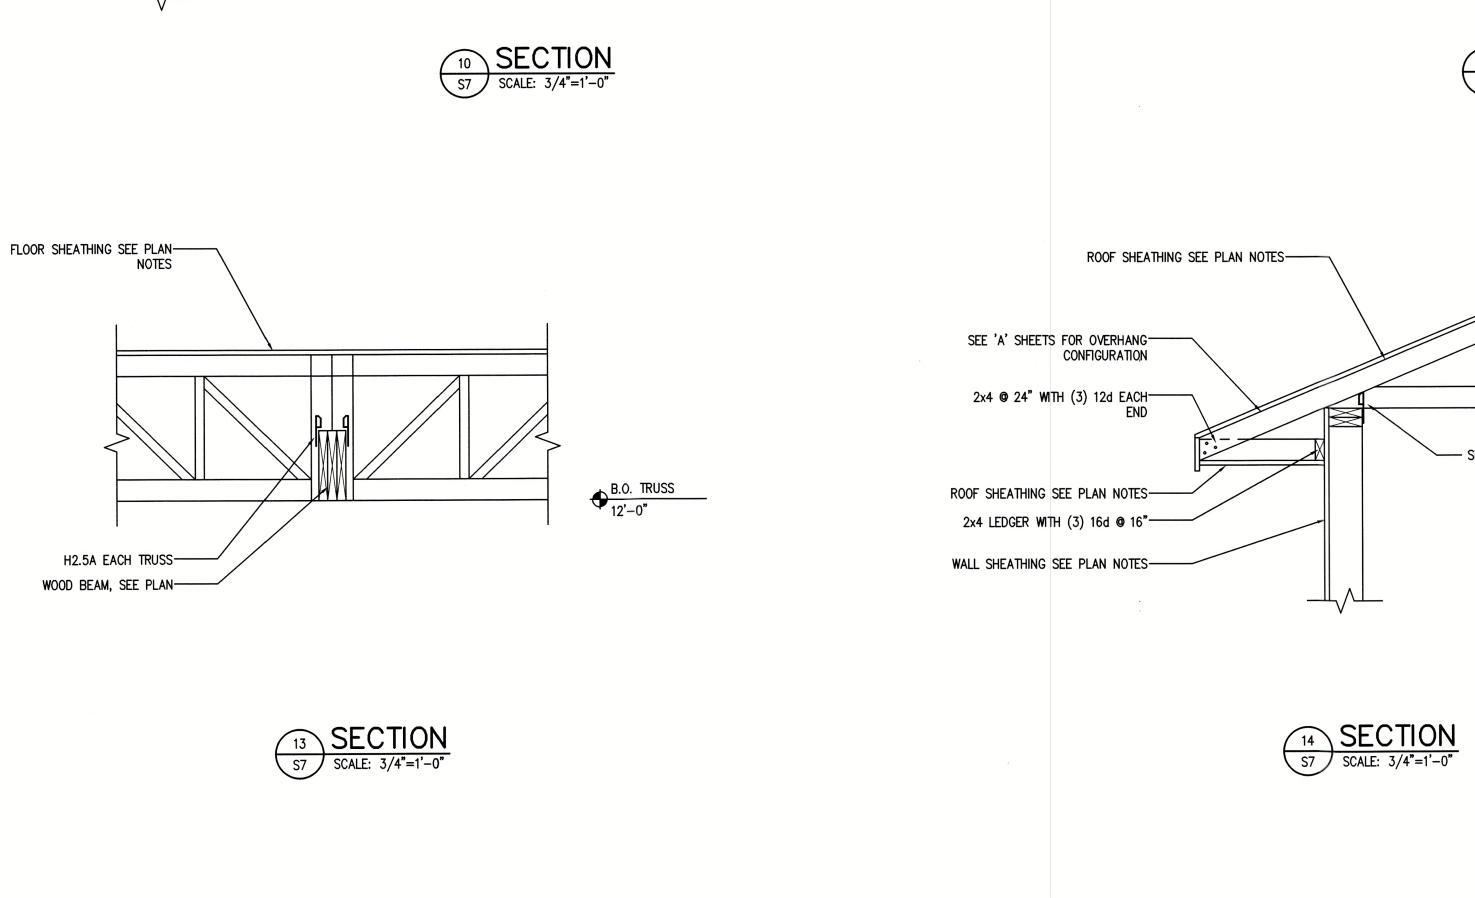

FOR: CUSTOM RESIDENCE F
BOB & AMY
SPANOS
759 MARBURY LANE
LONGBOAT KEY FL. 34228
PID: 7871700006 RAFTING & ESIGN INC. REVISIONS: NO. DESCRIP: BY DATE DATE: 08-15-2022 SCALE: AS SHOWN SHEET TITLE: **DETAILS** SHEET NO.

Plan no.

2021-50 S7.0

A R

* THESE DRAWINGS ARE NOT TO BE SCALED. *