hese drawings, when signed and sealed, are an indication

sing a digital signature. Printed copies of this cument are not considered signed and sealed and e signature must be verified on any electronic copies

590 Companion Way

Longboat Key, FL



HETSTONE ENGINEERING neEng.com & TESTING, INC. Bradenton, FL 34211 Certificate of Authorization #9298 Date: 2022.11.28

Digitally signed by L. Jason Berger DN: c=US, st=Florida, I=Bradenton, o=Whetstone Engineering & Testing, Inc., cn=L. Jason Berger, email=Jason@Whetsto Reason: I am approving this document 15:04:48 -05'00'

TOWN OF LONGBOAT KEY · Planning, Zoning & Building

PRIVATE PLAN REVIEW WEINTRAUB INSPECTIONS & FORENSIC, INC. REVIEWED FOR CODE COMPLIANCE 3777 11/29/2022

DRAWING INDEX


PLOT PLAN FLOOR PLAN - GROUND FLOOR FLOOR PLAN - SECOND FLOOR SECOND FLOOR LAYOUT PLAN

ROOF PLAN EXTERIOR ELEVATIONS EXTERIOR ELEVATIONS BUILDING SECTIONS


ELECTRICAL PLAN - GROUND FLOOR ELECTRICAL PLAN - SECOND FLOOR **ENGINEER'S DETAIL SHEET** ENGINEER'S DETAIL SHEET ENGINEER'S DETAIL SHEET

FL 34211


Residence

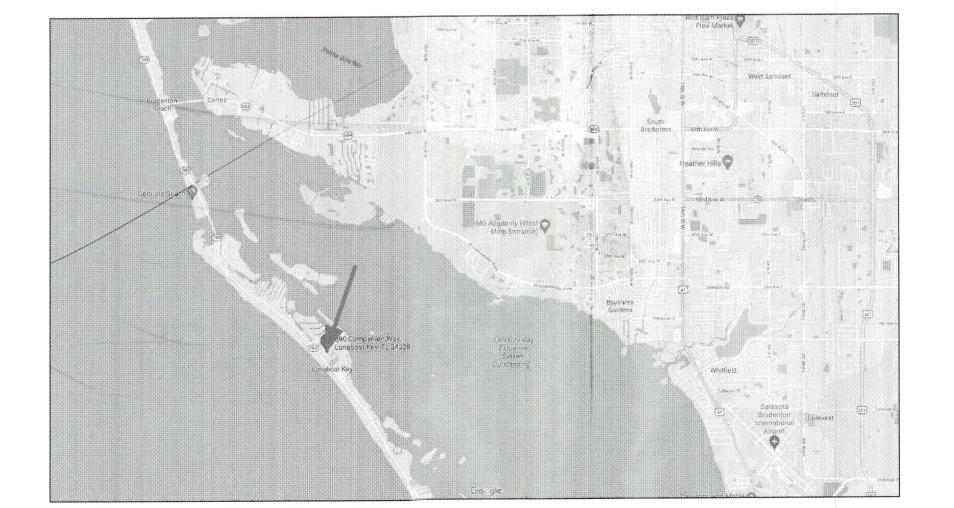

LOCATION MAP

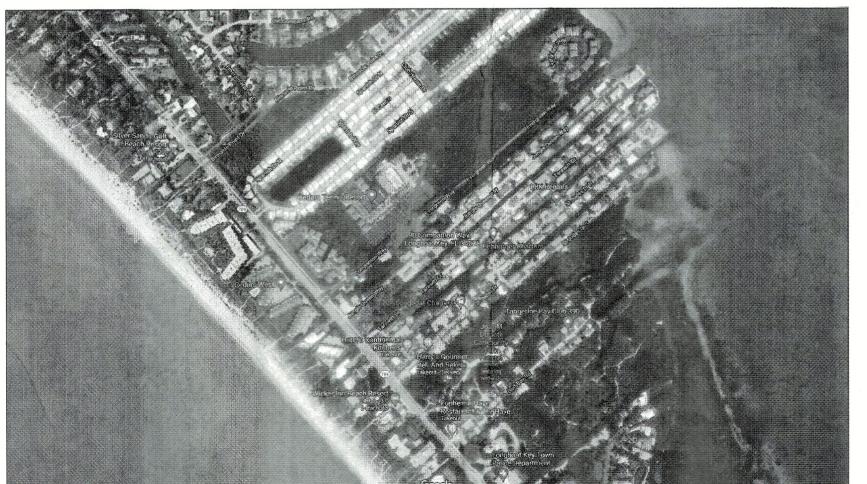



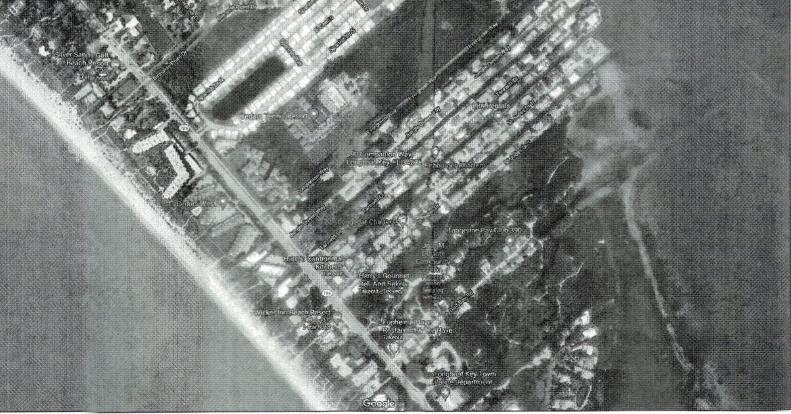

DATA SUMMARY

APPLICABLE CODES: 2020 FLORIDA RESIDENTIAL CODE

EDGE STRIP = 4'-0" FROM OUTSIDE CORNERS 3. BUILDING USE: SINGLE FAMILY RESIDENCE.

5. WINDBORNE DEBRIS REGION ----- YES

4. CONSTRUCTION TYPE V, UNPROTECTED, UNSPRINKLED


2020 FLORIDA MECHANICAL CODE 2020 FLORIDA PLUMBING CODE 2020 FLORIDA ACCESSIBILITY CODE

2020 FLORIDA ENERGY CODE

NFPA70 - 2017 NEC

NEW 2-STORY RESIDENCE 2,189 SF. A/C & A,723 SF. UNDER ROOF FIN. FLR ELEV. = 14.50' N.A.V.D. (MIN. 18' ABOVE CROWN OF ROAD) PROPOSED DRIVEWAY - ROOF OVERHANG POOL BY OTHERS PLOT PLAN
SCALE: 1"=10'-0" **NPDES**

These drawings, when signed and sealed, are an indication that Whetstone Engineering & Testing, Inc. has reviewed the structural components only of the structure for conformance with the Florida Residential Code 7th Edition (2020). No other certification, inclusive of architectural elements and dimensional accuracy, etc. is expressed or implied.

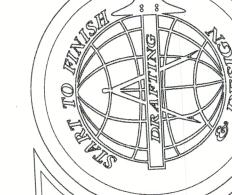

Start To Finish Drafting

Residence The Wilson-Bringle R
590 Companion W
Longboat Key, Fl

RECEIVED

DEC 0 1 2022 TOWN OF LONGBOAT KEY Planning, Zoning & Building


PRIVATE PLAN REVIEW
WEINTRAUB INSPECTIONS & FORENSIC, INC
REVIEWED FOR CODE COMPLIANCE SIGNATURE
3777 11/29/2022
PANIMBER DATE

LOT COVERAGE	
LOT AREA: BUILDING FOOTPRINT	8,400 S.F. 2,448 S.F.
OTHER BLDG STRUCTURES IMPERVIOUS MATERIALS: DRIVEWAYS POOL & DECK SIDEWALKS & MISC.	000 948 S.F. 768 S.F. 19 S.F.
TOTAL BUILDING AREA (MAX. 30%)	2,448 S.F. 29.14%


TOTAL IMPERVIOUS AREA (MAX. 50%)

4,183 S.F. 49.80%

Date: 06-20-22 Drawn By: SLL/VN Job #: 21-012 Checked By: JMK Revisions No.DateChange18-31-22BUILDING DEPT. REVISIONS211-21-22EXISTING GRADE REVISIONS34 SHEET

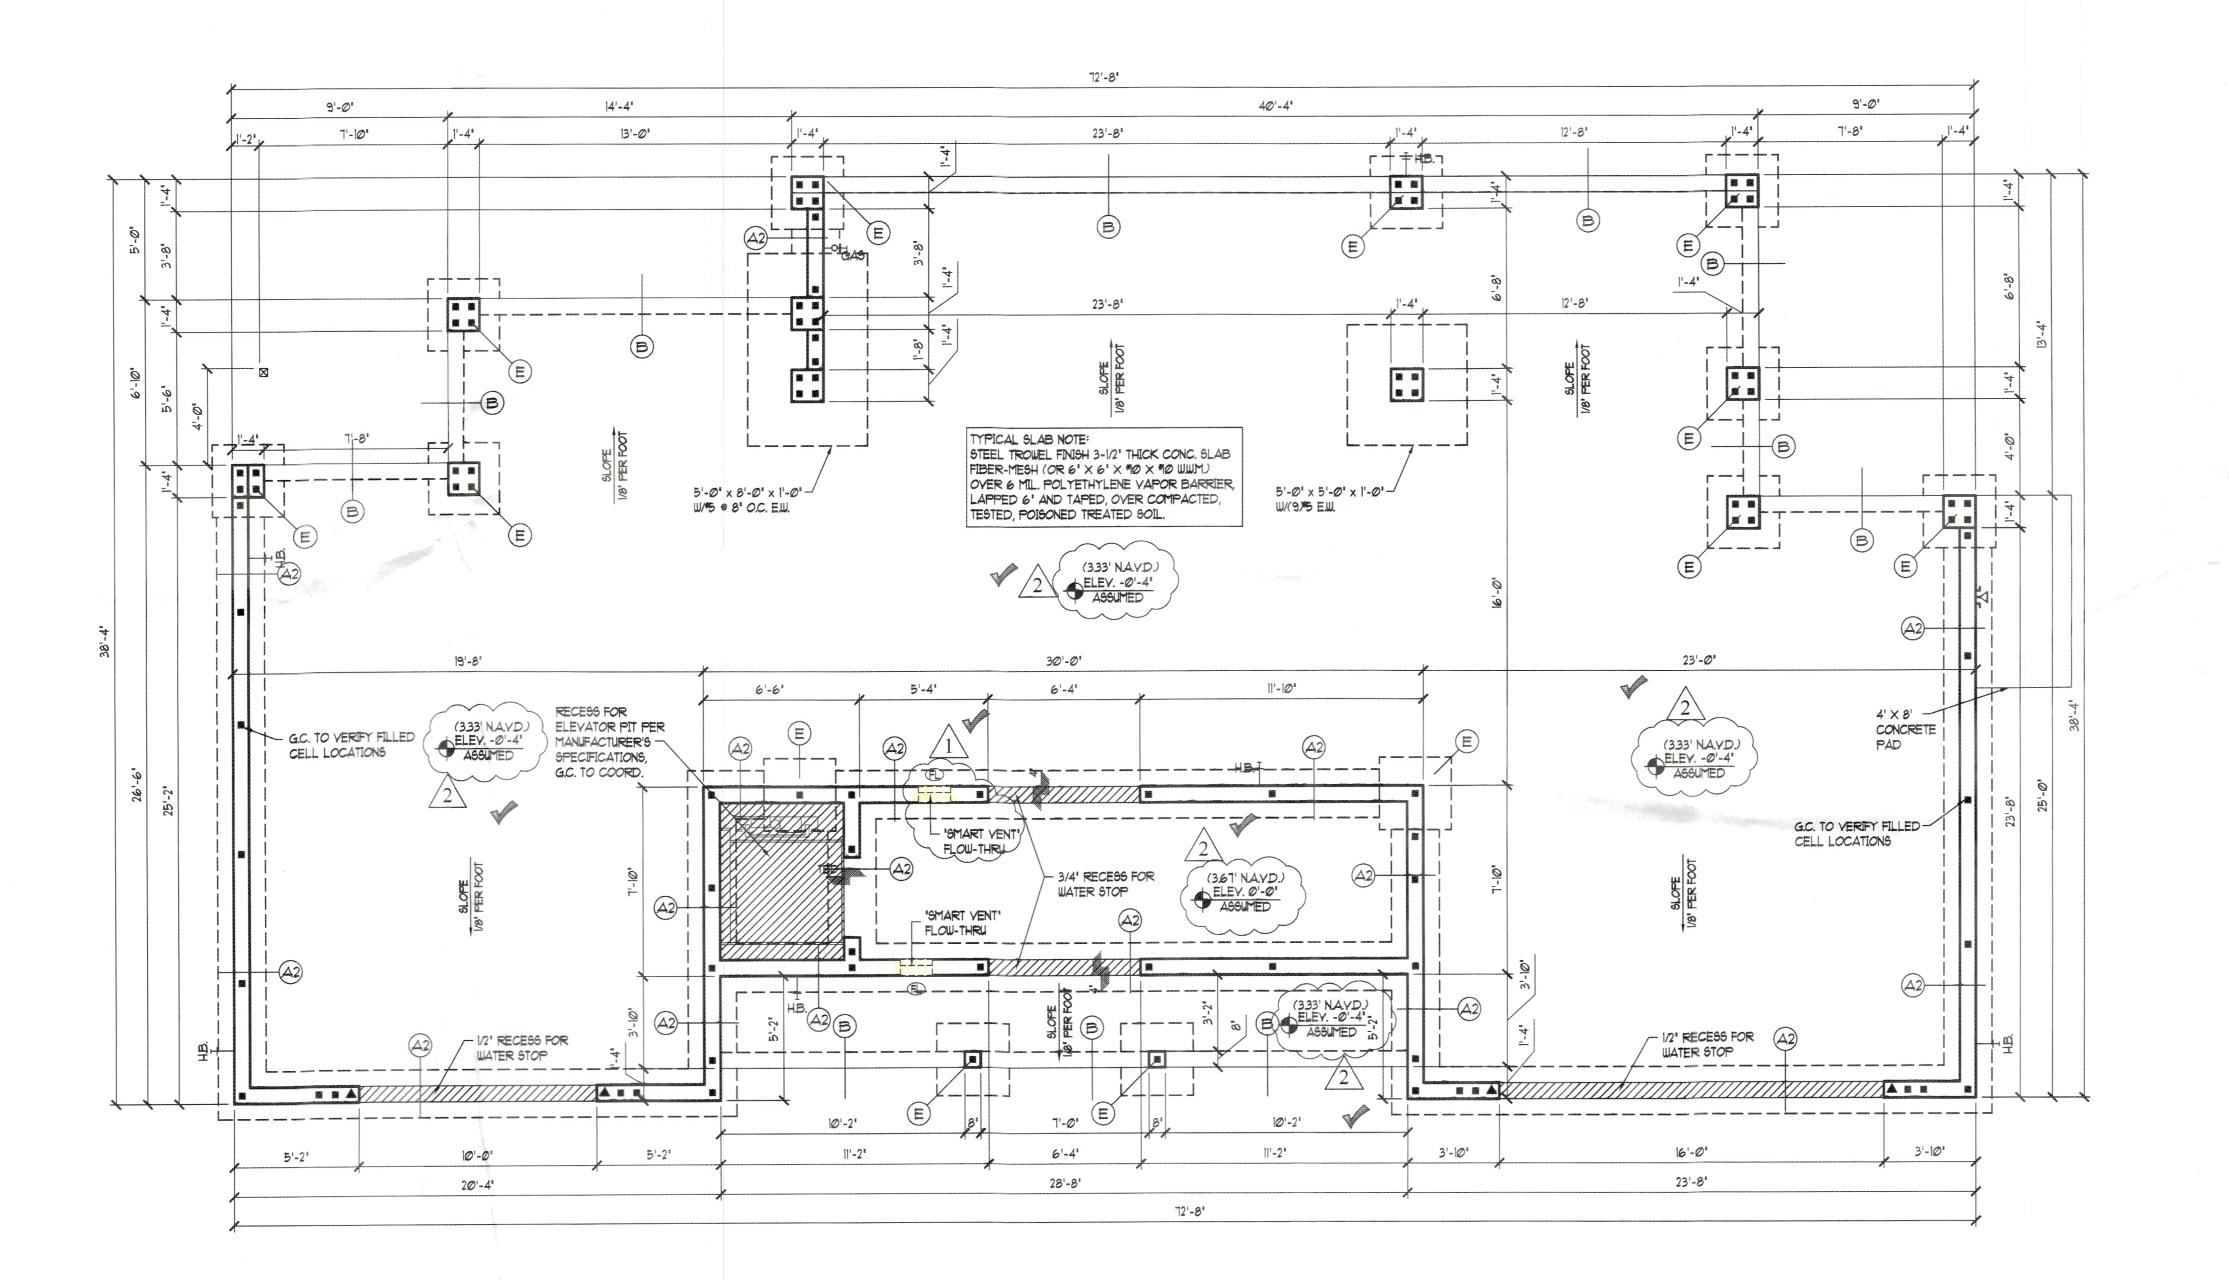




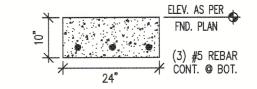


STEM WALL FTG. 2-STORY

SCALE: 1/2"=1'

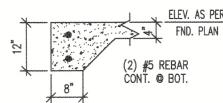

B TURNED DOWN FTG.

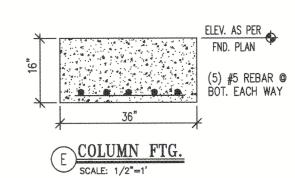

DEC 0 1 2022

TOWN OF LONGBOAT KEY Planning, Zoning & Building PRIVATE PLAN RÉVIEW
WEINTRAUB INSPECTIONS & FORENSIC, INC
REVIEWED FOR CODE COMPLIANCE

3777 11/29/2022

FLOW THROUGH CALCULATIONS
@ 1" PER 1 SQ.FT.

235 SF **FOYER** TOTAL SQ. IN. FLOW REQUIRED: 235 SQ. IN. = 1.63 SF

PROVIDED FLOW THROUGHS (2) 8" x 16" SMART VENTS (200 SF. EA.) 2 x 200 S.F. = 400 SQ.IN. = 2.78 SF

 $(FL) = 16"W \times 8"H FLOW-THRU VENT$

NOTE: FLOW THROUGH TO BE "SMART VENT"

STRUCTURAL NOTES:

ENGINEER OF RECORD.

1. ALL FOUNDATION AND SLAB CONCRETE SHALL BE 3000 P.S.I. AT 28 DAYS

2. ALL CONTROL JOINTS SHALL BE SAWN WITHIN 12 HOURS OF CONC. POUR.

3. SLAB ON GRADE SHALL BE STEEL TROWEL

FINISHED 3-1/2" THICK REINFORCED WITH FIBER MESH OVER 6 MIL. POLYETHYLENE VAPOR BARRIER LAP 6" MIN.TAPE JOINT. 4. INSPECTION OPENING SHALL BE PROVIDED AT THE BOTTOM OF ALL GROUTED CELLS AT EACH ROD FOR FIELD INSPECTION. OPENINGS SHALL BE COVERED

AFTER INSPECTION AND BEFORE GROUTING. WALLS SHALL CURE A MIN. OF 24 HOURS PRIOR TO FILLING GROUTED CELLS.

5. STEEL REINFORCING SHALL BE GRADE 60. 6. ANY ONE #5 DOWEL MAY BE REPLACED BY DRILLING
A 3/4" X 8" DEEP HOLE, PROPERLY CLEAN SAME, AND INSTALLING A REPLACEMENT DOWEL W/ SIMPSON SET-XP EPOXY, WHEN INSPECTED BY AUTHORIZED COUNTY PERSONAL. THIS PRE-APPROVED REPAIR IS LIMITED TO A MAXIMUM OF (3) THREE DOWELS ON ANY

ONE HOUSE AND NO (2) SIDE BY SIDE. THESE TWO CONDITIONS WOULD REQUIRE A SITE VISIT BY THE

FOUNDATION PLAN LEGEND

_ _ _ _ = FRAME BEARING/PLUMBING WALL ABOVE = NEW CMU WALL

NOTE: ALL CMU WALLS ARE DESIGNED AS SHEARWALLS EDETT = 'SMART VENT' FLOW THRU


(1) *5 REBAR AT CORNERS, INTERSECTIONS, EACH SIDE OF OPENINGS & AT 6'-0' O.C. MAX, TYP.


▲ (2) *5 REBAR OR (1) *1 FOR OPENINGS 16'-0" OR LARGER, TYP.

(1) \$ REBAR RETROFIT (FOR RENOVATION) ● 5/8'X6' LONG TITEN HD W/ 3'X3'X1/8' WASHER @ 18' O.C. ON BOTTOM PLATE, 6-12" FROM ENDS OF WALLS

(1) *5 REBAR BELOW SLAB (IN STEMWALL) OR



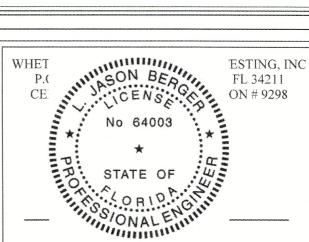

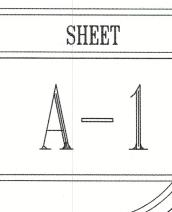

Residence Way FL CUSTOM HOME

Drafting

Finish


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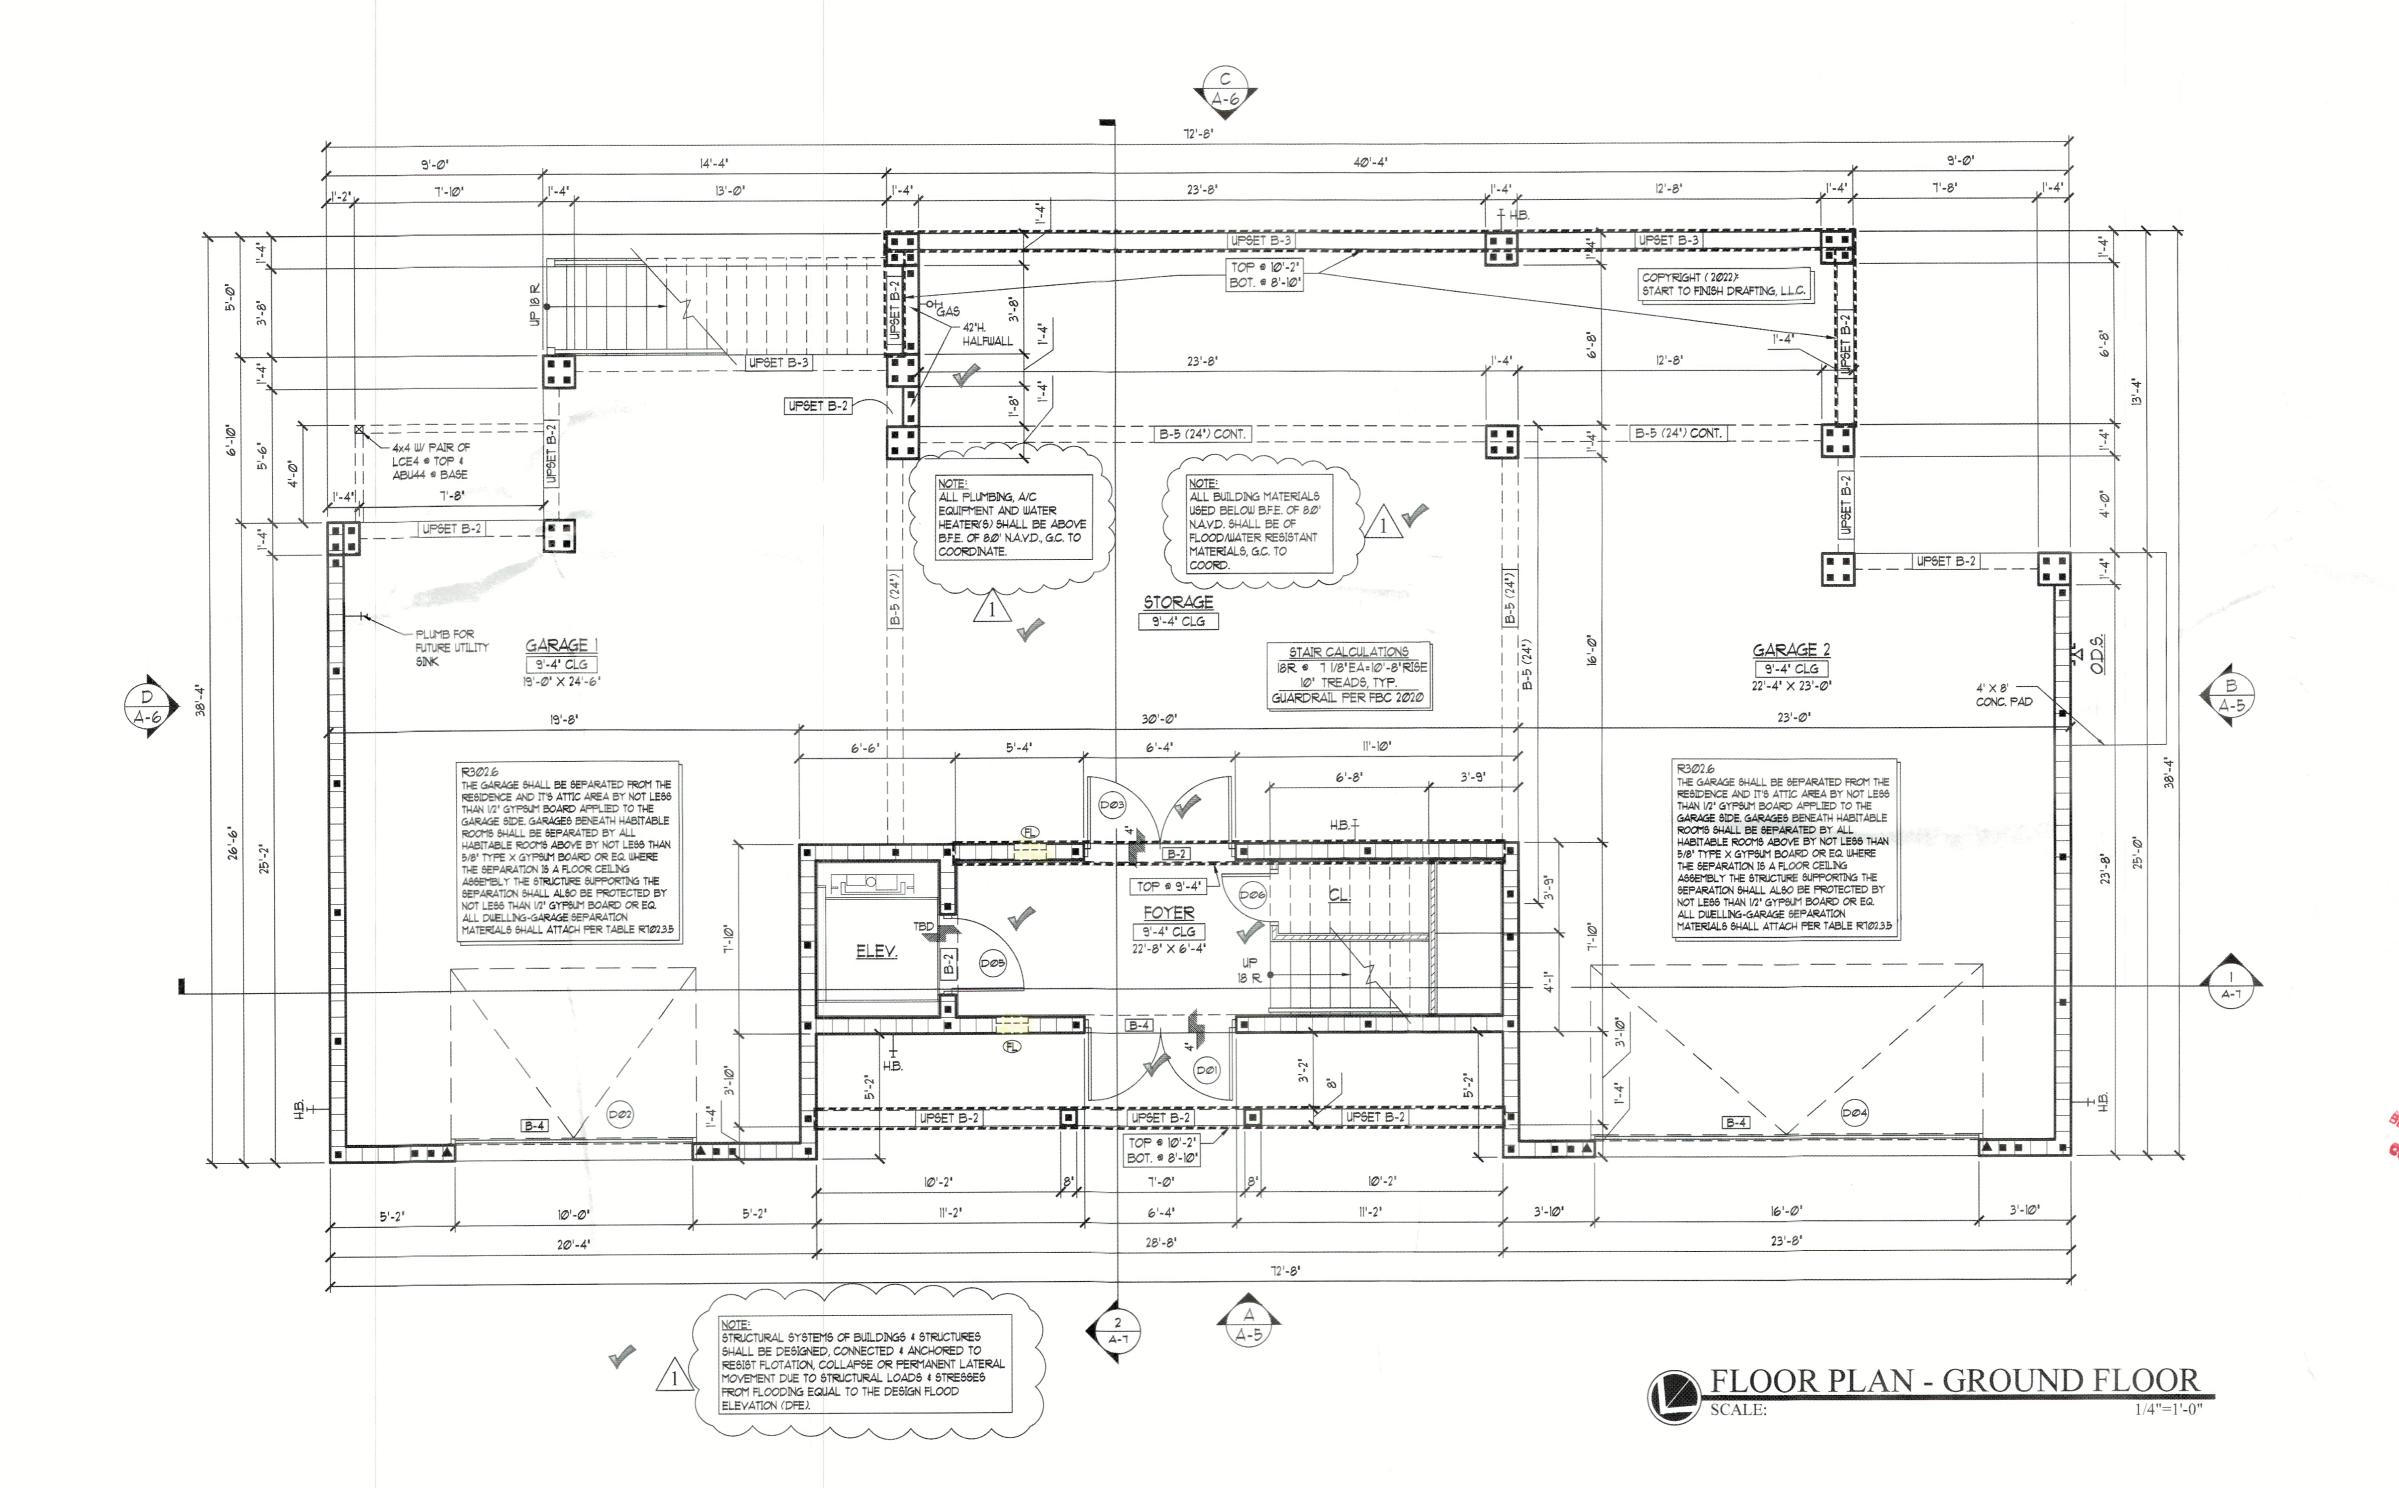
Wilson-Bringle 590 Companion Longboat Key,

Change
22 BUILDING DEPT. REVISIONS
22 EXISTING GRADE REVISION wn By: scked By: -20-

PRIVATE PLAN REVIEW WEINTRAUB INSPECTIONS & FORENSIC, INC. REVIEWED FOR CODE COMPLIANCE 3777 11/29/2022



	DOOR SCHEDULE							
MADIC	445V 6774.5		OPE	NING	PRESSURES		DELANDIC	
MARK	STYLE	WIDTH	HEIGHT	(+	~	REMARKS		
D01	(2) 3080	HINGED	6'-0"	8'-0" (38.0	40.0	<u>-</u>	
D02	10080	O.H.D SECT.	10'-0"	8'-0"	36.0	39.0		
D03	(2) 3080	HINGED	6'-0"	8'-0"	38.0	40.0	_// 1	
D04	16080	O.H.D SECT.	16'-0"	8'-0" (35.0	38.0)-	
D05	3080	HINGED	3'-0"	8'-0"		J		
D06	2080	HINGED	2'-0"	8'-0"		-		

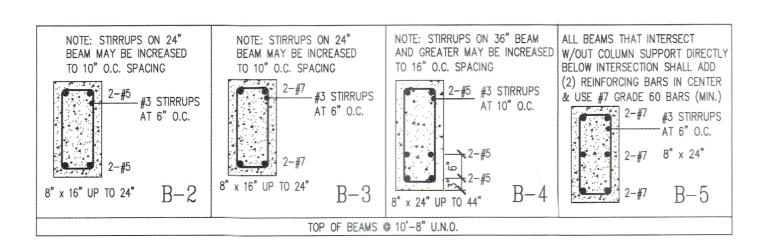



_		
	FLOOR AREAS - GROUND FLOOR	
	A/C SPACE	235 S.
	FRONT ENTRY	110
	GARAGE 1	524
	GARAGE 2	578
	STORAGE	1,001
	FLOOR AREAS - 1ST FLOOR	
	A/C SPACE	1,954 S.
	COVERED PORCH	110
	COVERED LANAI	211
	UNCOVERED DECK	112

TOTAL UNDER ROOF 4,723 S.F.

GENERAL NOTES:

TOTAL AREAS

NON-A/C SPACE

A/C SPACE

GENERAL CONTRACTOR AND ALL SUB-CONTRACTORS SHALL VISIT THE BUILDING SITE & VERIFY ALL PERTINENT CONDITIONS PRIOR TO SUBMISSION OF BID. ANY ERRORS OR OMISSIONS IN THE DRAWINGS AND/OR SPECIFICATIONS ARE TO BE REPORTED TO "START TO FINISH DRAFTING" FOR CORRECTION.

2,189 S.F

2,534 S.F.

DRAWINGS ARE NOT TO BE SCALED FOR EXACT MEASUREMENTS. WRITTEN DIMENSIONS GOVERN. CONTRACTOR SHALL VERIFY ALL DIMENSIONS. IN THE EVENT OF CONFLICT, THE DESIGNER SHALL BE NOTIFIED PRIOR TO PROCEEDING WITH ANY WORK. VERIFY ALL DIMENSIONS ON SITE PRIOR TO ORDERING MATERIALS, COMPONENTS, FIXTURES AND FITTINGS.

CONTRACTOR IS RESPONSIBLE FOR THE PROPER EXECUTION OF ALL WORK, INCLUDING THE APPROVAL OF ALL SHOP DRAWINGS.

ALL EXTERIOR WINDOWS & SLIDING DOORS SHALL BE TESTED AND LABELED AS CONFORMING TO AAMA/WDMA/CSA101/I.S.2/A440 OR TAS202, EXTERIOR SIDE-HINGED DOORS SHALL BE TESTED & LABELED AS CONFORMING TO AAMA/WDMA/CSA101/I.S.2/A440 OR COMPLY WITH FBC SECTION 1709.5.2. EXTERIOR WINDOWS & DOORS SHALL BE LABELED IDENTIFYING MANUFACTURER, PERFORMANCE CHARACTERISTICS AND APPROVED PRODUCT

TESTING ENTITY, SEE FBC 1709.5.1 FOR SPECIFIC LABELING REQUIREMENTS. EACH DOOR & WINDOW SHALL BE WIND LOAD RESISTANT TO MEET THE LIMITS OF THE DESIGN LOADS SPECIFIED. NO SHRUBS OR SPRINKLER HEADS SHALL BE PLACED, NOR SHALL CONDENSATE LINES NOR

DOWNSPOUTS DISCHARGE WITHIN ONE FOOT OF THE STRUCTURE. . PROVIDE TEMPERED GLASS AS REQUIRED IN THESE LOCATIONS:

6.1. ALL SLIDING GLASS DOORS 6.2. ALL GLASS WITHIN 24" OF A DOOR OPENING 6.3. ALL GLASS LESS THAN 18" FROM FINISHED

6.4. ALL GLASS WITHIN 60" VERT. OF TUB/SHOWER FLOOR AND 36" HOR. FROM EXIT GARAGE DOOR TO RESIDENCE SHALL MEET FBC-R SECTION R302.5.1 & BE 20 MIN. FIRE-RATED

B. ANY DRYWALL BELOW B.F.E. MUST BE TYPE 'X' OR CEMENTITIOUS BOARD (I.E. DUROROCK) . ALL CEILING HEIGHTS NOTED ARE A.F.F (ABOVE FINISHED FLOOR)

10. TYPICAL "ALIGN" NOTE WHERE STUD FRAME WALLS MEET CMU WALLS: ALIGN EDGE OF STUD W/ EDGE OF FURRING STRIP SO FINISHED DRYWALL SURFACE IS CO-PLANAR.

. ALL PLUMBING, ELECTRICAL & MECHANICAL ROUGH-INS MUST BE COMPLETE, INSPECTED & APPROVED BEFORE REQUESTING THE FRAMING

INSPECTION. 2. MANDATORY AIR LEAKAGE TEST SHALL BE DONE PRIOR TO FINAL BUILDING INSPECTION PER FBC SECTION R402.4.

LEGEND

DENOTES DOOR THAT MEETS 32" CLEAR OPENING ADA REQ'T

O DRYER EXHAUST FAN

+ + WATER SUPPLY HOOKUPS FOR WASHER

T.O.W. TOP OF WALL (TYP.) - CAN ALSO MEAN 'TOP OF WINDOW' FOR ELEVATIONS

-M.C. = MIXED CONSTRUCTION -T.A.N. = TYPICAL ALIGN NOTE: ALIGN EDGE

OF STUD W/ EDGE OF FURRING STRIP SO FINISHED SURFACE IS CO-PLANAR


WO 1 TRANSOM ABOVE MAIN WINDOW

= EXISTING WALL TO REMAIN = NEW 4" STUD WALL

= NEW 6' STUD WALL = NEW 8' STUD WALL = NEW CMU WALL

MINOTE: ALL WALLS ARE DESIGNED AS SHEARWALLS

- (1) *5 REBAR AT CORNERS, INTERSECTIONS, EACH SIDE OF OPENINGS & AT 6'-0' O.C. MAX, TYP. PROVIDE #5 BELOW SILL FOR OPENINGS GREATER THAN 6'-0" W. ▲ (2) *5 REBAR OR (1) *7 FOR OPENINGS 16'-0' OR
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- (1) *5 REBAR RETROFIT (FOR RENOVATION) 5/8'X6' LONG TITEN HD W/ 3'X3'XI/8' WASHER ⊕ 18' O.C. ON BOTTOM PLATE, 6-12" FROM ENDS OF WALLS

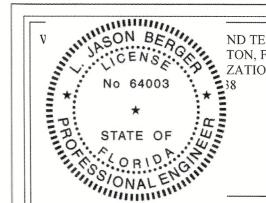


ND TESTING, INC TON, FL 34211 ZATION # 9298

06-20-22

Residence A CUSTOM HOME: Wilson-bling
590 Companion
Tangboat Key, Change BUILDING DEPT. REVISIONS EXISTING GRADE REVISIONS


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MADIC		OD/		OPE	VING	PRESS	SURES	DELLADICO
MARK	STYLE		WIDTH	HEIGHT/	+	-	REMARKS	
D07	(2) 30	080	HINGED	6'-0"	8'-0"	41.0	44.0	<^ \ \
D08	(4) 30	080	S.G.D.	12'-0"	8'-0"	38.0	42.0)
D09	(2) 26	680	HINGED	5'-0"	8'-0"	41.0	44.0	EGRESS
D10	26	086	POCKET	2'-6"	8'-0"	\	/	
D11	20	080	HINGED	2'-0"	8'-0"			
D12	26	380	POCKET	2'-6"	8'-0"			
D13	20	080	HINGED	2'-0"	8'-0"			,,,,,,,,,,,,,,,,,,,,,,,,,,,,,,,,,,,,,,,
D14	24	480	HINGED	2'-4"	8'-0"			
D16	28	380	HINGED	2'-8"	8'-0"			
D17	30	080	HINGED	3'-0"	8'-0"			
D18	28	380	HINGED	2'-8"	8'-0"			
D19	28	380	BI-FOLD	2'-8"	8'-0"			
D20	28	380	HINGED	2'-8"	8'-0"			
D21	28	380	HINGED	2'-8"	8'-0"			
D22	26	680	POCKET	2'-6"	8'-0"			
D23	26	680	HINGED	2'-6"	8'-0"			
D24	26	680	HINGED	2'-6"	8'-0"			
D25	26	680	HINGED	2'-6"	8'-0"			

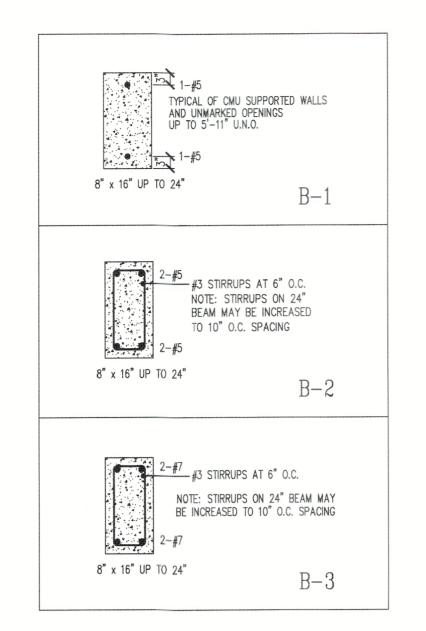
		WI	NDOW	SCHED	ULE	Ξ		
	RK STYLE		OPENING WIDTH HEIGHT		PRESSURES		REMARKS	
MARK					+ -			
WO1	SH	24	3'-1"	4'-2 3/4"	44.0	48.0)	
W02	SH	25	3'-1"	5'-3"	44.0	48.0		
W03	SH	25	3'-1"	5'-3"	44.0	48.0	<	
W04	SH	23	3'-1"	3'-2 1/2'(44.0	48.0	Z ~	
W05	(2) SH	25	6'-2"	5'-3"	44.0	48.0	1-	
W06	SH	24	3'-1"	4'-2 3/4"	44.0	48.0	<u> </u>	
W07	SH	25	3'-1"	5'-3"			<	
W08	SH	33	4'-5 1/4"	3'-2 1/2"/	43.0	57.0)	
W09	SH	H35	2'-2 1/2"	5'-3"	44.0	60.0)	
W10	SH	H35	2'-2 1/2"	5'-3"	44.0	48.0	K	
W11	SH	H35	2'-2 1/2"	5'-3" (44.0	48.0)	
W12	SH	H35	2'-2 1/2"	5'-3"	44.0	48.0)	
W13	SH	24	3'-1"	4'-2 3/4"	44.0	48.0		
W14	FG	6614	6'-6"	1'-4"	44.0	48.0	TRANSOM	
W15	FG	5114	5'-1"	1'-4"	44.0	60.0	TRANSOM	
1111	1	F 1 1 1	F- 2 A 22	A ? A ??	4.0	10/0	TOALICOLI	

PRIVATE PLAN REVIEW WEINTRAUB INSPECTIONS & FORENSIC, INC REVIEWED FOR CODE COMPLIANCE D Gellette 3777 11/29/2022



M.C. = MIXED CONSTRUCTION.

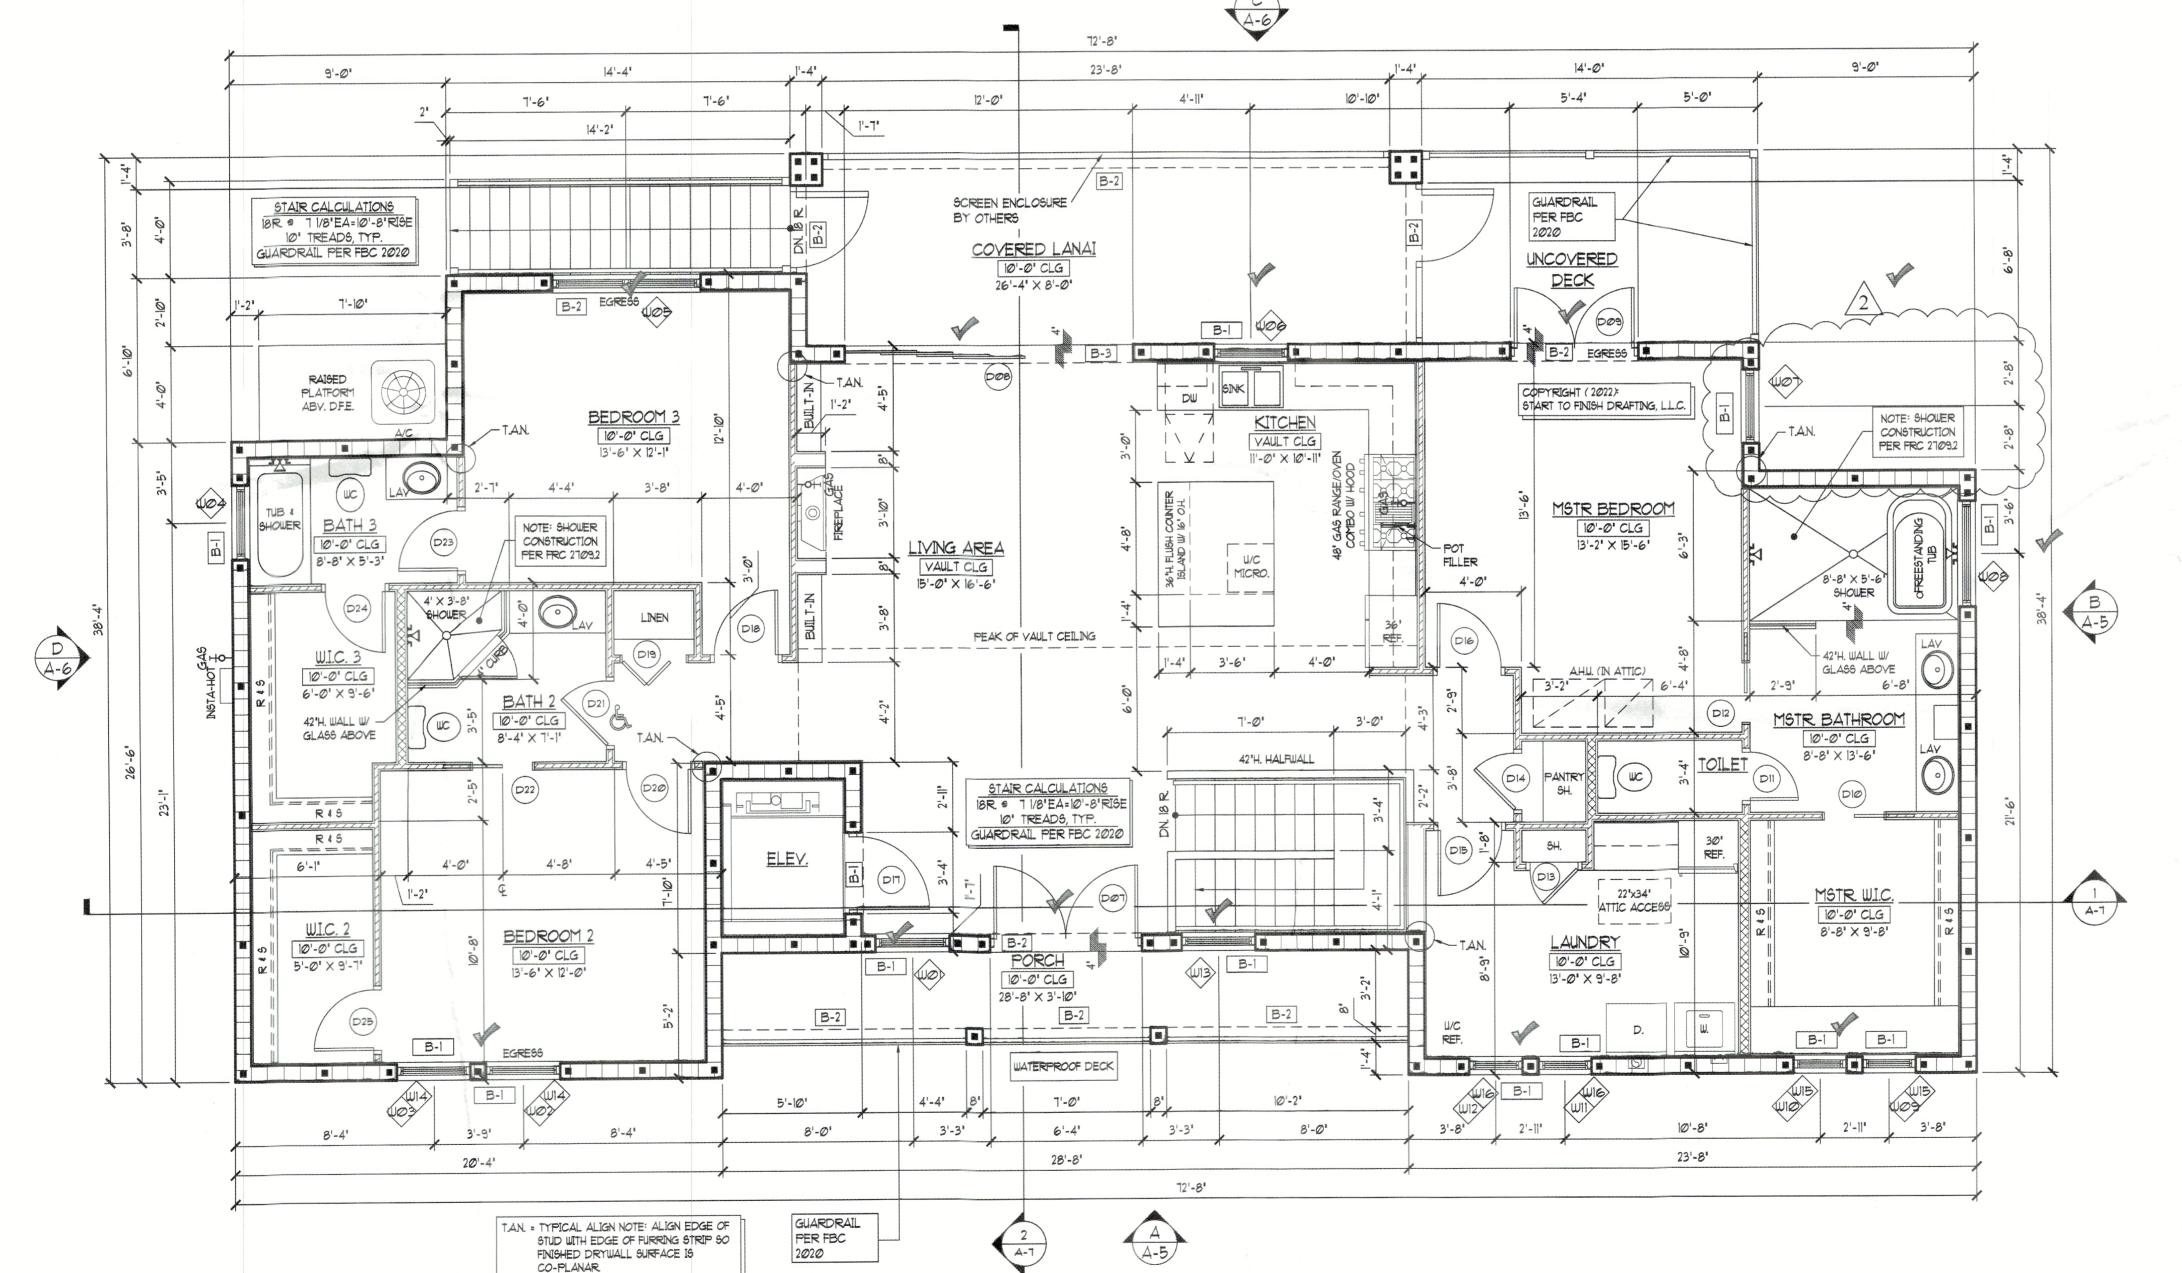

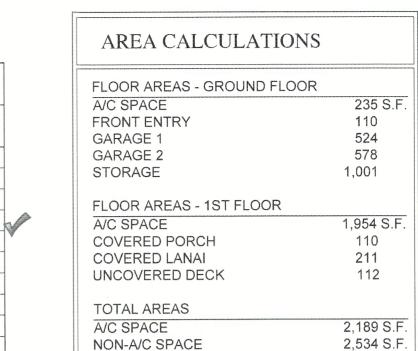

GENERAL NOTES:

GENERAL CONTRACTOR AND ALL

TOTAL UNDER ROOF

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2. MANDATORY AIR LEAKAGE TEST SHALL BE DONE

WALLS MEET CMU WALLS: ALIGN EDGE OF STUD W/

PRIOR TO FINAL BUILDING INSPECTION PER FBC SECTION R402.4.

LEGEND

DENOTES DOOR THAT MEETS 32" CLEAR OPENING ADA REQ'T

O DRYER EXHAUST FAN

+ + WATER SUPPLY HOOKUPS FOR WASHER

HOSE BIBB TOOL & GAS BIBB

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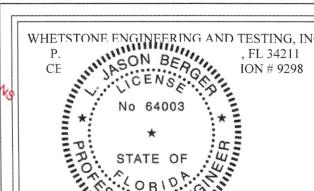


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O.C. ON BOTTOM PLATE, 6-12" FROM ENDS OF WALLS

SHEET

WHETSTONE ENGINEERING AND TESTING, INC

enc Resid Bringle


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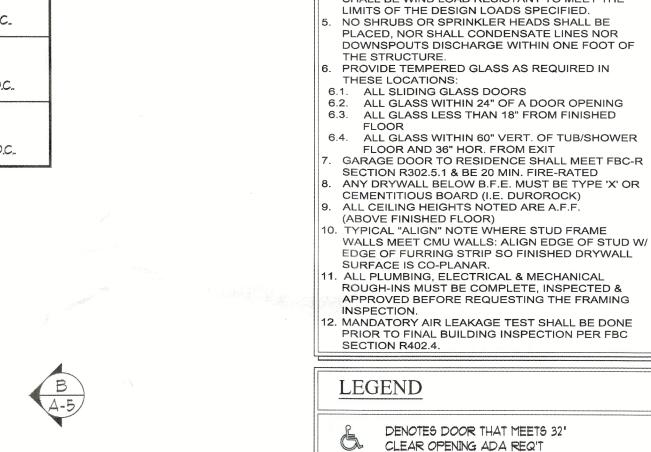
90 Companion Longboat Key, Wilson-

JMK


Change
BUILDING DEPT. REVISIONS
EXISTING GRADE REVISIONS 06-20-2


Date: Job #:




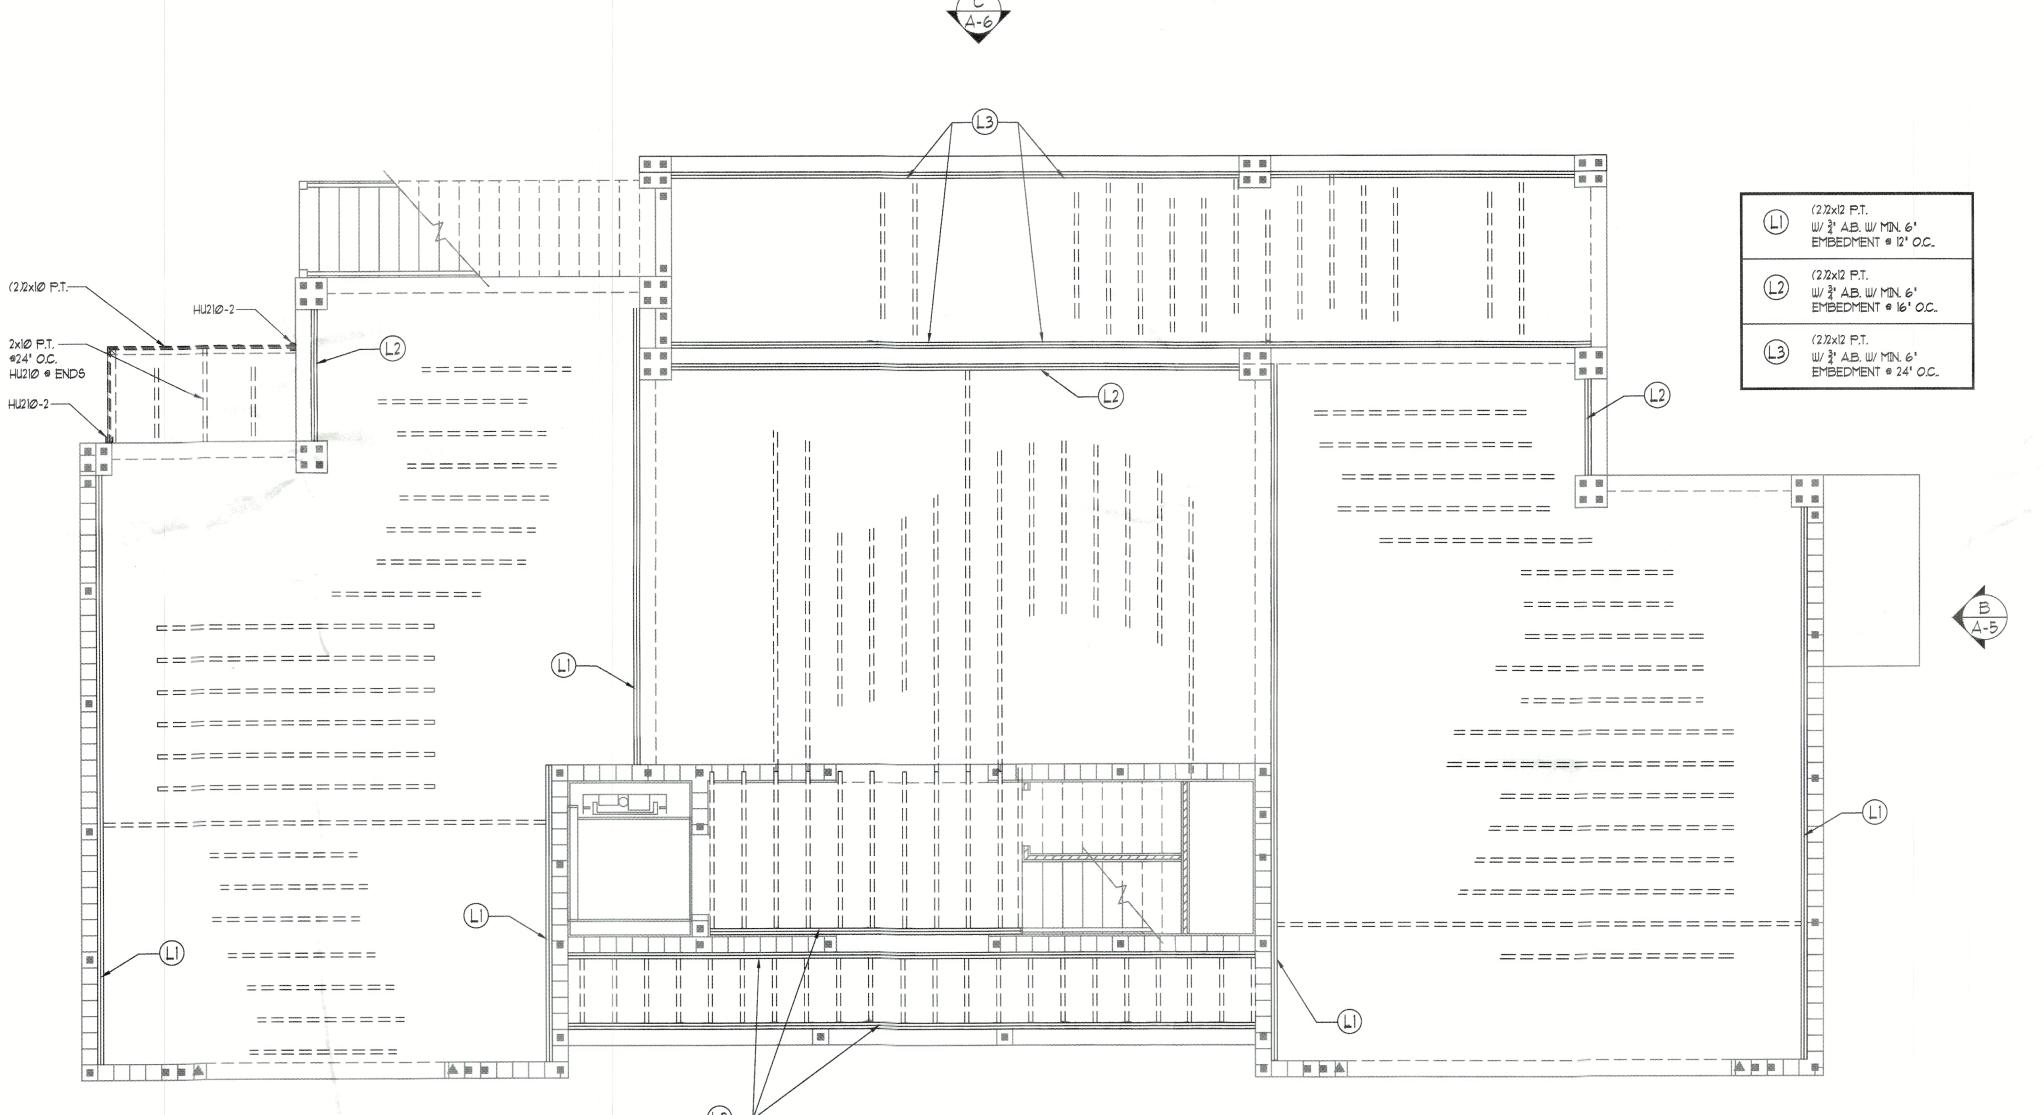


(ALSO SEE TRUSS LAYOUT DRAWINGS FOR DETAILS & SPECIFICATIONS)

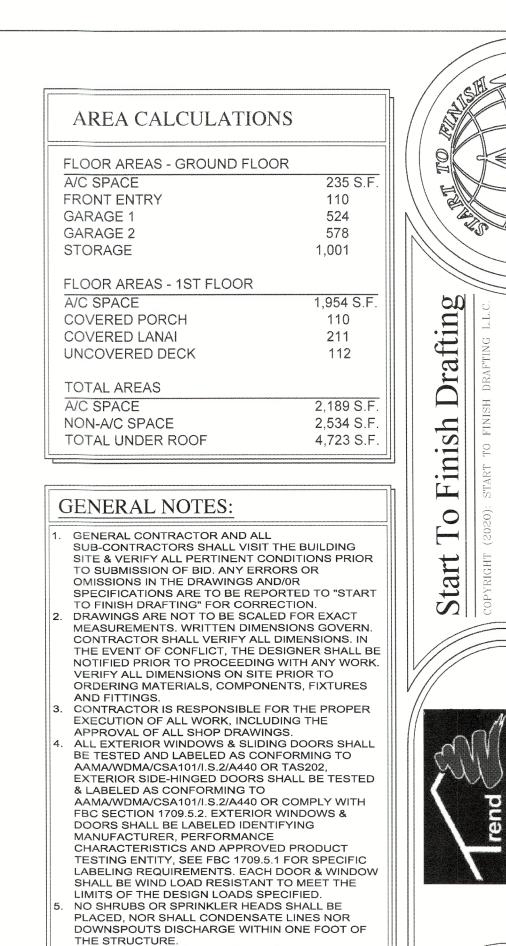

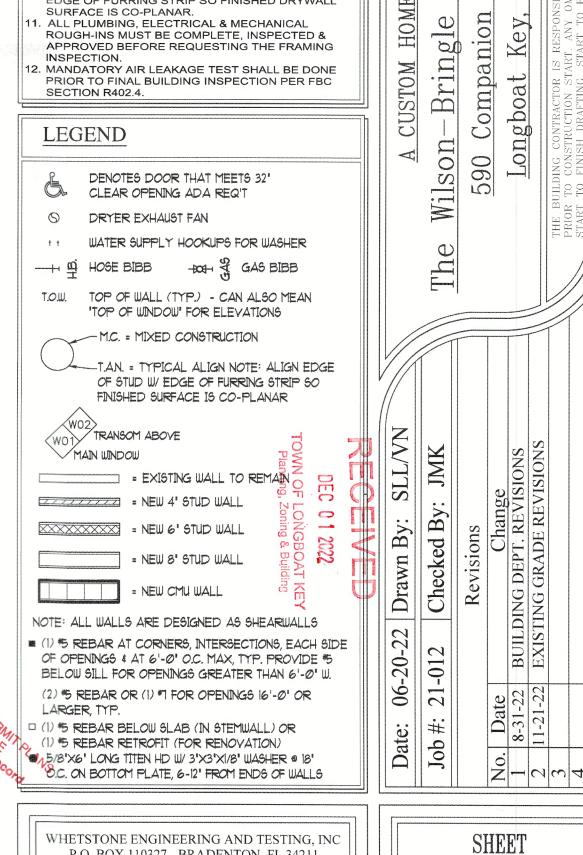


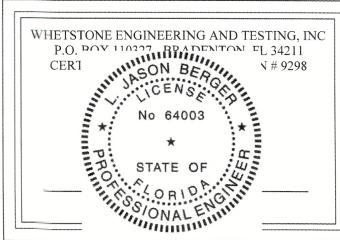


DENOTES DOOR THAT MEETS 32"

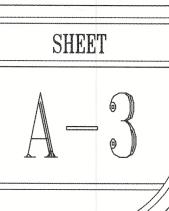


Residence

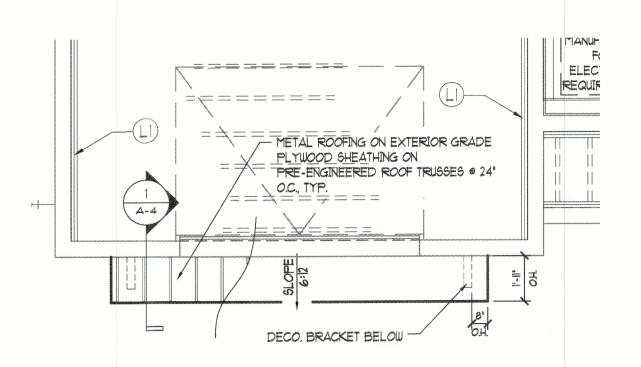



SHED ROOF PLAN
SCALE:

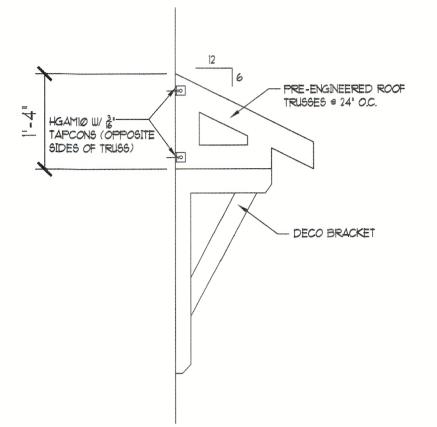

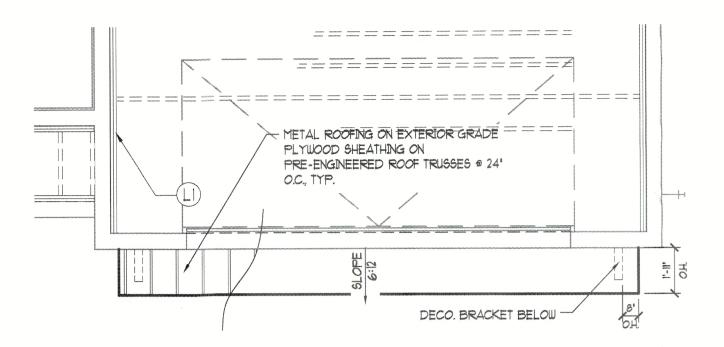



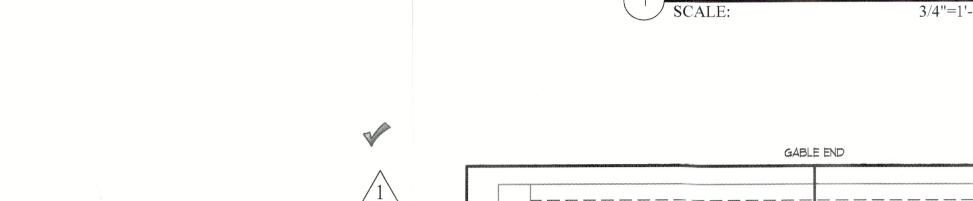

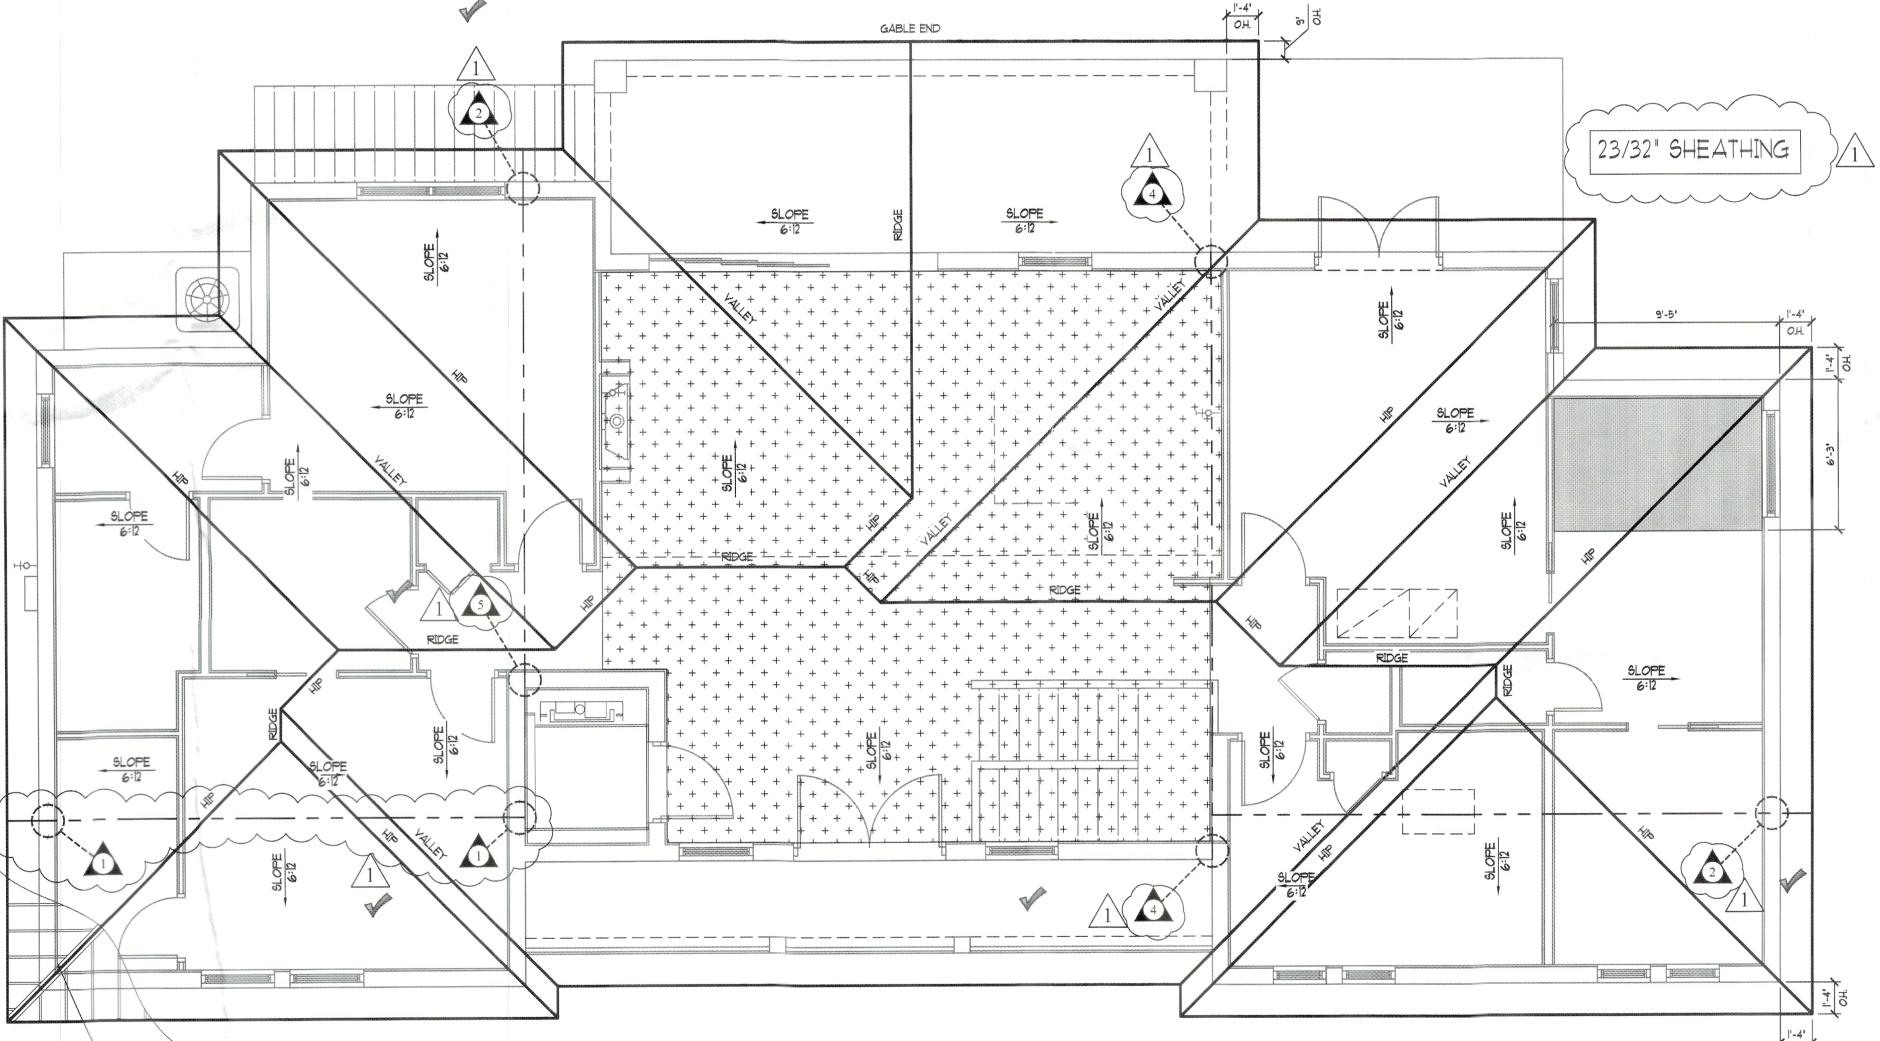

— METAL ROOFING ON EXTERIOR GRADE PLYWOOD SHEATHING ON PRE-ENGINEERED ROOF TRUSSES @ 24"

O.C., TYP.

TYPICAL ROOFING NOTE: METAL ROOF INSTALLED PER MANUFACTURER'S SPECIFICATIONS (SEE ATTACHED NOA) ON EXTERIOR-GRADE PLYWOOD ROOF SHEATHING (SEE 5-2 ROOF SHEATHING ATTACHMENT)

SPRAY FOAM INSULATION SHALL BE APPLIED AT UNDERSIDE OF ROOF DECK & AT INTERIOR FACE OF SHEATHING FOR OVERHANGS AND FASCIA, (TYP.) SEE SECTIONS FOR EXAMPLES. ATTIC ACCESS HATCHES DO NOT PENETRATE THE BUILDING INSULATED ENVELOPE AND ARE NOT WEATHERSTRIPPED OR INSULATED.



OVERHANGS: 1'-4" O.H. (TYP.) / 9" GABLE O.H. (TYP.) PLUMB CUT FASCIA / 6:12 PITCH SEALED ATTIC - NO ROOF VENTILATION @ CONDITIONED SPACE G.C. TO COORD. SOFFIT VENTILATION @ UNCONDTIONED SPACE

CONNECTOR SCHEDULE

THE FOLLOWING CONNECTORS ARE PRESCRIPTIVE AND SHALL NOT BE DEVIATED FROM UNLESS SPECIFICALLY SHOWN AND NOTED OTHERWISE ON PERMITTED PLANS. ALL STRAPS SHALL BE INSTALLED PER THEIR RESPECTIVE CURRENT PRODUCT SPECIFICATIONS WITHOUT EXCEPTION.

(1) HETA 20 (TYP.) U.N.O.

(2) HETA 20

(2) HETA 20 & (1) HTSM16

(2) HETA 20 & (1) LGT2/3*

(2) HETA 20 & (1) MGT* (12" EMBED)

(2) HETA 20 & (1) HTT5** / (1) FGTR

(2) HETA 20 & (2) FGTR

H10A + (3) 10d TOE NAILS (TYPICAL @ FRAME U.N.O.)

H10A (TYP. @ JACK TRUSS)

H14 + (3) 10d TOE NAILS

MGT TO INVERTED MGT

LGT2 / LGT3 (DEPENDING ON TRUSS PLY) (FRAME) *

* = ADD 2x6 SYP. SCAB 24" LONG AS NEEDED. ATTACH W/ 10d NAILS @ 3" O.C. STAGGERED. ** = HTT5 OPTION IS ONLY APPLICABLE TO FORM & POUR BEAMS.

BLOCKING NOTE #1: 2x4 BLOCKING @ 24" O.C. W/ (3) 10d END NAILS. ATTACH BLOCKING TO UNSUPPORTED CMU WALLS W/ SIMPSON HETA20.

BLOCKING NOTE #2: 2x4 BLOCKING @ 24" O.C. W/ (3) 10D END NAILS. ATTACH BLOCKING TO TOP PLATE W/ DTC CLIPS @ 24" O.C.

- TRUSS MANUFACTURER'S LAYOUT / LOAD SHEETS SHALL DETERMINE THE UPLIFT
- ALL EPOXY SHALL BE SIMPSON SET-XP.
 MIN. 12" EMBEDMENT @ FOOTING U.N.O. & MIN. 12" EMBEDMENT @ TIE BEAM U.N.O.
- 3" EDGE, 4" END DISTANCE U.N.O. ALL OTHER CONNECTIONS WILL BE
- SPECIFICALLY CALLED OUT ON PLANS. NO STRAP MAY CONTAIN LESS THAN FIVE
- ONLY GALVANIZED OR STAINLESS STEEL
- CONNECTORS & FASTENERS ON TREATED LUMBER, PER MFG. SPECS.
- NO NAILED FASTENERS INTO NARROW
- FACE (PARALLEL TO GLUE LINE) OF WOOD STRUCTURAL COLUMNS. • NO MECHANICAL ANCHORS (I.E.
- REDHEADS, WEDGE-ALLS, TITEN HD'S) INTO PREFABRICATED METAL HOLDDOWNS.
- ONLY USE "WET-SET" HOOKED ANCHOR BOLTS OR DRILL & EPOXY.

ROOF SHEATHING REQUIREMENTS LOCATED ON SHEET 5-2

G.C. SHALL COORDINATE WITH TRUSS MANUF'R TO ENSURE A/C CHASES ARE CONTINUOUS THROUGH TRUSSES (INCLUDING GIRDERS) & MEET MINIMUM SIZES SO A/C DUCTWORK CAN GET TO ALL AREAS OF THE RESIDENCE AS REQUIRED


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> WEINTRAUB INSPECTIONS & FORENSIG, INC.
> REVIEWED FOR CODE COMPLIANCE D callette 3777 11/29/2022



DEC 0 1 2022 TOWN OF LONGBOAT KEY Planning, Zoning & Building

CEILING	LEGEND
(NO HATCH)	10'-0' AFF. CLG. HT.
+ + + + + + + + + + + + + + + + + + + +	VAULTED CLG.
	4" RECESS IN FLOOR TRUSSES

	Manning.	
WHE'	"SON BED"	TESTING, INC
P. CF ATT	SON BERGE	[, FL 34211
CF		ION # 9298
*:	* No 64003	=
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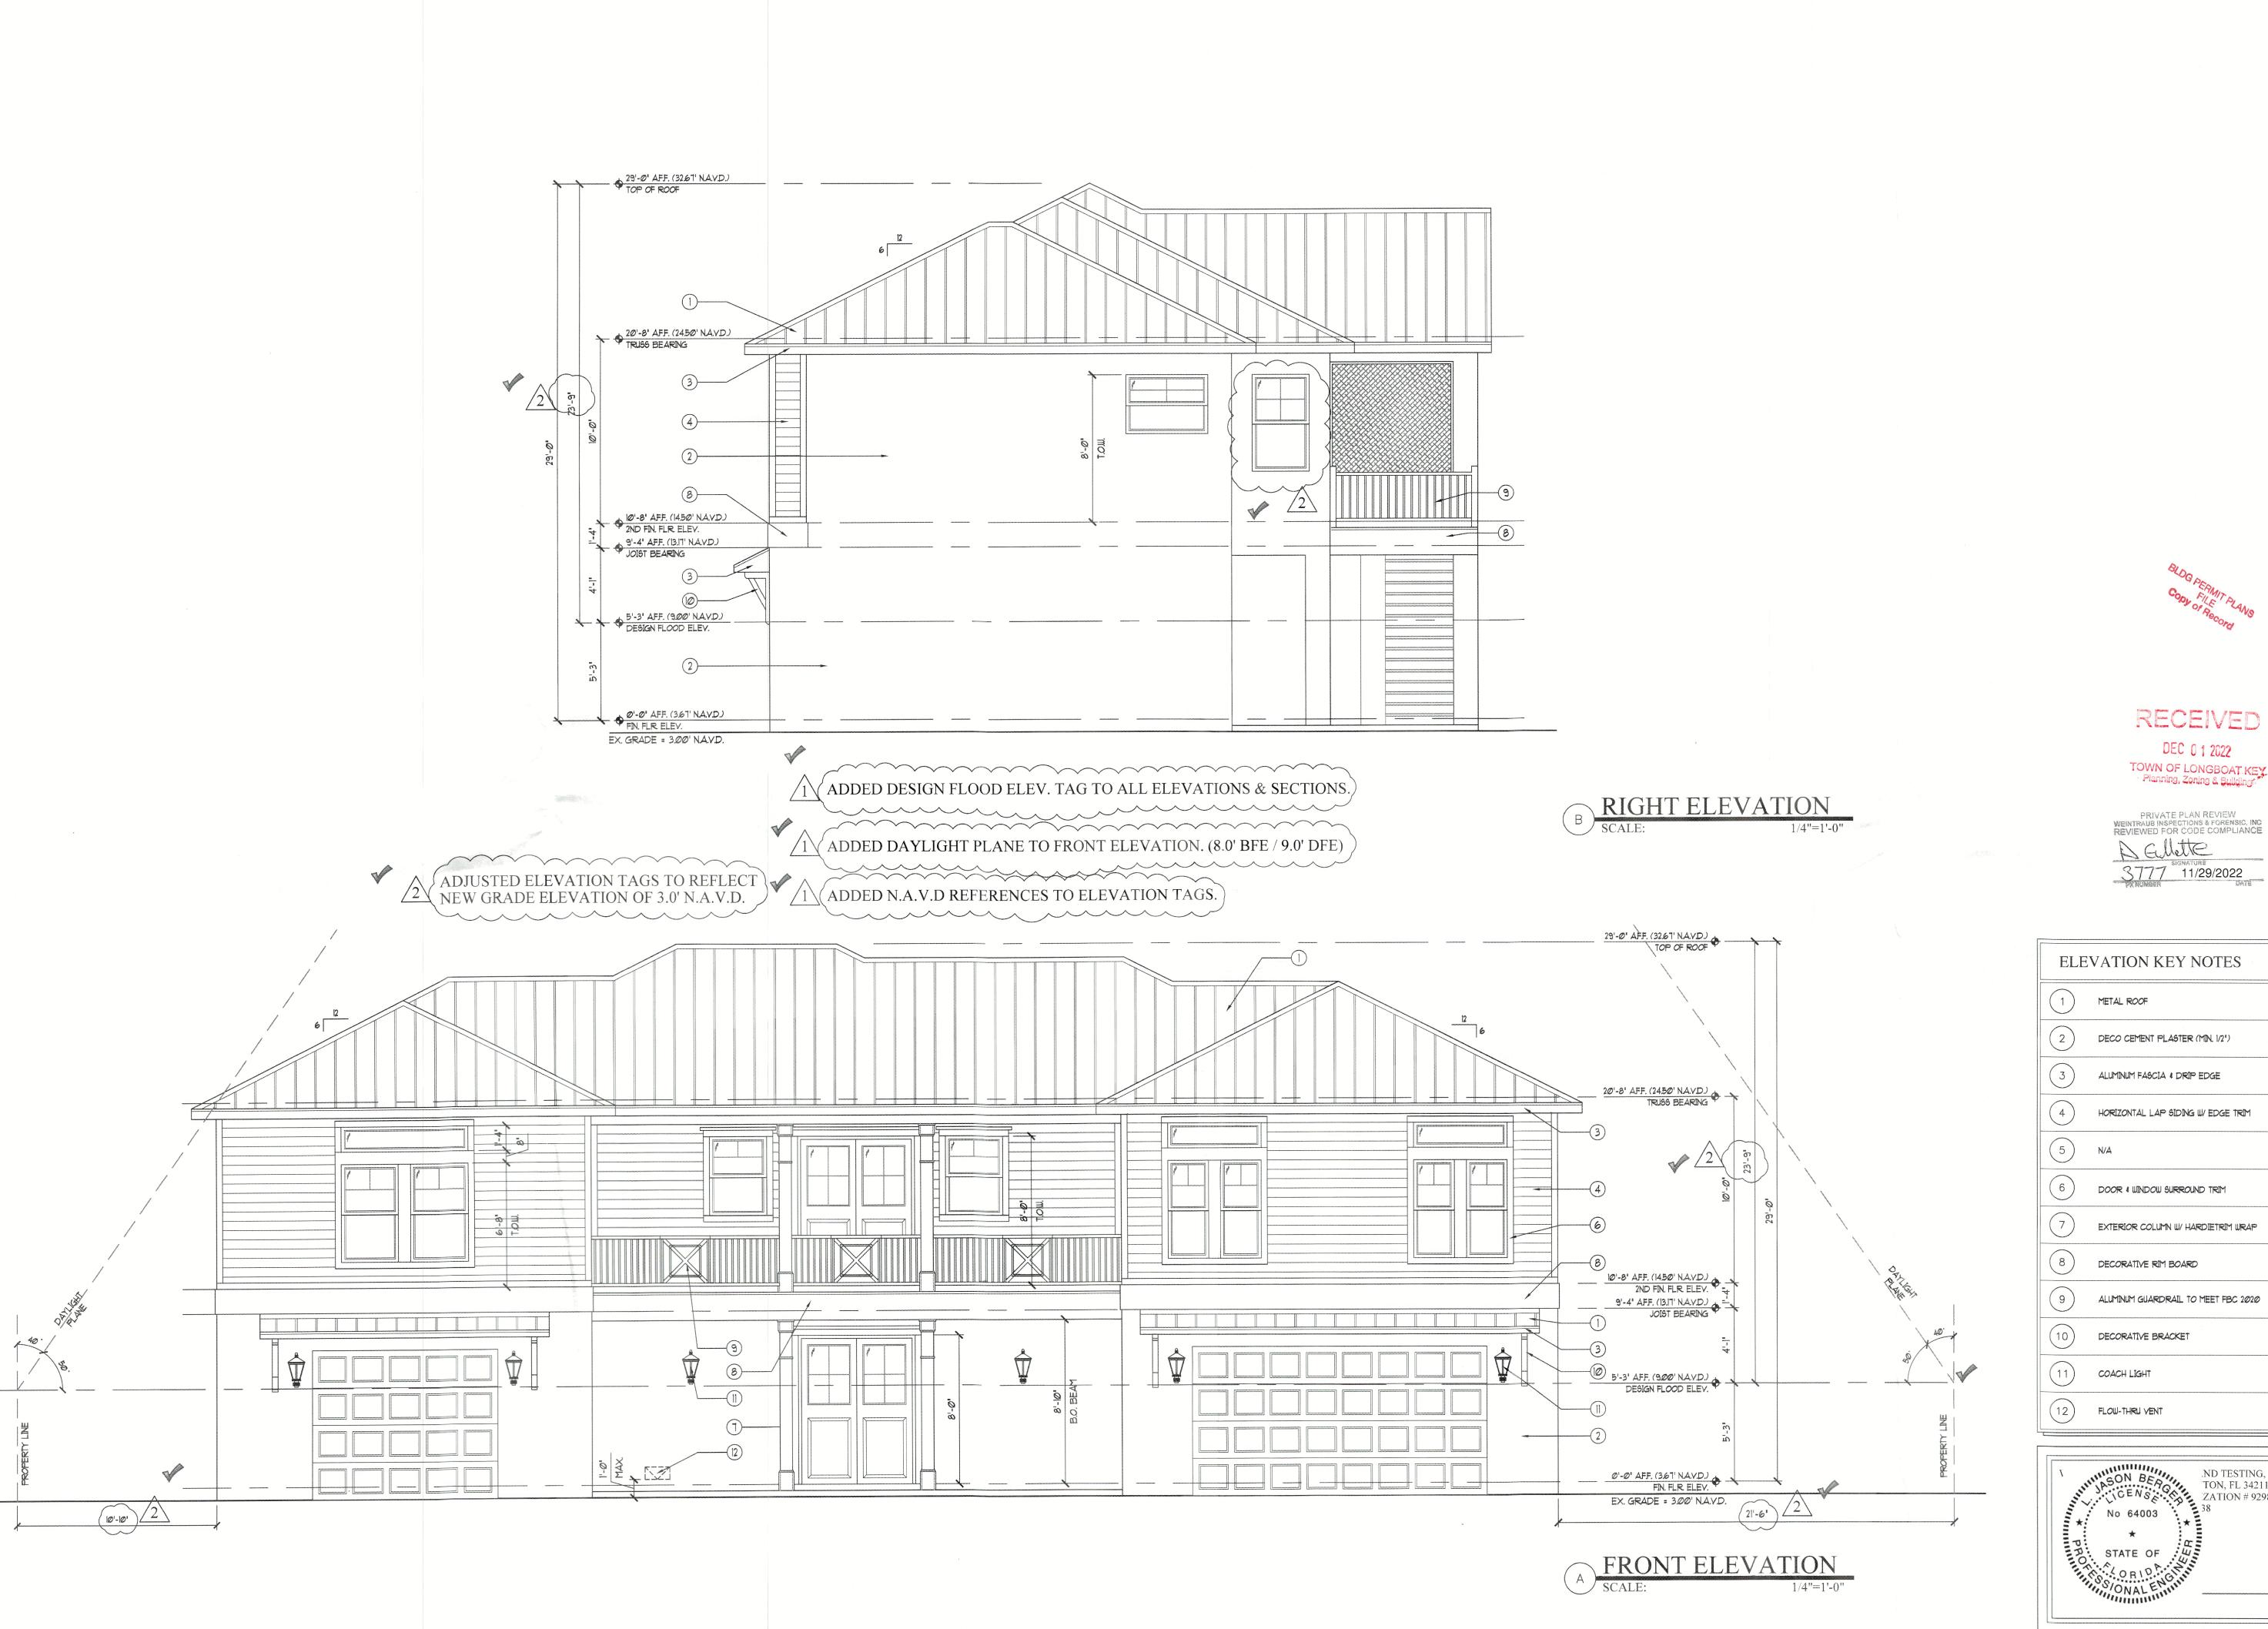


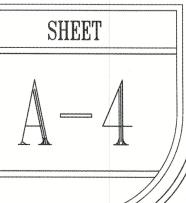Finish

A CUSTOM HOME:
Wilson-Bringle R
590 Companion W
Longboat Key, F

c Change 22 BUILDING DEPT. REVISIONS 22 EXISTING GRADE REVISIONS

5-20-22 06-





Drafting

To Finish

Start

Residence Way

A CUSTOM HOME:
Wilson—Bringle F
590 Companion V
Longboat Key, F

The

 06-20-22
 Drawn By: SLL/VN


 21-012
 Checked By: JMK

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Planning, Zoning & Buildings.


PRIVATE PLAN REVIEW
WEINTRAUB INSPECTIONS & FORENSIC, INC
REVIEWED FOR CODE COMPLIANCE
SIGNATURE
3777 11/29/2022
PXNUMBER DATE

ELEVATION KEY NOTES METAL ROOF DECO CEMENT PLASTER (MIN. 1/2") ALUMINUM FASCIA & DRIP EDGE HORIZONTAL LAP SIDING W/ EDGE TRIM DOOR 4 WINDOW SURROUND TRIM EXTERIOR COLUMN W/ HARDIETRIM WRAP DECORATIVE RIM BOARD

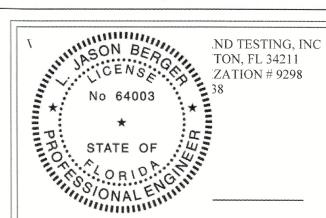


SHEET

No.DateChange18-31-22BUILDING DEPT. REVISIONS211-21-22EXISTING GRADE REVISIONS34

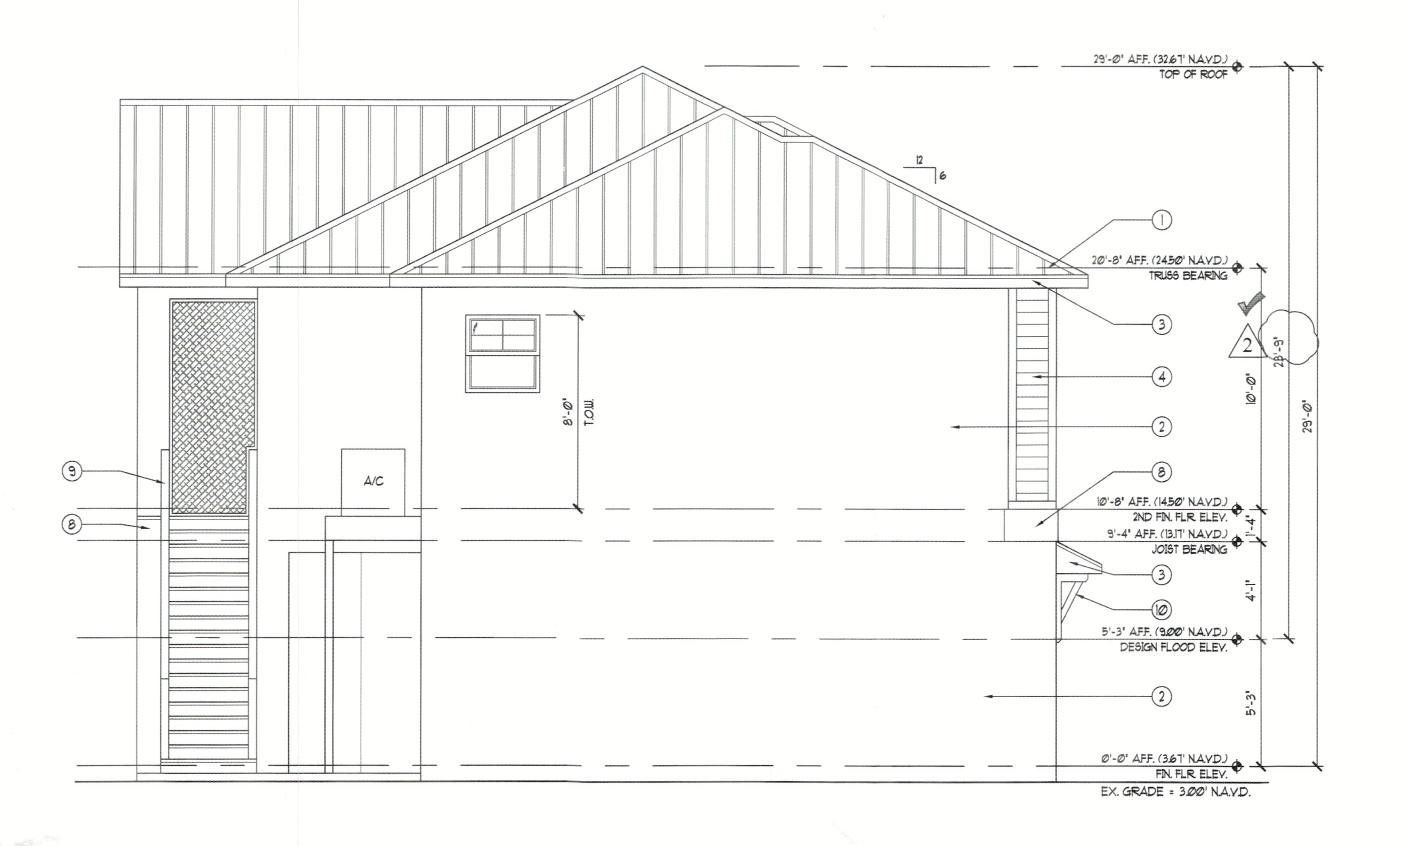

ADJUSTED ELEVATION TAGS TO REFLECT NEW GRADE ELEVATION OF 3.0' N.A.V.D.


1 ADDED N.A.V.D REFERENCES TO ELEVATION TAGS.

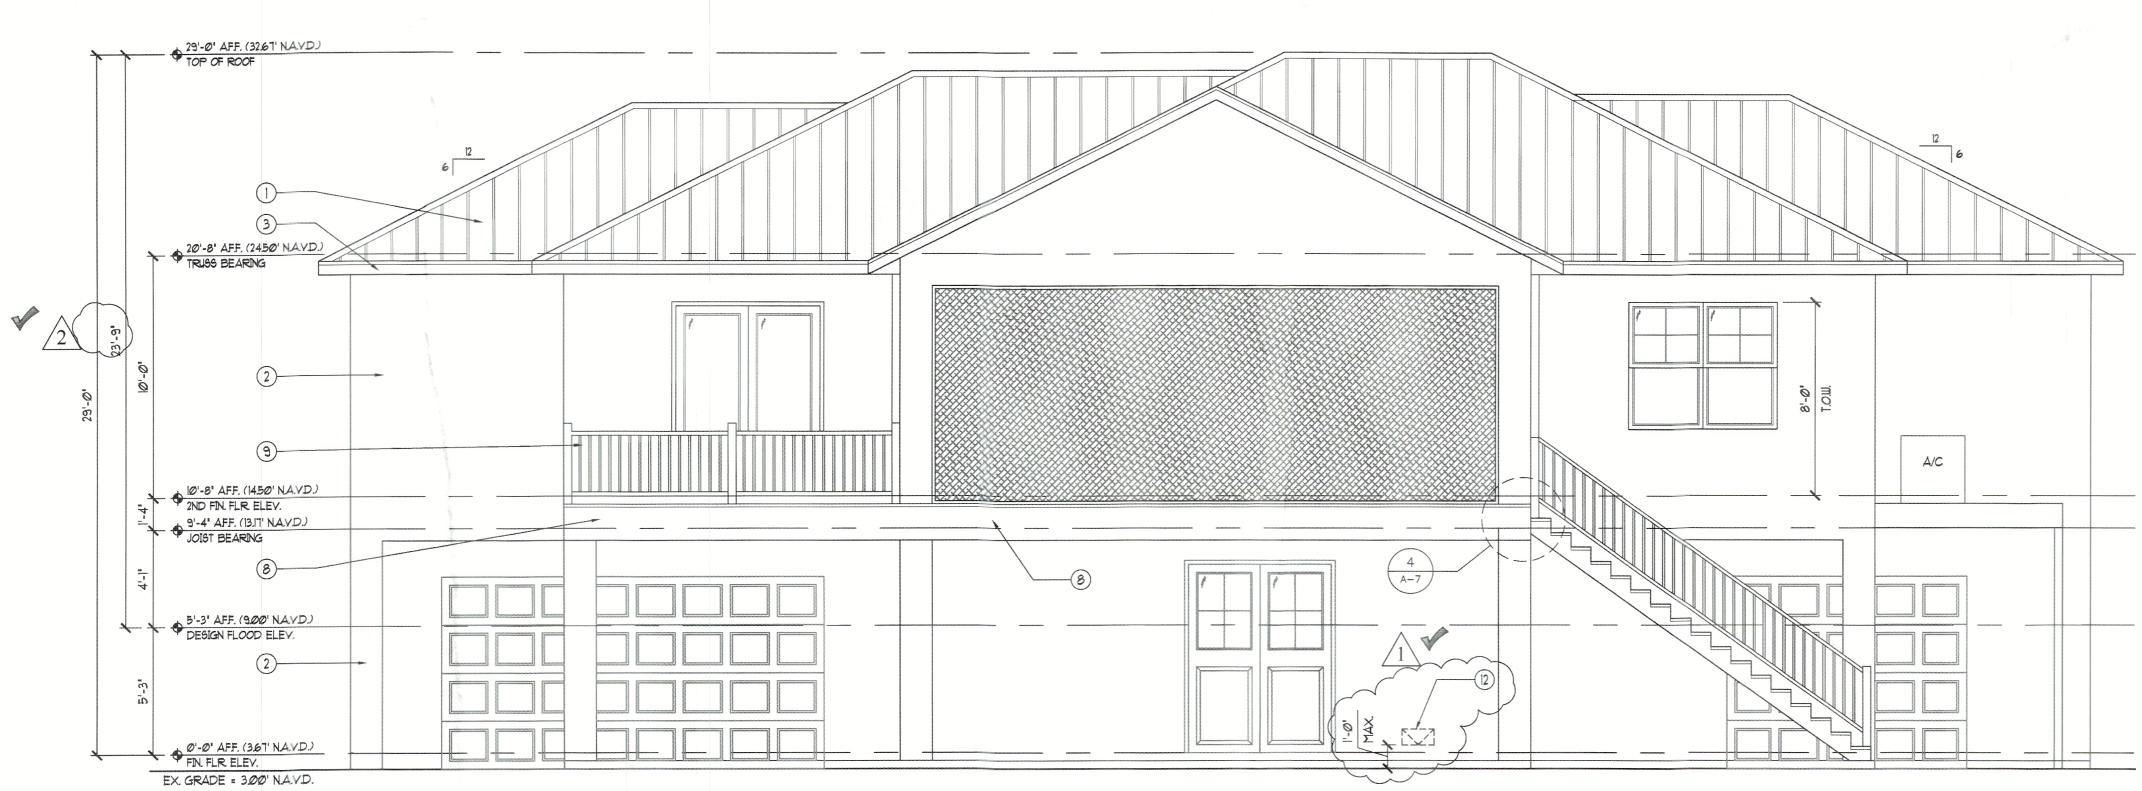

C REAR ELEVATION
SCALE: 1/4"=1'-0"

) LEFT ELEVATION
SCALE: 1/4"=1

PRIVATE PLAN REVIEW
WEINTRAUB INSPECTIONS & FORENSIC, INC
REVIEWED FOR CODE COMPLIANCE Schlitte 3777 11/29/2022 PRIMABER DATE

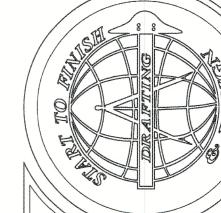

Drafting

To Finish Start

Residence Way FL

A CUSTOM HOME:
Wilson-Bringle R
590 Companion W
Longboat Key, FI

: 06-20-22 Drawn By: SLL/VN

E: 21-012 Checked By: JMK

Revisions

No.DateChange18-31-22BUILDING DEPT. REVISIONS211-21-22EXISTING GRADE REVISIONS34 Date: Job #:

SHEET

OTESTING, INC ON, FL 34211 . TION # 9298 No 64003 STATE OF

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TOWN OF LONGBOAT KEY Planning, Zoning & Building

ELEVATION KEY NOTES

DECO CEMENT PLASTER (MIN. 1/2")

ALUMINUM FASCIA & DRIP EDGE

DOOR & WINDOW SURROUND TRIM

DECORATIVE RIM BOARD

DECORATIVE BRACKET

COACH LIGHT

FLOW-THRU VENT


EXTERIOR COLUMN W/ HARDIETRIM WRAP

ALUMINUM GUARDRAIL TO MEET FBC 2020

HORIZONTAL LAP SIDING W/ EDGE TRIM

METAL ROOF

N/A

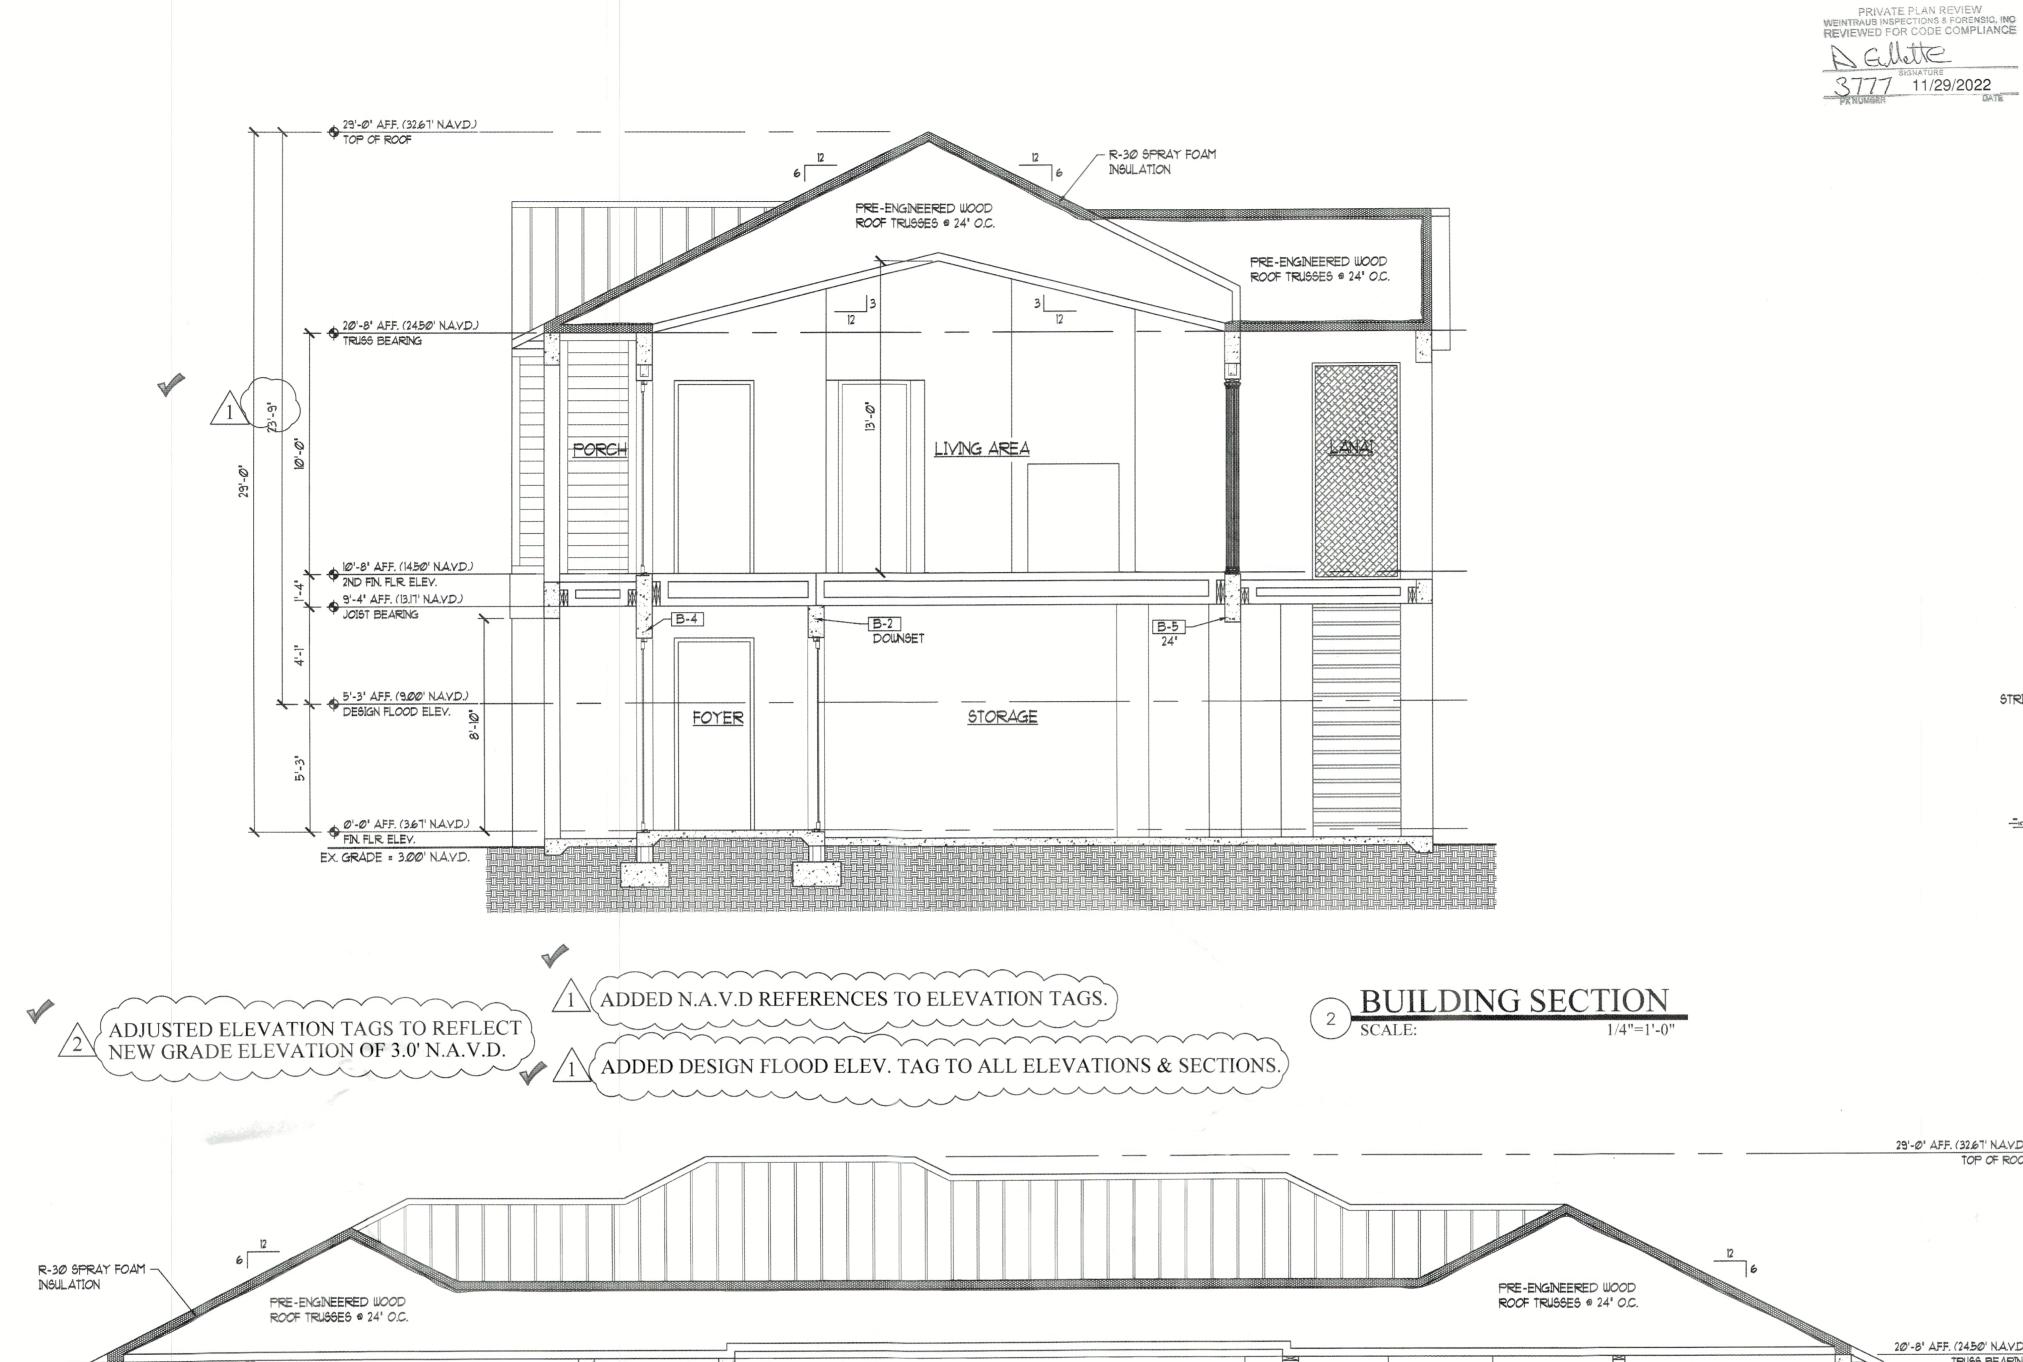


A CULTUM
STRINGTURE
3777 11/29/2022
PRINDER

ON 12' PRE-ENGINEERED
FLOOR TRUSSES


2xi2 STAIR
STRINGER (TYP)

NOSE TO
NOSE

4 STAIR DETAIL
SCALE: 3/4"=1'-0"

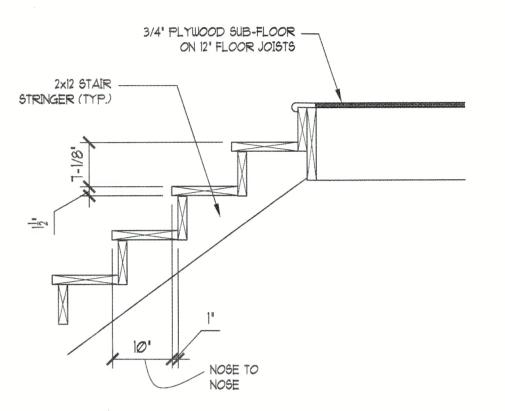


STAIR DETAIL

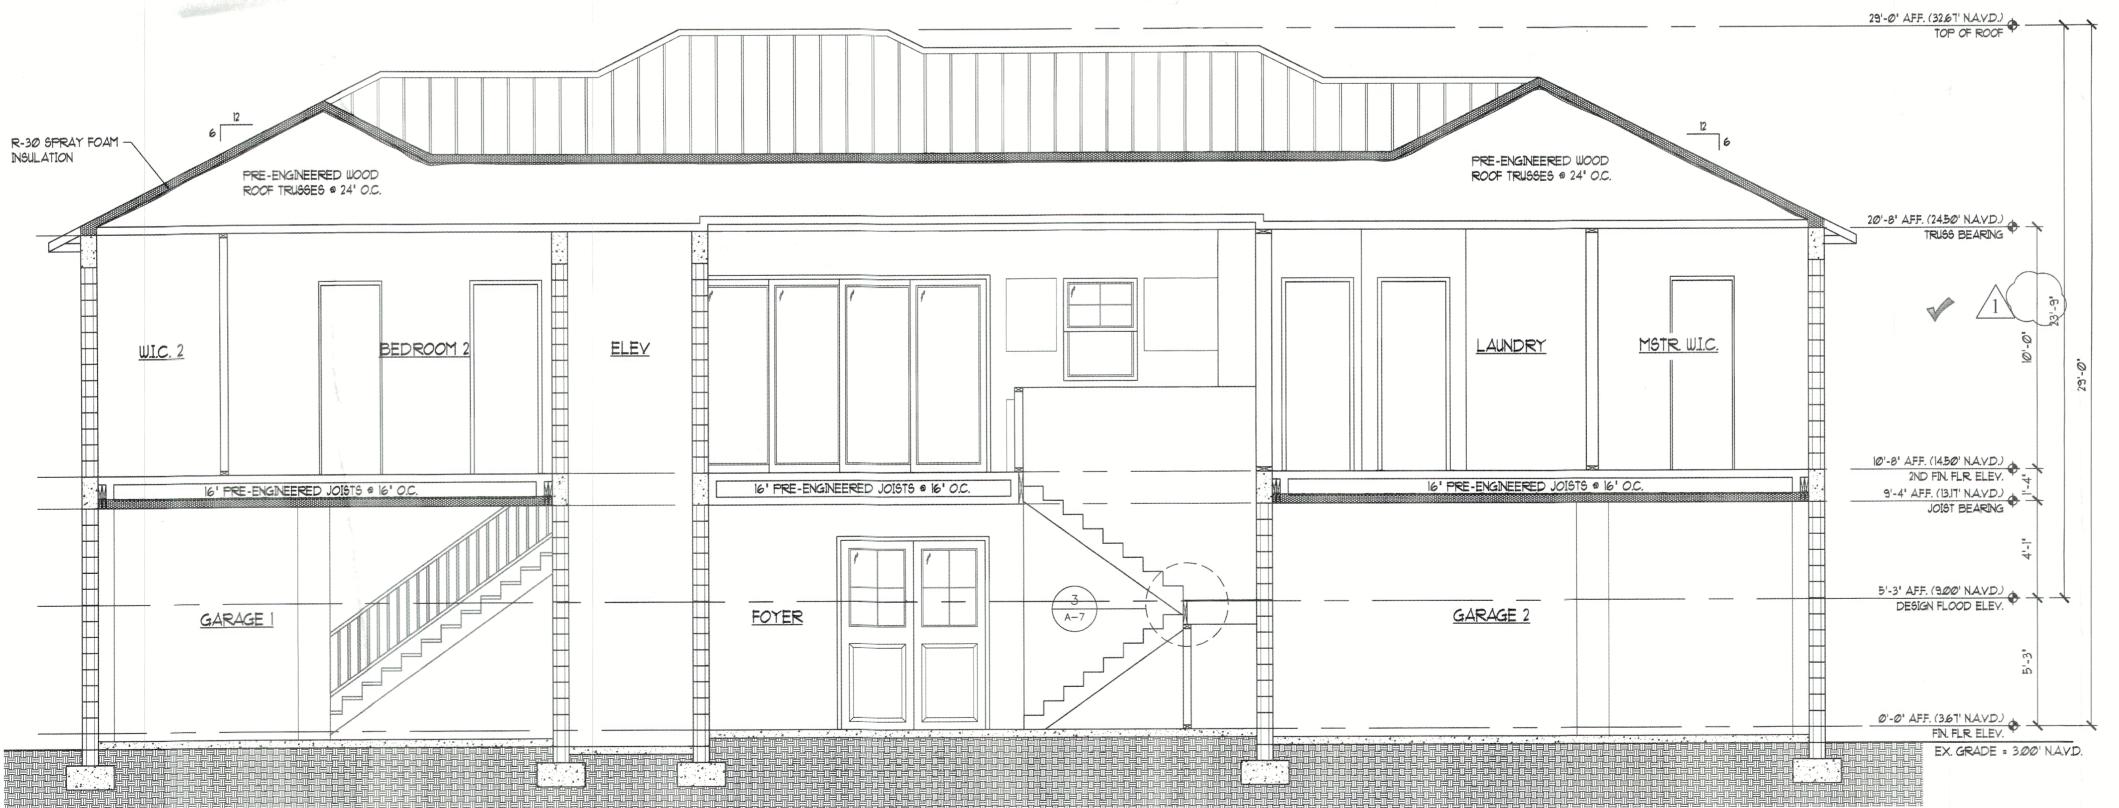


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TOWN OF LONGBOAT KEY
Planning, Zoning & Building



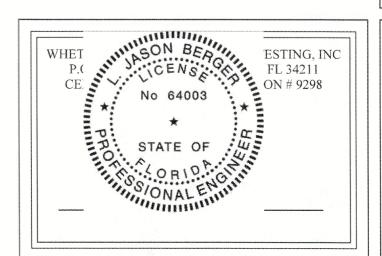

Drafting

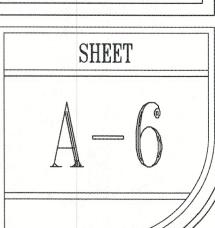Start To Finish

Residence Way FL

A CUSTOM HOME:
Wilson-Bringle F
590 Companion M
Longboat Key, F


The

06-20-22

1) BUILDING SECTION SCALE: 1/4"=1'-0

These drawings, when signed and sealed, are an indication that Whetstone Engineering & Testing, Inc. has reviewed the structural components only of the structure for conformance with the Florida Residential Code 7th Edition (2020). No other certification, inclusive of architectural elements and dimensional accuracy, etc. is expressed or implied.

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ELECTRICAL PLAN - GROUND FLOOR
SCALE: 1/AII-11 AII

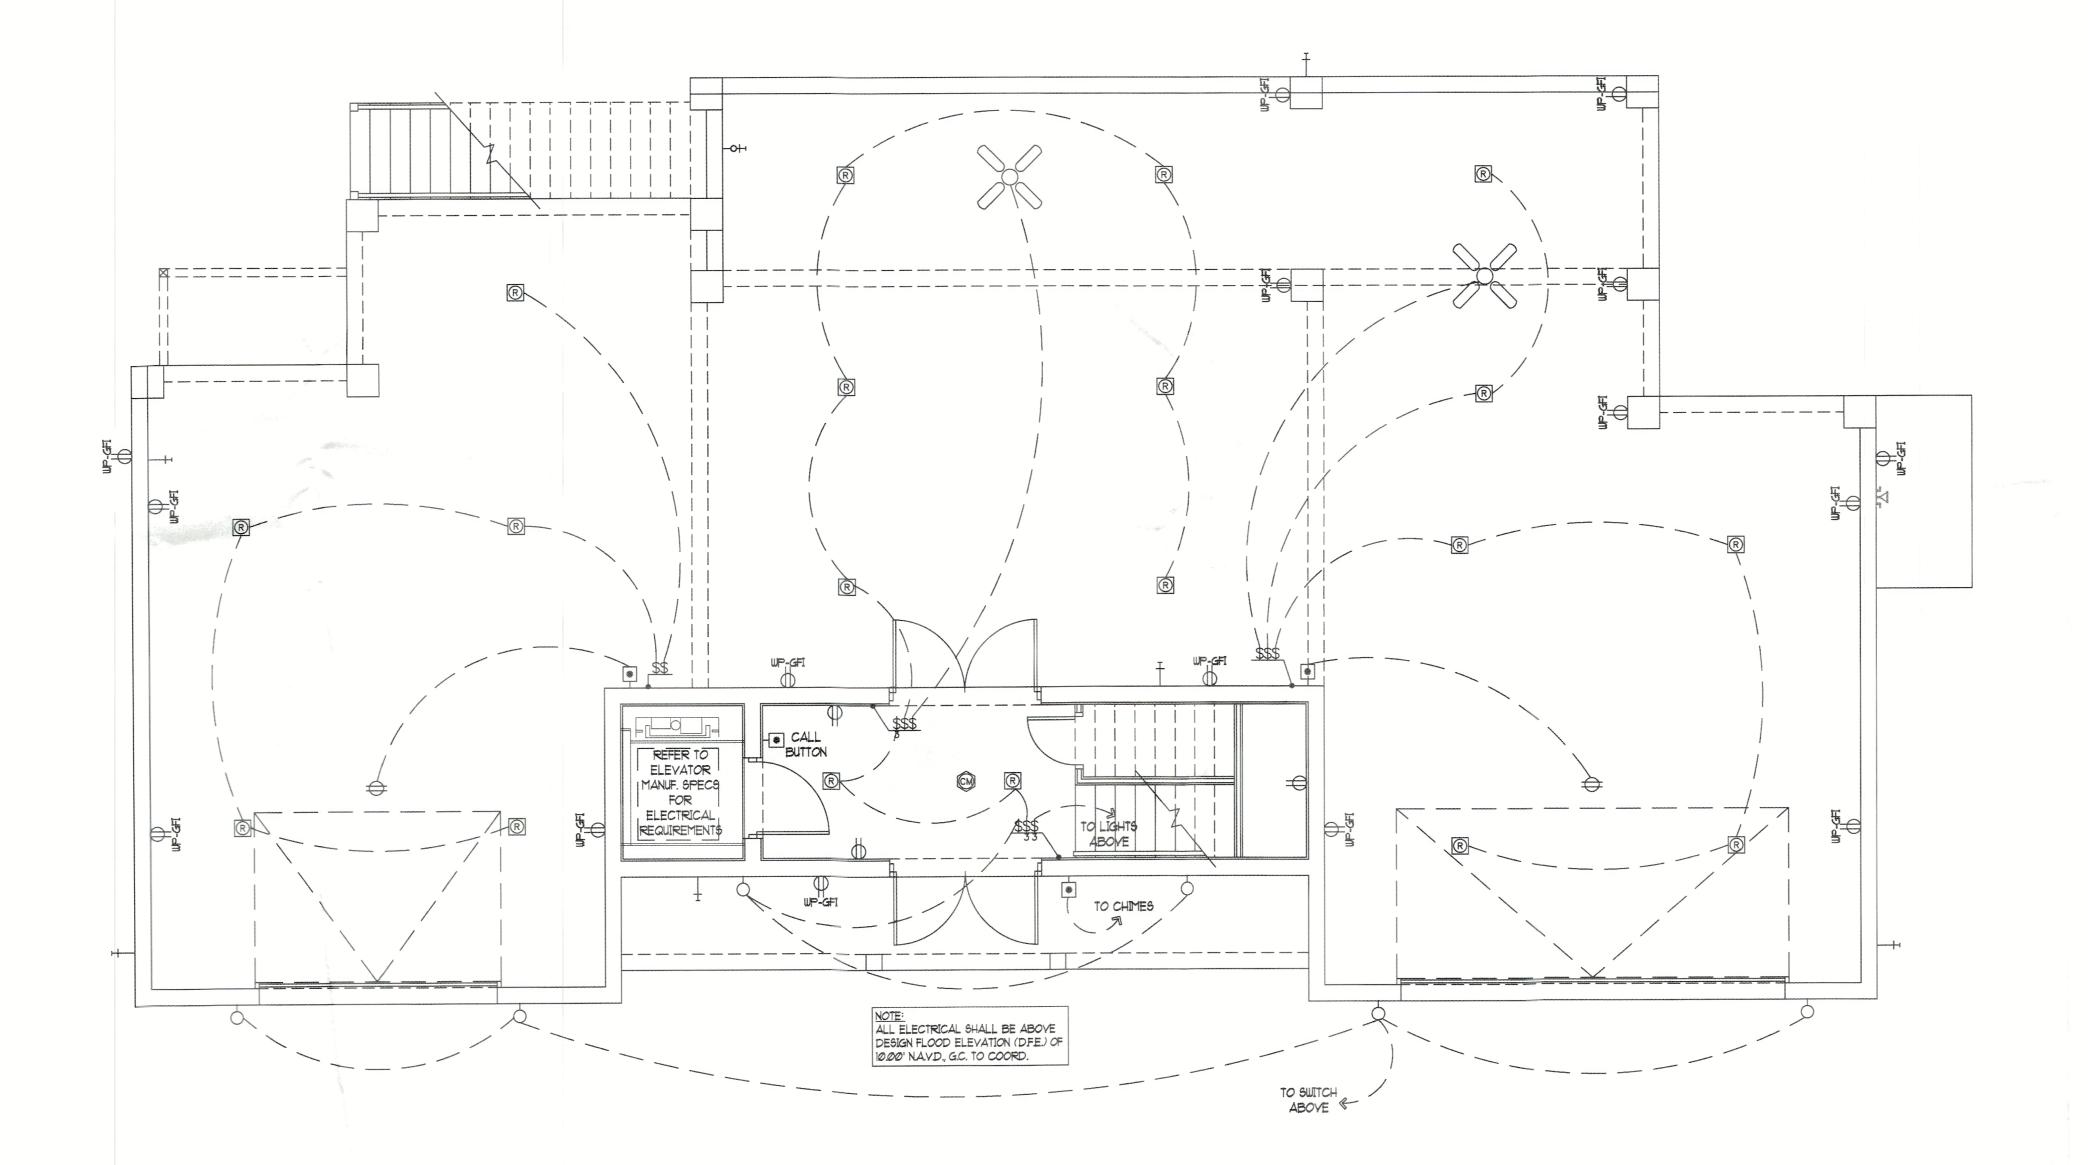

Drafting

To Finish

Residence Way FL

A CUSTOM HOME:
Wilson-Bringle F
590 Companion W
Longboat Key, F


BLDG PERMIT PLANS FILE Copy of Record

E	ELECTRICAL / MECH NOTES
1.	ALL WIRING AND GROUND SHALL BE COPPER.
2.	ALL ELECTRICAL, MECHANICAL AND H.V.A.C.
	SYSTEMS SHALL BE INSTALLED COMPLETE WITH
	ALL COMPONENTS.
3.	ALL SERVICE EQUIPMENT SHALL BE APPROVED BY
	THE POWER COMPANY.
4.	CONTRACTOR SHALL OBTAIN ALL INSPECTIONS
	REQUIRED.
5.	in the same of the
	AND ESCUTCHEONS FOR TELEPHONE OUTLETS.
	FIELD VERITY LOCATIONS WITH OWNER.
6.	The state of the s
	ACCORDANCE WITH LATEST EDITION OF NATIONAL
	ELECTRICAL CODE AS AMENDED & LOCAL
	ORDINANCES AND AUTHORITIES HAVING
	JURISDICTION.
7.	
	PHOTOELECTRIC TYPE, 120 VOLT HARD-WIRED W/ BATTERY BACKUP - SUPPLIED AND INSTALLED BY
	CONTRACTOR.
8.	ELECTRICAL, PLUMBING AND H.V.A.C.
0.	CONTRACTORS SHALL PROVIDE CATALOG. CUT
	SHEETS, ETC. FOR APPROVAL.
9	ALL ELECTRICAL OUTLETS TO BE A.F.I. PROTECTED.
	AT LEAST 75% OF ALL LIGHTING WILL BE
	HIGH-EFFICACY LAMPS PER 2017 FBC-EC CODE
	SECTION R404.1
144	ALL EXTERIOR LIGHT ENTREMENT OF BARRIES


					7	1
				SHI	EET	
9. 10. 11.	ELECTRICAL, PLUMBING AND H.V.A.C. CONTRACTORS SHALL PROVIDE CATALOG, CUT SHEETS, ETC. FOR APPROVAL. ALL ELECTRICAL OUTLETS TO BE A.F.I. PROTECTED. AT LEAST 75% OF ALL LIGHTING WILL BE HIGH-EFFICACY LAMPS PER 2017 FBC-EC CODE SECTION R404.1 ALL EXTERIOR LIGHT FIXTURES SHALL BE RATED FOR EXTERIOR USE. G.C. SHALL VERIFY SMOKE DETECTOR IN EACH HABITABLE ROOM & CARBON MONOXIDE DETECTOR WITHIN (10) TEN FEET. CM ALARMS PER FBC R315. ALL OUTLETS TO BE TAMPER PROOF PER NEC 2014.	Date: 06-20-22	Job #: 21-012	No Data	1 8-31-22 BUILI 2 11-21-22 EXIST	3

These drawings, when signed and sealed, are an indication that Whetstone Engineering & Testing, Inc. has reviewed the structural components only of the structure for conformance with the Florida Residential Code 7th Edition (2020). No other certification, inclusive of architectural elements and dimensional accuracy, etc. is expressed or implied.

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ELECTRICAL PLAN - SECOND FLOOR
SCALE: 1/48-11 08

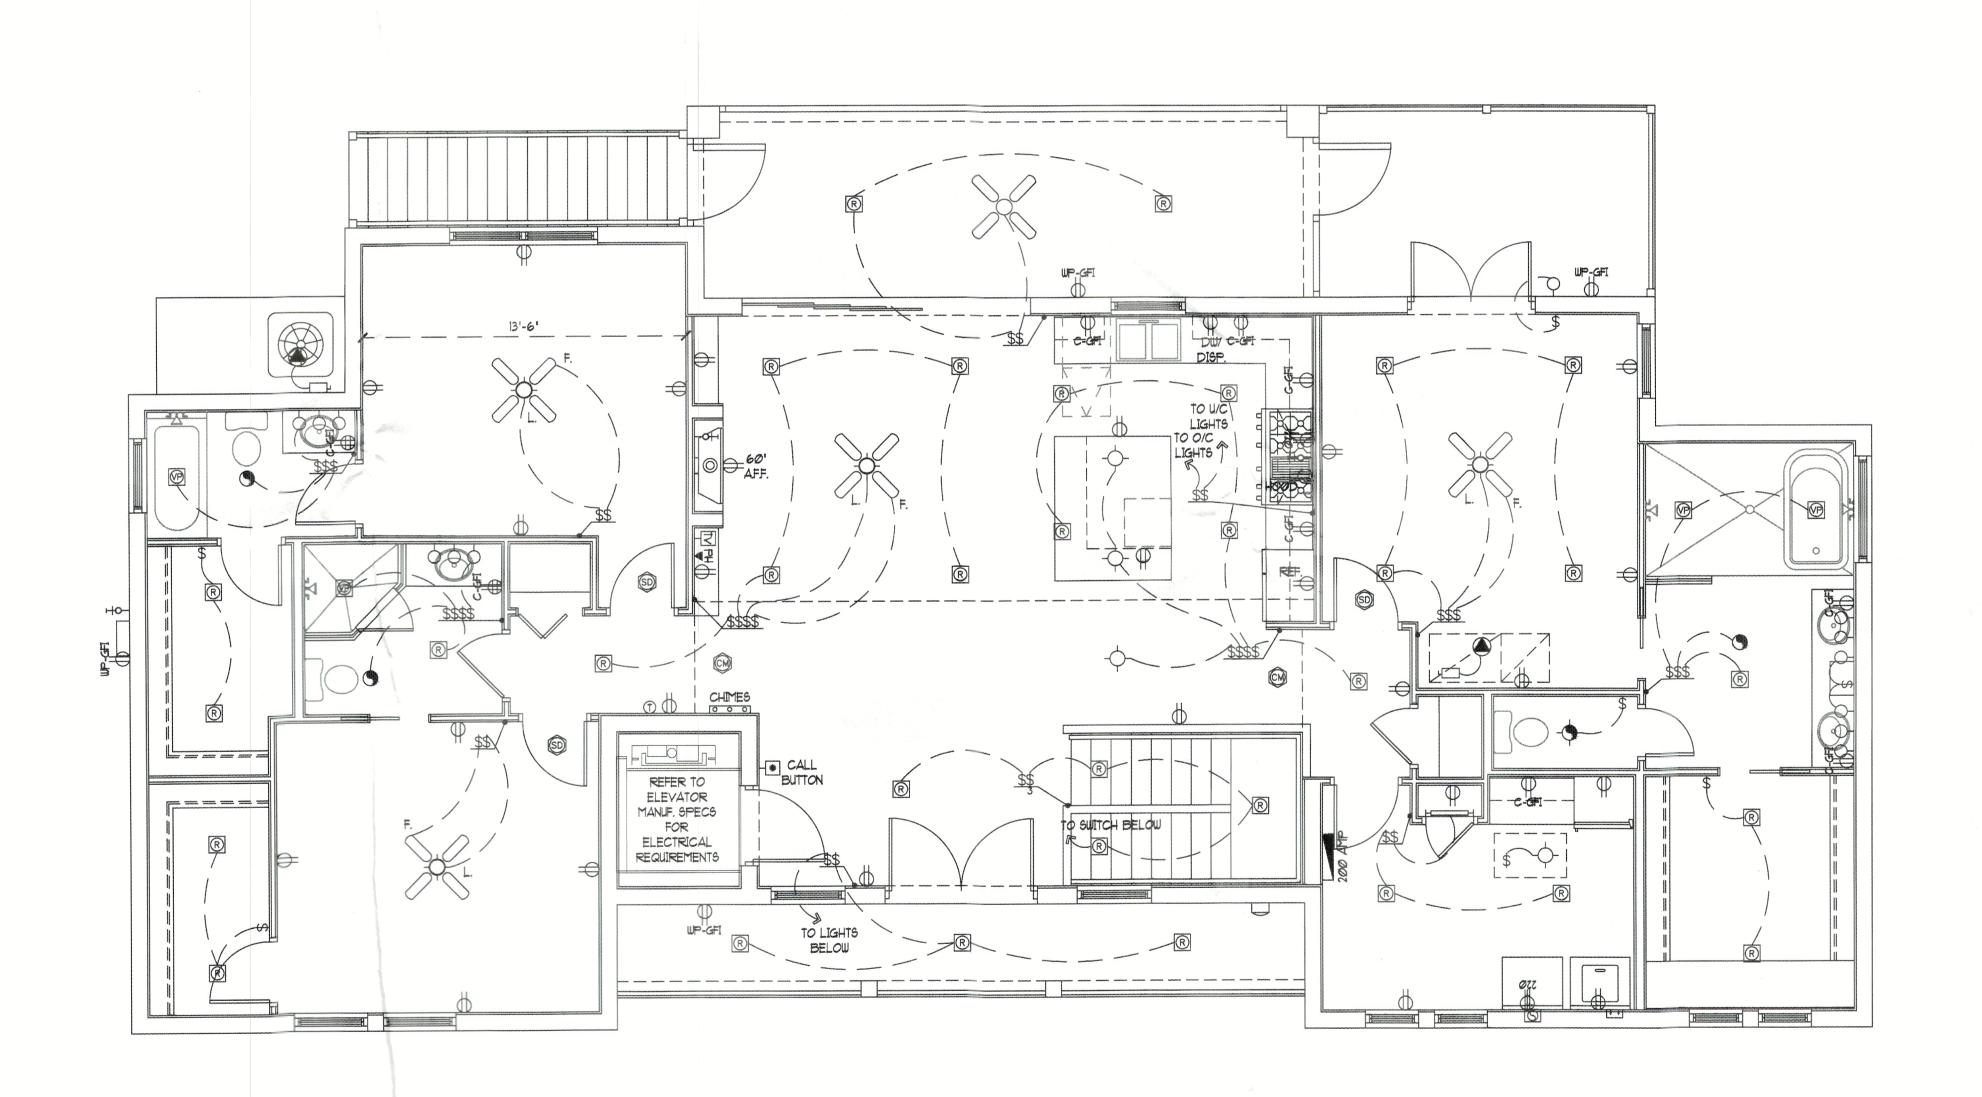

Drafting

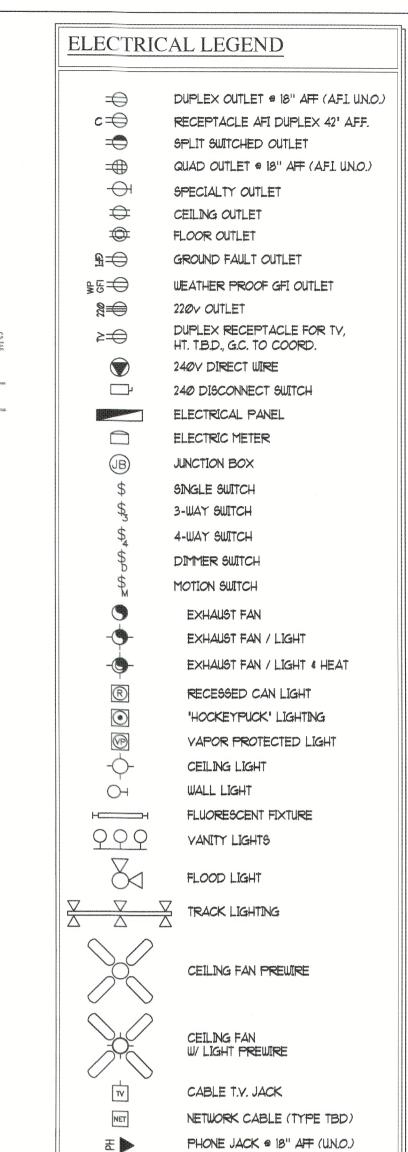Finish

NOTE: PHONE AND TV OUTLET LOCATIONS TO BE VERIFIED AND COORDINATED BY G.C.

0 0 0

GODY OF RECORD

THERMOSTAT 9 60" AFF

CARBON MON. 4 SMOKE DETECTOR

SPEAKER PREWIRE

SMOKE DETECTOR

	Hecord
L	ELECTRICAL / MECH NOTES
1.	ALL WIRING AND GROUND SHALL BE COPPER.
2.	ALL ELECTRICAL, MECHANICAL AND H.V.A.C.
	SYSTEMS SHALL BE INSTALLED COMPLETE WITH
	ALL COMPONENTS.
3.	ALL SERVICE EQUIPMENT SHALL BE APPROVED BY THE POWER COMPANY.
4	CONTRACTOR SHALL OBTAIN ALL INSPECTIONS
٠٠.	REQUIRED.
5.	PROVIDE APPROVED BOXES, PLATES, PULL WIRE
	AND ESCUTCHEONS FOR TELEPHONE OUTLETS.
	FIELD VERITY LOCATIONS WITH OWNER.
6.	ALL WORK AND MATERIAL SHALL BE IN
	ACCORDANCE WITH LATEST EDITION OF NATIONAL
	ELECTRICAL CODE AS AMENDED & LOCAL
	ORDINANCES AND AUTHORITIES HAVING JURISDICTION.
7.	SMOKE AND MONOXIDE DETECTORS SHALL BE
	CHICKE AND MONOVIDE DE LECTORS SHALL BE

PHOTOELECTRIC TYPE, 120 VOLT HARD-WIRED W/BATTERY BACKUP - SUPPLIED AND INSTALLED BY CONTRACTOR. 3. ELECTRICAL, PLUMBING AND H.V.A.C.
CONTRACTORS SHALL PROVIDE CATALOG, CUT SHEETS, ETC. FOR APPROVAL

ALL ELECTRICAL OUTLETS TO BE A.F.I. PROTECTED. 10. AT LEAST 75% OF ALL LIGHTING WILL BE HIGH-EFFICACY LAMPS PER 2017 FBC-EC CODE

11. ALL EXTERIOR LIGHT FIXTURES SHALL BE RATED FOR EXTERIOR USE.

12. G.C. SHALL VERIFY SMOKE DETECTOR IN EACH HABITABLE ROOM & CARBON MONOXIDE DETECTOR WITHIN (10) TEN FEET. CM ALARMS PER FBC R315. 3. ALL OUTLETS TO BE TAMPER PROOF PER NEC 2014.

8-31-22 BUILDING DEPT. REVISIONS 11-21-22 EXISTING GRADE REVISION -22 Drawn By: S

Checked By: 06-20-2

Residence Way

A CUSTOM HOME:
Wilson-Bringle R
590 Companion W
Longboat Key, FI

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Planning, Zoning & Building

