# 5950 GULF OF MEXICO DR.



MPDES

NPDES

# PLAN INDEX

# A-SHEETS

SHEET A1.0 = SITE PLAN, PLAN INDEX AND AREA CALCULATIONS.

SHEET A2.0 = GROUND FLOOR PLAN.

SHEET A2.1 = GROUND FLOOR

SHEET A4.0 = ELEVATED 2ND FLOOR PLAN.

SHEET A4.1 = ELEVATED 2ND FLOOR DIMENSIONAL PLAN

SHEET A4.2 = ELEVATED 2ND FLOOR WINDOW, DOOR AND MULLION SCHEDULE.

SHEET A5.0 = EXTERIOR BUILDING ELEVATIONS.

SHEET A11.0 = TYPICAL DETAILS SHEET A12.0 = ROOF PLANS

SHEET S5.0 = UPPER ROOF FRAMING PLAN.

SHEET S7.0 = SECTIONS.

PROJECT DATA

PROJECT TITLE

DILLION RESIDENCE

PROJECT LOCATION

MANATEE COUNTY PID: 7897600008 5950 GULF OF MEXICO DR, LONGBOAT KEY FL 34228 SURVEYOR:

MSB SURVEYING INC 31 SARASOTA CENTER BLVD # C SARASOTA, FLORIDA 34240 PHONE NO. 941-341-9935

CUSTOM RESIDENCE DESIGNED BY:

JC DRAFTING & DESIGN, INC. (Residential Drafting and Design) 905 PONDER AVE. SUITE C

Sarasota, FL 34232 PH (941) 925 - 3009

CONTACT: Jon R. Coulthurst, President

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GENERAL CONTRACTOR:

**BLUEWATER CONSTRUCTION LLC** 

12615 RIVER ROAD MYAKKA CITY, FLORIDA 3425

LICENSE # CGC1506434

941-322-2200

PROJECT STRUCTURAL ENGINEER:

STRUCTURAL ENGINEERING ALLIANCE, INC.

THOMAS WINKLER, P.E.

CONTACT NO: 941-932-7274

FL. REG. NO. 54400

FAY 27 2022 APPROVED

MAY 23 2022

NOTE: THESE DRAWINGS ARE NOT TO BE SCALED

SHEET A1.1 = PARTIAL PLAN

SHEET A2.2 = GROUND FLOOR WINDOW, DOOR AND MULLION SCHEDULE.

SHEET A3.0 = ELEVATED 1ST FLOOR PLAN.

SHEET A3.1 = ELEVATED 1ST FLOOR DIMENSIONAL PLAN SHEET A3.2 = ELEVATED 1ST FLOOR WINDOW, DOOR AND MULLION SCHEDULE.

SHEET A6.0 = EXTERIOR BUILDING ELEVATIONS.

SHEET A7.0 = BUILDING SECTIONS A-A

SHEET A8.0 = BUILDING SECTIONS B-B AND C-C

SHEET A9.0 = TYPICAL EXTERIOR WALL SECTION DETAIL, INTERIOR AND EXTERIOR SPIRAL STAIR DETAILS

SHEET A10.0 = TYPICAL DETAILS

ELECTRICAL

SHEET E1.0 = GROUND FLOOR ELECTRICAL/REFLECTIVE CEILING PLAN.

SHEET E2.0 = ELEVATED 1ST FLOOR ELECTRICAL/REFLECTIVE CEILING PLAN.

SHEET E3.0 = ELEVATED 2ND FLOOR ELECTRICAL/REFLECTIVE CEILING PLAN.

SHEET S1.0 = STRUCTURAL NOTES AND TYPICAL DETAILS.

SHEET S2.0 = FOUNDATION PLAN.

SHEET S3.0 = 1ST FLOOR FRAMING PLAN.

SHEET S4.0 = 2ND FLOOR FRAMING PLAN.

SHEET S6.0 = SECTIONS.

DRAINAGE

SHEET D.O = DRAINAGE PLAN

RECEIVED

SCALE: AS SHOWN SHEET TITLE:

COVER SHEET


SHEET NO. CS1.0

CUSTOM RESIDENCE FOR: DILLION 5950 GULF OF MEXICO DR. LONGBOAT KEY FL 34228

Plan no.

2021-36 CS1.0

DATE: 12-23-2021

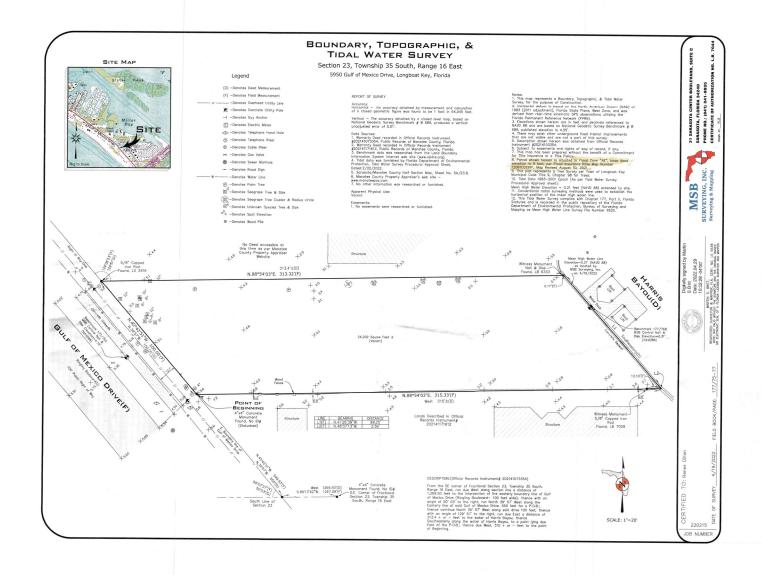

HG & LL ENGINEERING, INC.

> Consulting Engineers #5396 6389 TOWER LANE Sarasota, Fl. 34240

PROJECT NO. 2051

Jamera A Toget

Plan no. 2021-36 A1.0

LAWRENCE D. LIPPERT, P.E. FL. REG. NO. 23985

COMPLIANCE WITH BEST MANAGEMENT PRACTICES FOR EROSION CONTROL AND STORM WATER RUN-OFF DURING CONSTRUCTION:

OFF DURING CONSTRUCTION:

BEFORE ANY CLEARING OR GRADING OCCURS:

CONTRACTOR TO RECT CONTRIBUTES SET FERCE ON SOCS

AND BEACOF PROPERTY.

SLIT FERCING TO BE DIBEDIOGE A MINIMUM OF 8" INTO THE

SLIT FERCE TO BE DIBEDIOGE A MINIMUM OF 8" INTO THE

SLIT FIRST TO BE DISSECTED REGULARLY AND ANY DIMANGED

MARIBALL TO BE MADERIAL PROPERTY AND ANY DIMANGED

IN THE RECT ANY STORM SERVER PROSEDUT AT SIRRET,

STORMENT FLOW, BURSS OF HAVE BUILD'S TO CONTROL.

PROTECT WITH SAMD BASS ON HAY BALES TO CONTROL.

SEQUENT FLOW.

DURING CLEARING CRANDING.

DURING CLEARING CRANDING.

BALE SERMONED HAS STRENGED FROM HE STEE

SHALL SER SHANNED FROM THE STEE MEMBERATE, NO STOCKPRAN OF DEBBES FOR MORE BAT A DAY.

TO DEBBES FOR MORE BAT A DAY.

DURING CONSTRUCTION:

PROVEE SECULARLY SUFFICIENT OF STATE SHEPPASOR(S)

FOR WASTE, FROM ACCURACE, NOW OR ST.

FOR WASTE, FROM ACCURACE, NOW OR ST.

FOR WASTE, FROM COUNTROL.

NO CONCERT, WASDOUT TO SELECTED ON ST. ITS SUPERVISOR(S)

FOR WASTE, FROM COUTROL.

NO CONCERT, WASDOUT TO SELECTED ON ST., INFORM

SUPPLESS HE ADVINCE.

TYPICAL DETAIL AT BOTH SIDES OF HOUSE



NOT TO SCALE : I and swale can meander, to avoid S. Landscape or other obstructions

LEGEND :

- EXTG. GRADE ELEVATION N.A.V.D.

- NEW GRADE/SLAB ELEVATION N.A.V.D. - DIRECTIONAL DRAINAGE ARROWS

\*\*RELATIVE ELEVATION=0'-0" — SLAB ELEVATIONS N.A.V.D. D - LOCATION OF DOWNSPOUT W/ DIRECTION OF DISCHARGE


2.) VERTICAL RISE TO BE 1 VERTICAL IN 4 HORIZONTAL DISTANCE WITHIN 5' FEET (5') OF ANY PROPERTY LINE.


3.) ALL ON-SITE DRAINAGE SHALL BE DIRECTED BY SWALES OR OTHER SYSTEMS TO AN OFF-SITE DRAINAGE FACILITY


5.) SITE DRAINAGE MUST BE CONSISTENT WITH SUBDIVISION STORMWATER MANAGEMENT PLAN. 6.) SITE RUNOFF MAY BE DIRECTED TO THE REAR OF THE LOT IF AN APPROVED DRAINAGE GREENBELT OR OTHER ESTABLISHED PUBLIC OR PRIVATE DRAINAGE FACILITY IS AVAILABLE.

11.) ALL PORTABLE TOILETS AND DUMPSTERS WILL BE STAGED ON PRIVATE PROPERTY AND NOT IN THE RIGHT OF WAY.

12.) IF PARKING ON PUBLIC STREET IS NECESSARY ALL VEHICLES WILL BE PARKED ON ONE SIDE OF THE ROAD WITH TRAFFI

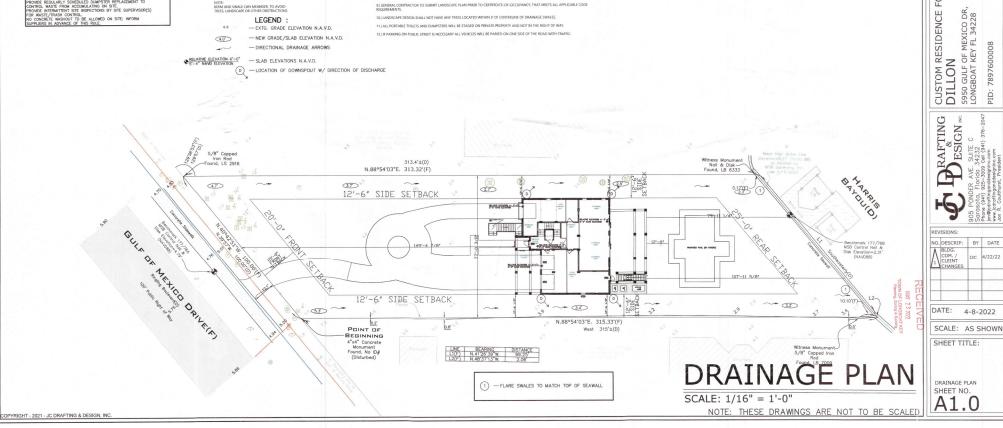

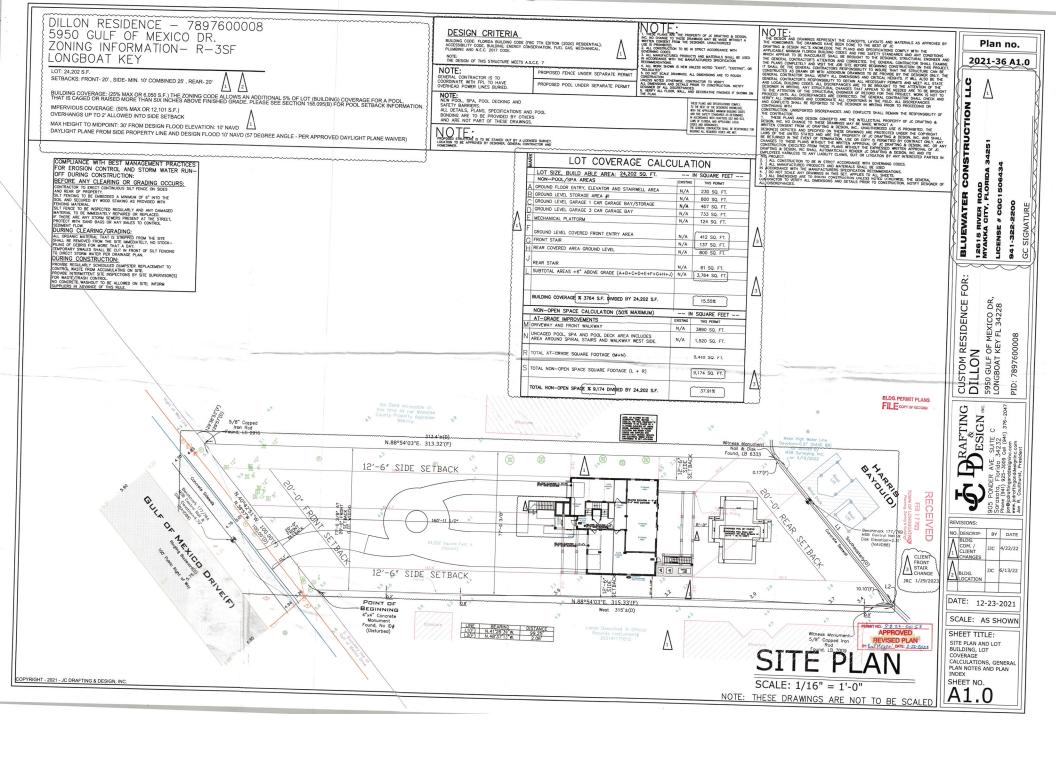

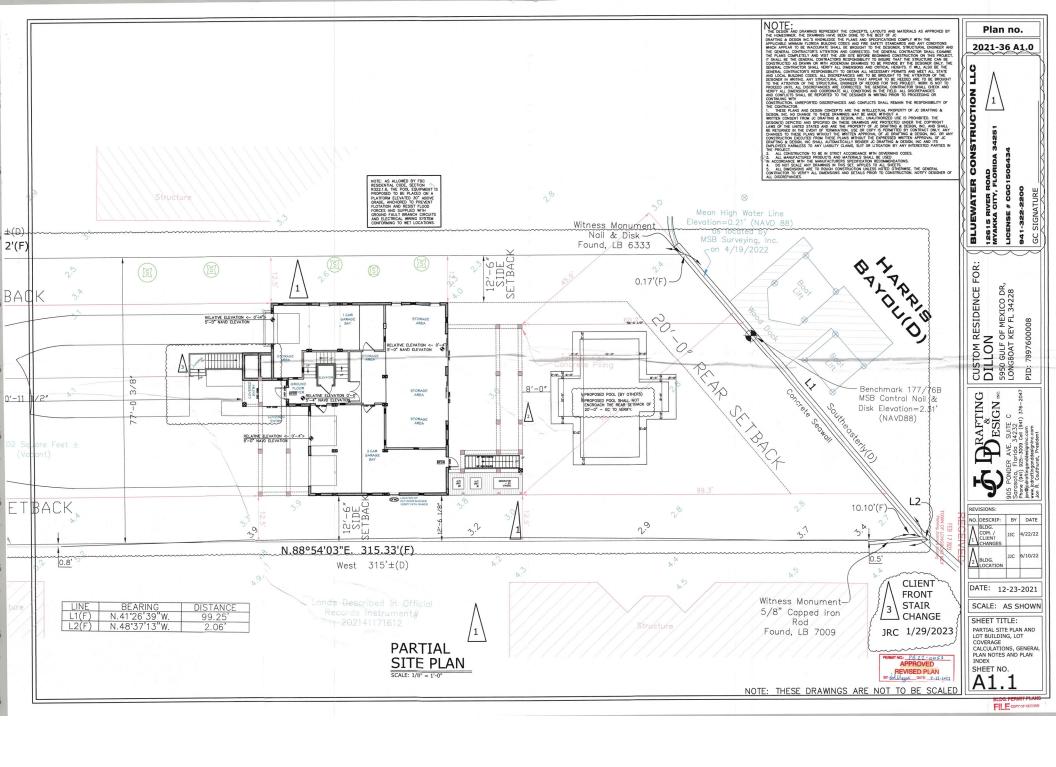

# GENERAL PLAN NOTES:

- OWNER AND/OR CONTRACTOR TO VERIFY ALL DETAILS AND DIMENSIONS 9. ALL ATTIC ACCESS TO BE SEALED AIR TIGHT TO BE INSTALLED ACCORDING TO 2020 FBC ENERGY CONSERVATION SECTION R402.2.4
- PROVIDE A MINIMUM OF 20 FEET OF NO. 4 AWG OR LARGER BARE COPPER ELECTRODE COMPLETED TRANSLESS WITHIN THE CONCRETE FOOTING, EDITED CLAMP (ONE STATE OF THE PROVIDED BY THE PROV 12. DOOR AND WINDOW SPECIFICATIONS ARE TO BE PROVIDED BY THE GENERAL CONTRACTOR AND ARE TO BE INSTALL AS PER THE SUPPLIED MANUFACTURERS'S FASTEMING DETAILS AND SECPETICATIONS. ALLUMINUM MULLIONS TO BE INSTALL PER THE MANUFACTURERS'S SPECIFICATIONS. SEE ENDIFICERED SHOP DRAWINGS BY MANUFACTURER.
- DRYER VENTED TO OUTSIDE WITH METAL VENT (NON-SCREENED WITH BACKDRAFT DAMPER).
- ALL WATER CLOSETS TO HAVE 1.6 GAL, CAP, MAX.

(B) (A8.0)

16 RISERS © 7.3125" EACH 10" TREADS W/ 1" NOSING.

THE CASE MAD DRAWNES REPRESENT HE CONCEPTS, LAVOUTS AND ALBERT AND DRAWNES REPRESENT HE CONCEPTS, LAVOUTS AND ALBERT AND

RNING CODES.
ALL MANUFACTURED PRODUCTS AND MATERIALS SHALL BE

SHEETS.

5. ALL DIMENSIONS ARE TO ROUGH CONSTRUCTION UNLESS NOTED OTHERWISE. THE GENERAL CONTRACTOR TO VERIFY ALL DIMENSIONS AND THE CONTRACTOR TO VERIFY ALL DIMENSIONS AND DETAILS PRIOR TO CONSTRUCTION. NOTIFY DESIGNER OF ALL DISCREPANCIES.

SED N ACCORDANCE WITH THE MANUFACTURERS SPECIFICATION RECOMMENDATIONS.

4. DO NOT SCALE ANY DRAWINGS IN THIS SET. APPLIES TO ALL SHEETS.

- BUILDING INSULATION SHALL BE AS FOLLOWS: FRAME WALLS R  $\sim$  19 ATTIC ROOF PLANE AND FLOOR TRUSS R-21 OPEN CELL SPRAY FOAM.
- PROVIDE "CARBON MONOXIDE ALARM" WITHIN 10'-0" OF ALL SLEEPING ROOMS.

- 16. ALL SHOWER OF BATH TUB DOORS AND FIXED GLASS PANELS ARE TO BE TEMPERED GLASS PER FBC-R SECTION R308.4 ALL BATHROOM GLASS TO BE TEMPERED. ALL SHOWER PAN LINERS SHALL HAVE A 1/4" PER FOOT MINIMUM SLOPE TO DRAIN

DECK/LANDING ABOVE SEE STRUCTURAL DRAWINGS.

SLOPE TOP WALKWAY OUTWARD TO CO CONTROL CONTRO

Ø

GENERAL CONTRACTOR AND WINDOW/DOOR MANUFACTURER ARE RESPONSIBLE TO INSTALL WINDOWS AND DOORS AND TO PROVIDE A WATER TIGHT AND WATER PROOF SEAL. 10. TEMPERED GLASS TO MEET FBC-R R308.4 IN HAZARD LOCATIONS.

WINDOWS, EXTERIOR DOORS AND OVERHEAD GARAGE DOORS TO HAVE CURRENT FLORIDA PRODUCT APPROVAL OR MIAMI-DADE N.O.A.'S CONTRACTOR SHALL PROVIDE DOCUMENTATION FOR APPROVED SYSTEMS WITH PERMIT APPLICATION.

TERMITE PROTECTION TO BE COMPLIANT WITH 2020 FBC-SOIL PROTE EXTEND 12" BEYOND EXTERIOR WALLS OF STRUCTURE OR USE BORA-TERMITICIDE, INSECTICIDE FUNGICIDE CONCENTRATE.

17 PROVIDE ERESH AIR MAKELIPAS REQUIRED FOR BLOWER DOOR TEST.

STORAGE

AREA

-12" SQUARE COLUMN

COVERED

ENTRY

SLOPE TOP DRIVEWAY OUTWARD TO DRAINAGE SYSTEM.

-12" SQUARE — BEAM ABOVE

BEAM ABOVE

-12" SQUARE COLUMN

12" SQUARE BEAM ABOVE

OROUND B

FLOOR

FOYER

RELATIVE ELEVATION <- 0'-4">

-12" SQUARE COLUMN

RELATIVE ELEVATION <- 0'-4">
5'-0" NAVD ELEVATION

A<sup>1</sup>0

15. PROVIDE TUB ACCESS AT TUB LOCATIONS.

- 19. ALL EXTERIOR WINDOWS AND DOORS WITH GLAZING ARE TO BE IMPACT RATED. ALL RECEPTACLES NOT REQUIRED TO BE GFCI SHALL BE ARC FAULT PROTECTED PER THE CURRENT NEC. ALL RECEPTACLES TO BE TAMPER PROOF WHERE REQUIRED BY THE CURRENT NEC.
  - 20 CENERAL CONTRACTOR IS TO VERIEV ALL WINDOW AND DOOR SIZES
  - GENERAL CONTRACTOR IS TO VERIFY ALL EGRESS LOCATIONS AND SIZES, TO MEET FBC 2020 (7TH EDITION) SECTION R310.
  - 22 ALL WINDOW AND DOOR STSS. ME LOPROMANE.

    FER PROME FIG R307.1 AND USE CRUENT BOARD.

    CREENL CONTRACTOR TO VERFY ALL CENTER LINE

    OCATIONS AND FLAGEST BOOMERY, WH.S.C. R807. CONTRACTOR TO

    AS NEGERIAL CONTRACTOR TO VERFY ALL CENTER LINE

    PROVIDE PROVIDE PROMISSION.
  - 23. GENERAL CONTRACTOR IS TO VERIFY ALL HOSE BIB LOCATIONS. 24. ALL DIMENSIONS ARE TAKEN FROM THE EDGE OF FRAMING.
  - 25. GENERAL CONTRACTOR SHALL VERIFY ALL DIMENSIONS AND CONDITIONS PRIGR TO COMMENCEMENT OF WORK, REPORT ANY DISCREPANCIES TO THE DRAFTSMAN AND OR STRUCTURAL ENGINEER OF RECORD BEFORE PROCEEDING WITH ANY WORK.

EVATION <-0'

A

STORAGE

AREA

RELATIVE ELEVATION <-0

RELATIVE ELEVATION <-0'-1'>
15-3" NAVD ELEVATION

3 CAR

GARAGE

BAY

26. ALL EXTERIOR DOORS TO BE SOLID CORE.

SLOPE TOP OF SLAB
OUTWARD TO DOOR OPENINGS

-1521-

(B)

BEAM ABOVE IN

56" HIGH RAILING

© J

1 CAR

GARAGE BAY

-CONCRETE COLUMN

CONCRETE COLUMN

-POST ABOVE

-BEAM ABOVE IN

-CONCRETE COLUMN

-BEAM ABOVE IN FLOOR SYSTEM

₿

SLOPE TOP OF SLAB OUTWARD TO DOOR OPENINGS

 $\nabla \nabla$ 

27. EXTERIOR CEMENTITIOUS COATING SHALL COMPLY WITH FBC-R SECTIONS 703.6 AND 703.6.5.

AREA

STORAGE

AREA

STORAGE

ARFA

LOCATION OF OUT DOOR

ELEVATION OF 10'-0" NAVD

CONTROLS ARE ALLOWED

SHOWER VERIFY WITH OWNER.

HEAD REQUIRED TO BE AT OR

X

—6X6 P.T. COLUMN BELOW ON CONCRETE

4

RELATIVE ELEVATION <- 0'-4"
5'-0" NAVD ELEVATION

-CONCRETE COLUMN STORAGE

OPE TOP OF SLAB

(B)

SLOPE TOP OF SLAB OUTWARD TO DOOR OPENINGS

-CONCRETE COLUMN

-CONCRETE COLLIMN

SLOPE TOP OF SLAB

-CONCRETE COLUMN

₱ RELATIVE ELEVATION <-0'-1">
5'-3" NAVD ELEVATION

GROUND FLOOR PLAN


SCALE: 1/4" = 1'-0"

CONCRETE COLLIMN

<u>4</u>

4

X

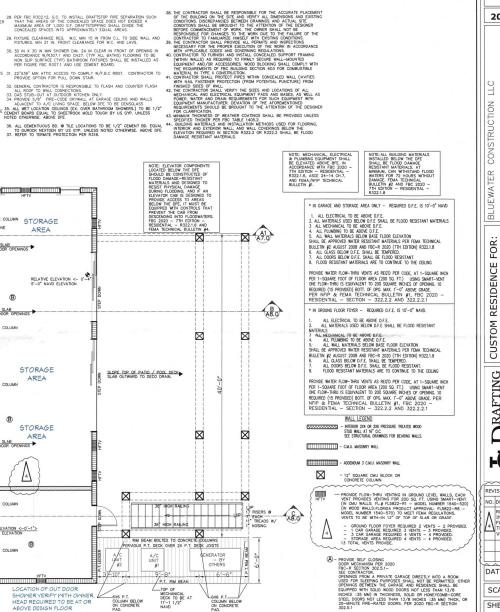

B-DENS-GLASS WALL BOARD OVER PRESSURE TREATED FRAMING AT

NOTE: THESE DRAWINGS ARE NOT TO BE SCALED

WALLS. 5/8" FIRE RATED DRYWALL @ CEILING.

C - NOTE: PROVICE SUMP PUMP WITH FLOAT SWITCH AT BOTTOM OF ELEVATOR PIT WITH 2' PVO PIPE TO DISCARAGE OUTSDE OF THE BUILDING AT SWALE, TERMINATE PIPE AT EXTERIOR BOD WITH DRAMAGE BUBBLE BOX MITH INSECT SCREEN. MUST COMPLY WITH FBC-R, PSOOT,32.

Plan no.

2021-36 A2.0

434 12615 RIVER ROAD MYAKKA CITY, FLORIDA CGC15064 # 322-LICENSE

SIGNATUR

GC

7897600008

PID:

CONSTRUC

FOR OF MEXICO DR, KEY FL 34228 RESIDENCE LON R CUSTOM F
DILLON
5950 GULF C
LONGBOAT H

RAFTING ESIGN INC. () TE C 52 (941)

REVISIONS NO. DESCRIP: BY DATE REMOVE INTERIOR FLOW THRU VENTS

DATE: 12-23-2021


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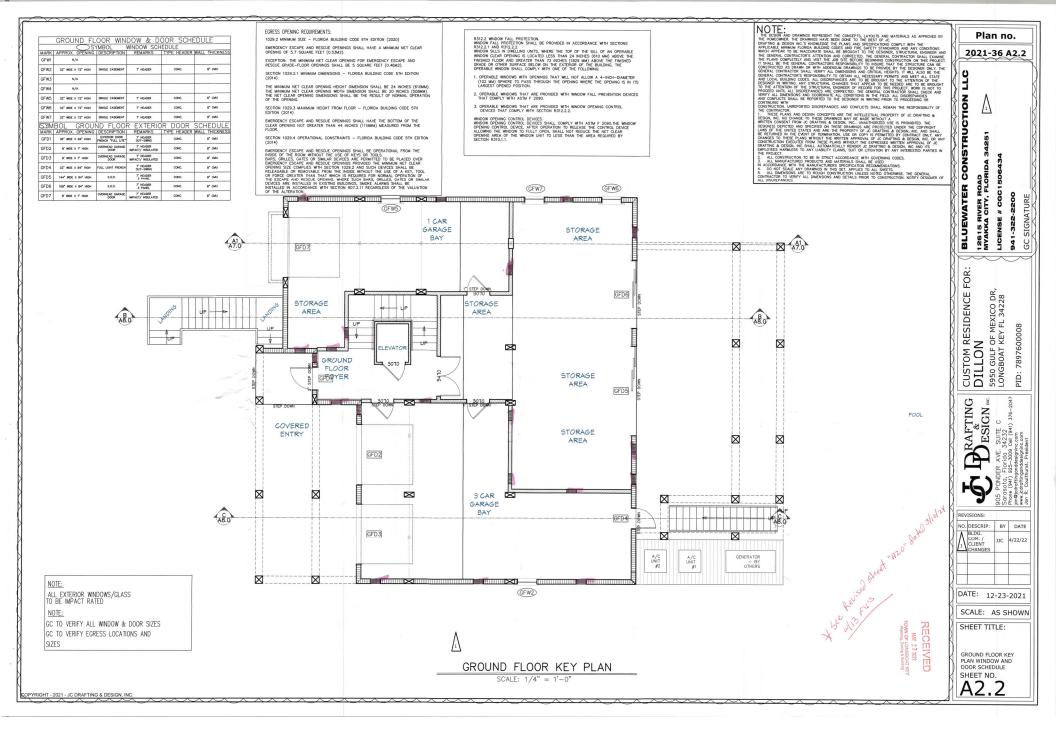
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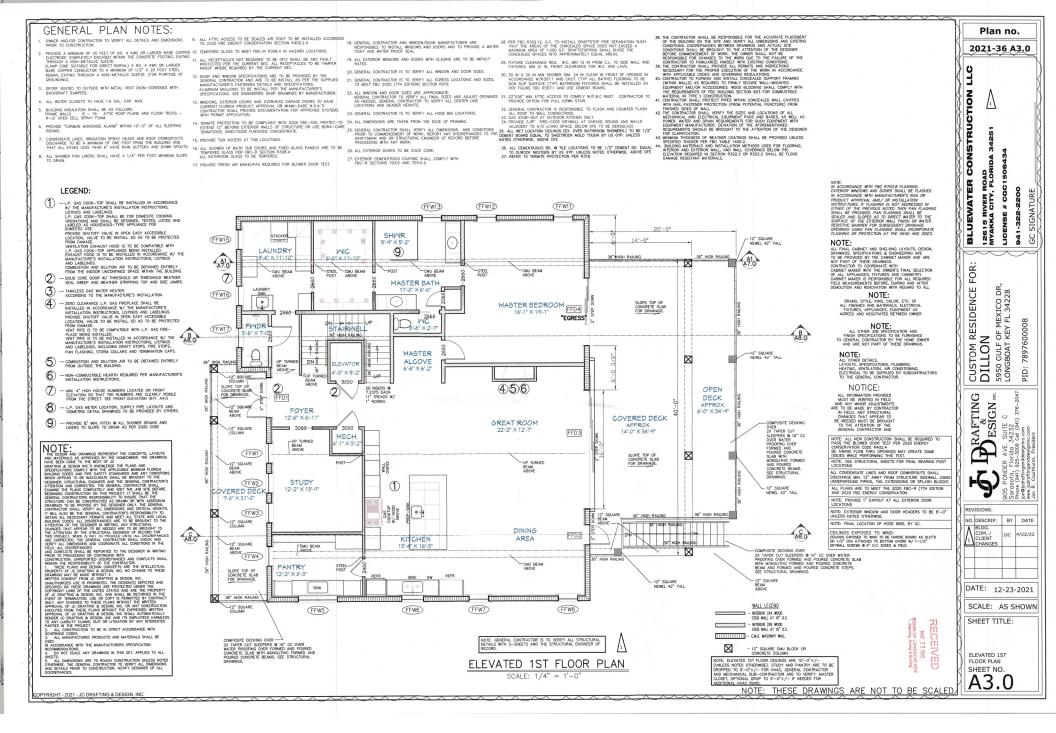
GROUND FLOOR SHEET NO.


A2.0


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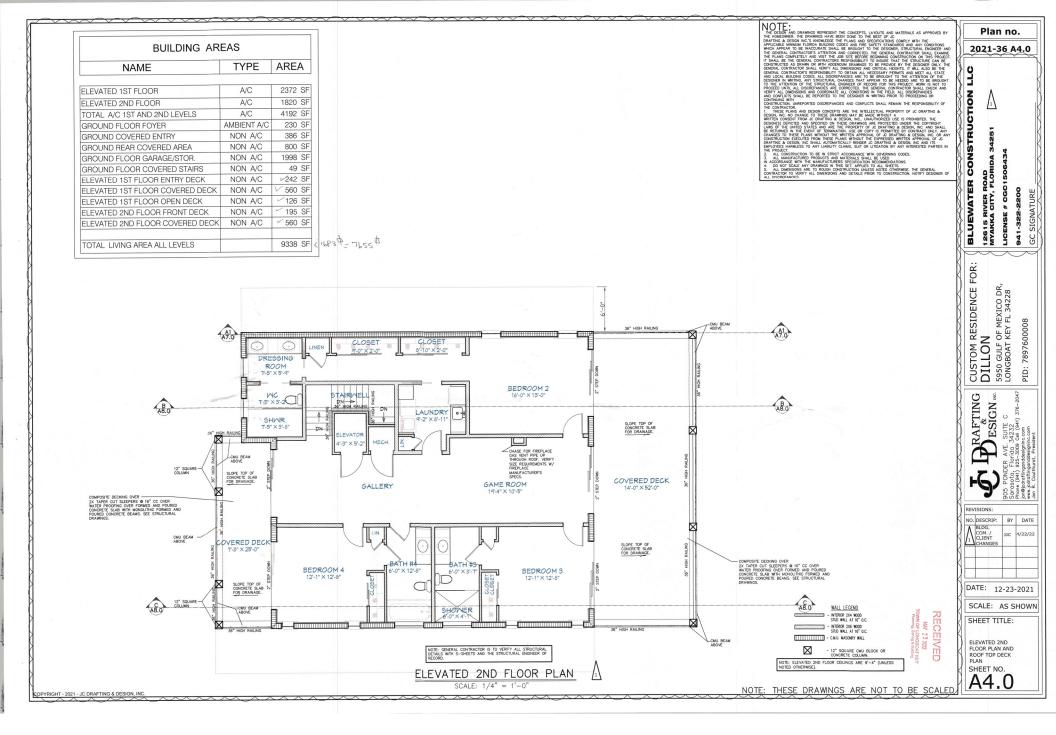








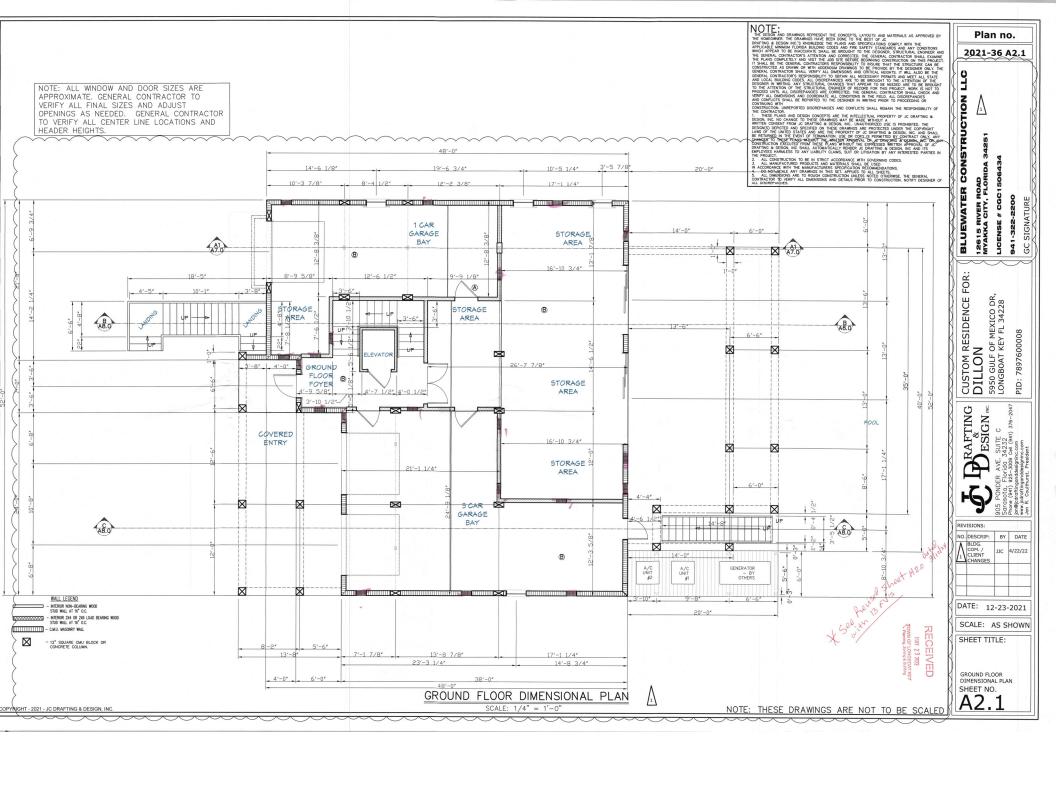


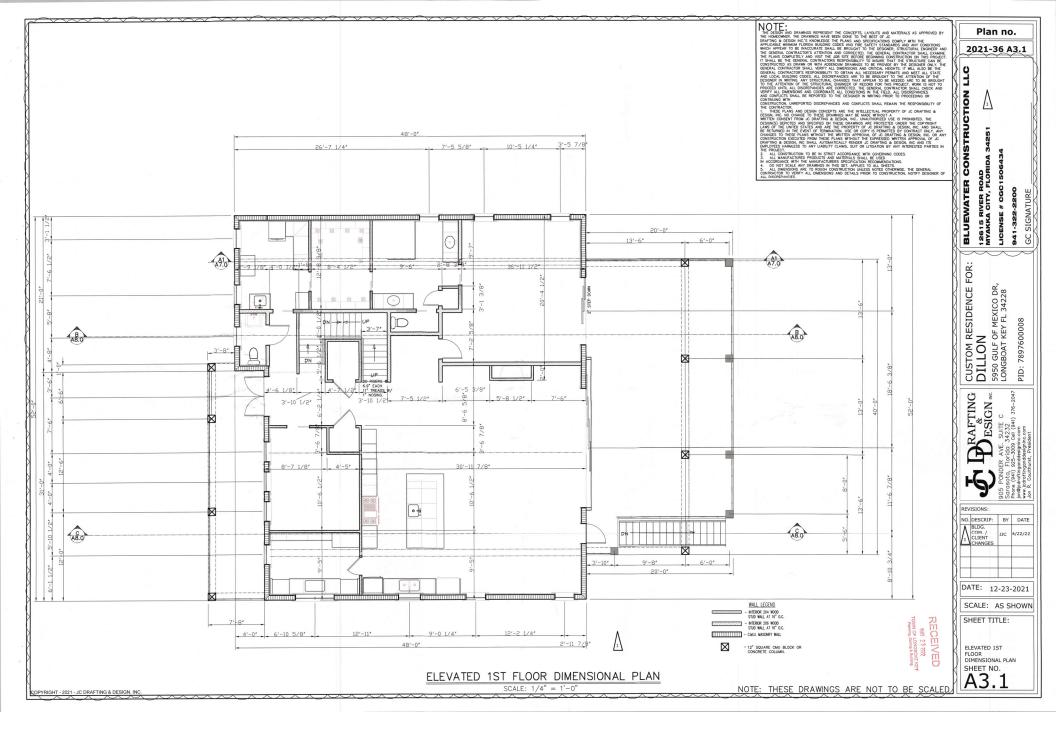


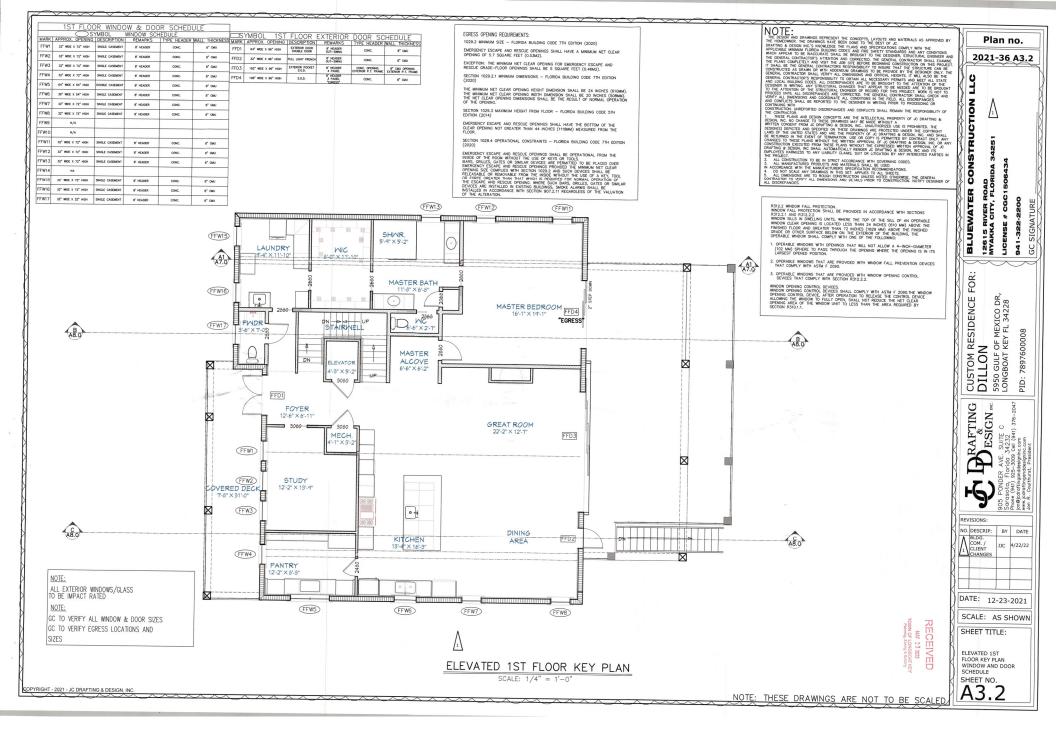


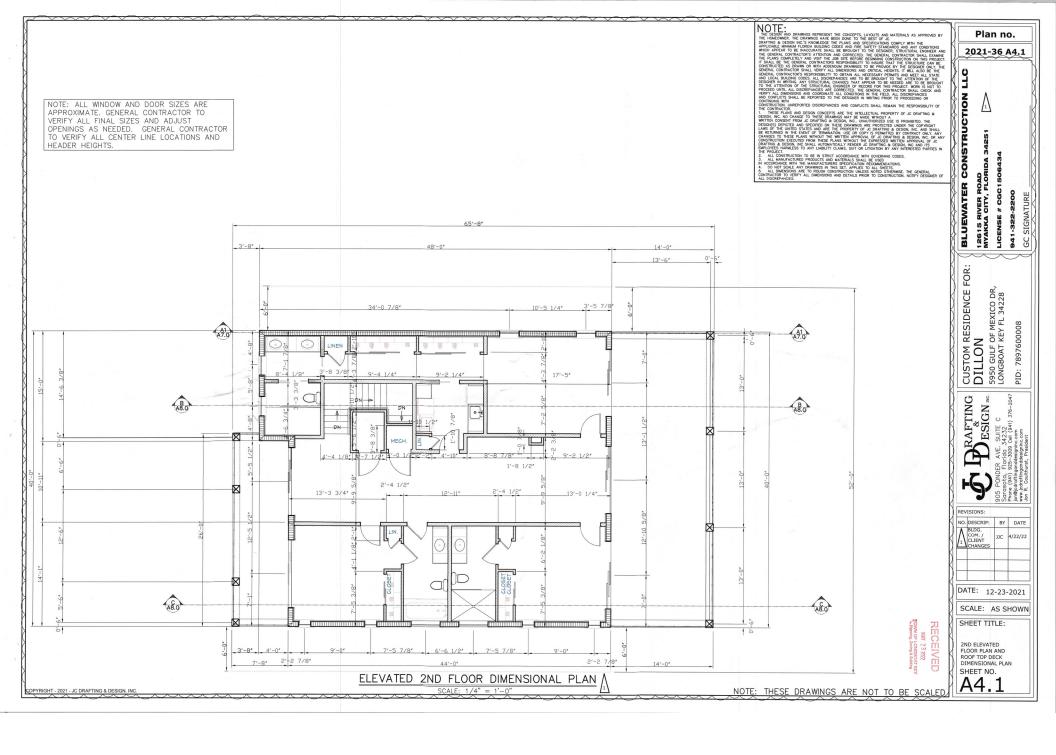

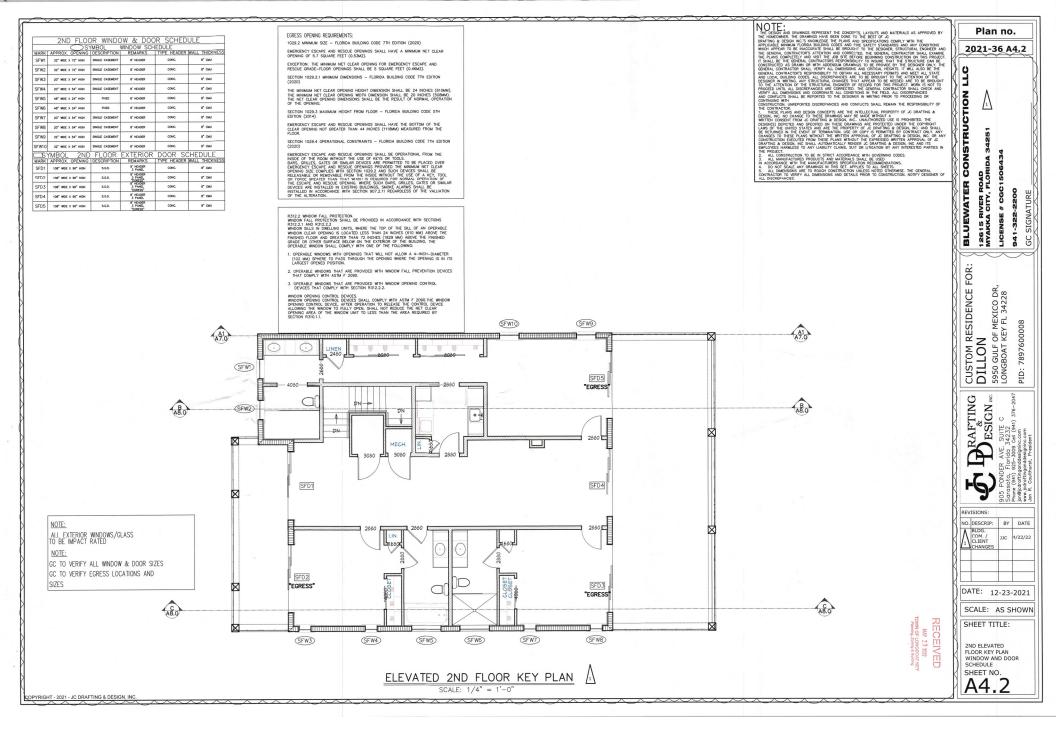


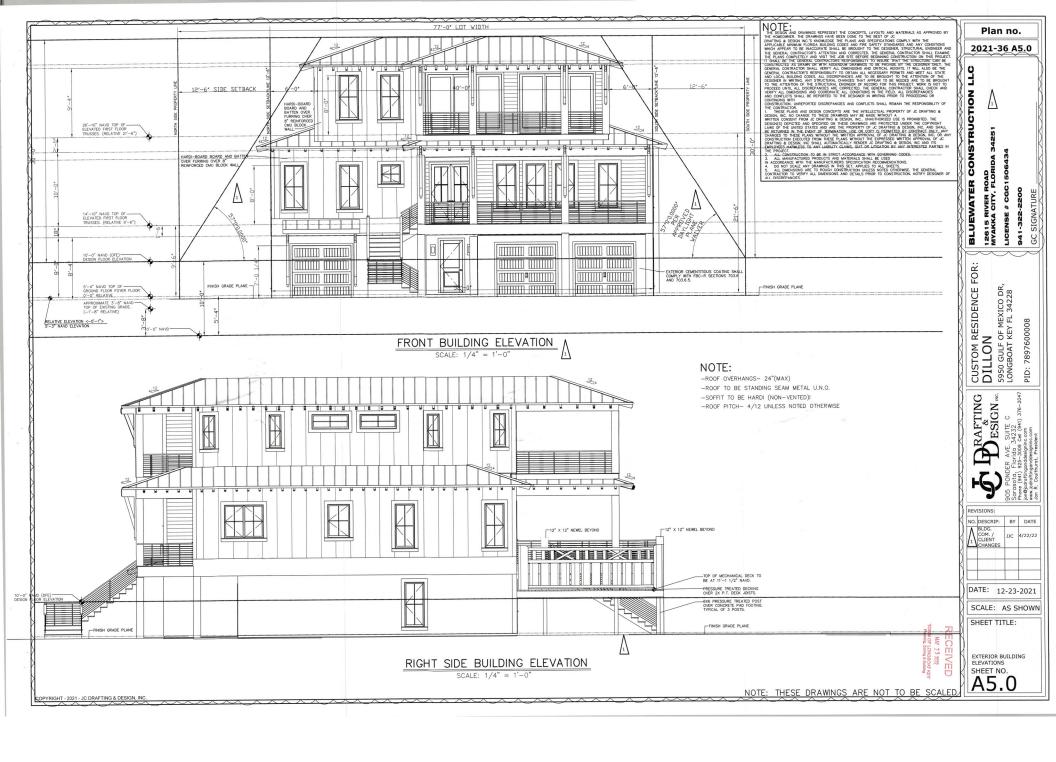


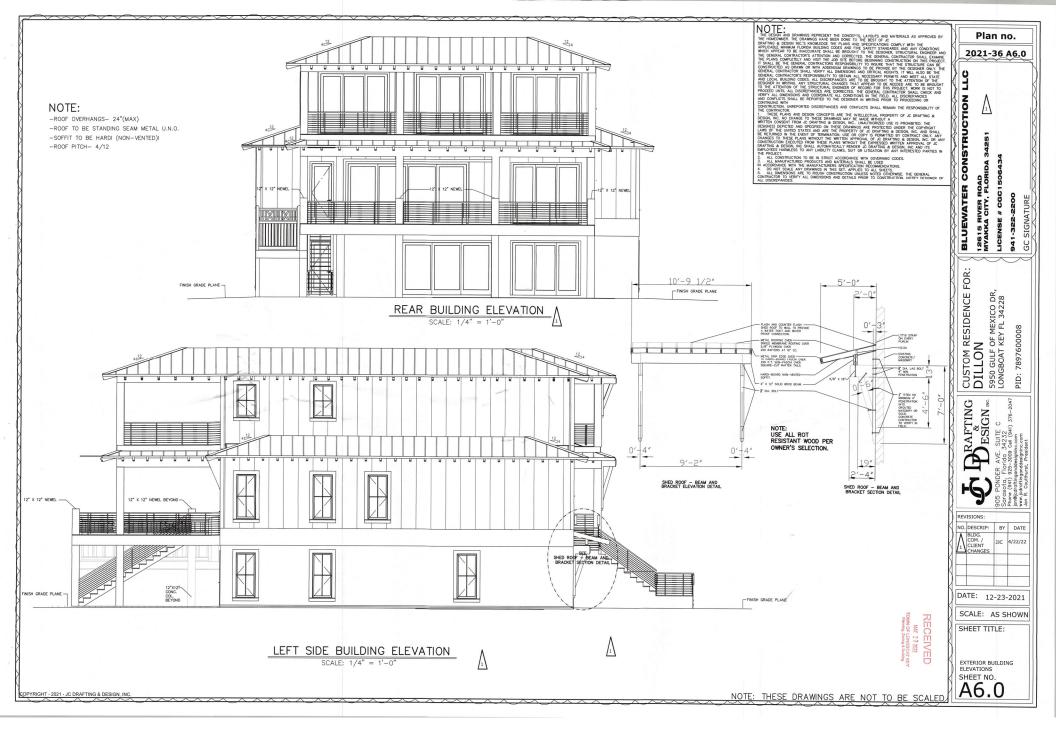

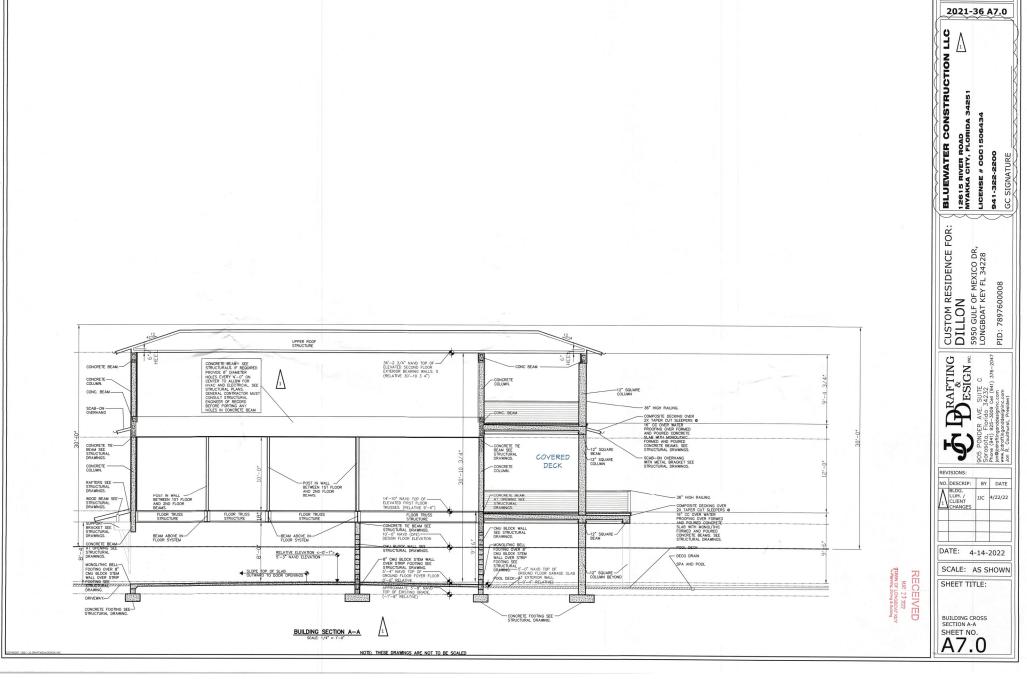

Plan no.

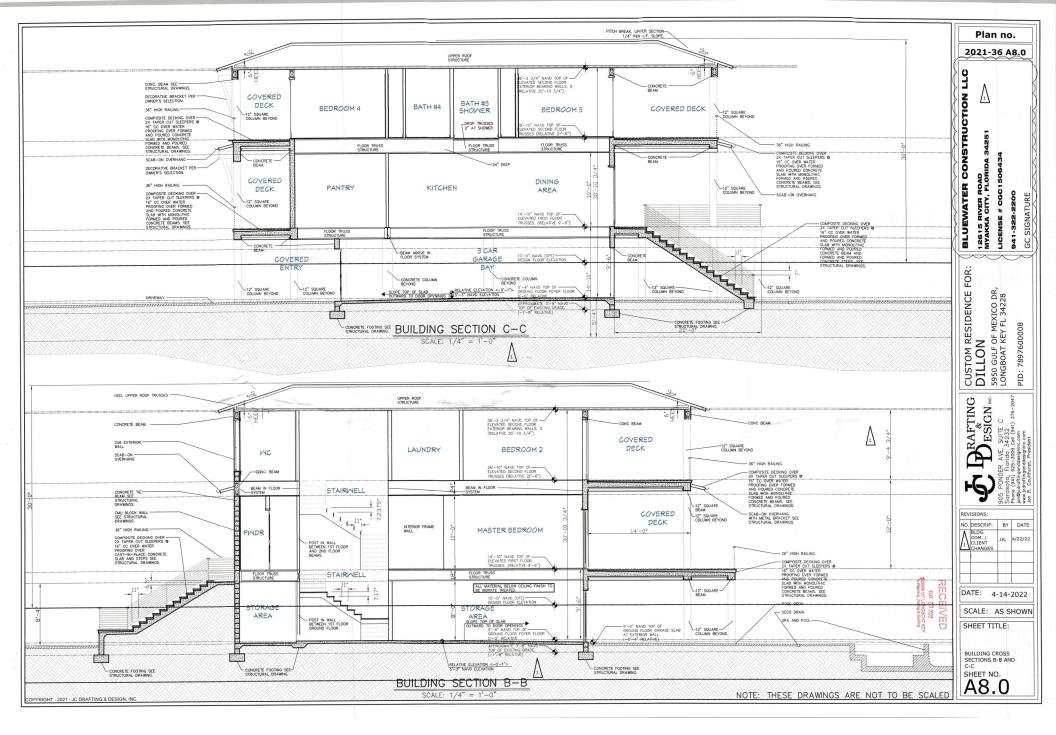

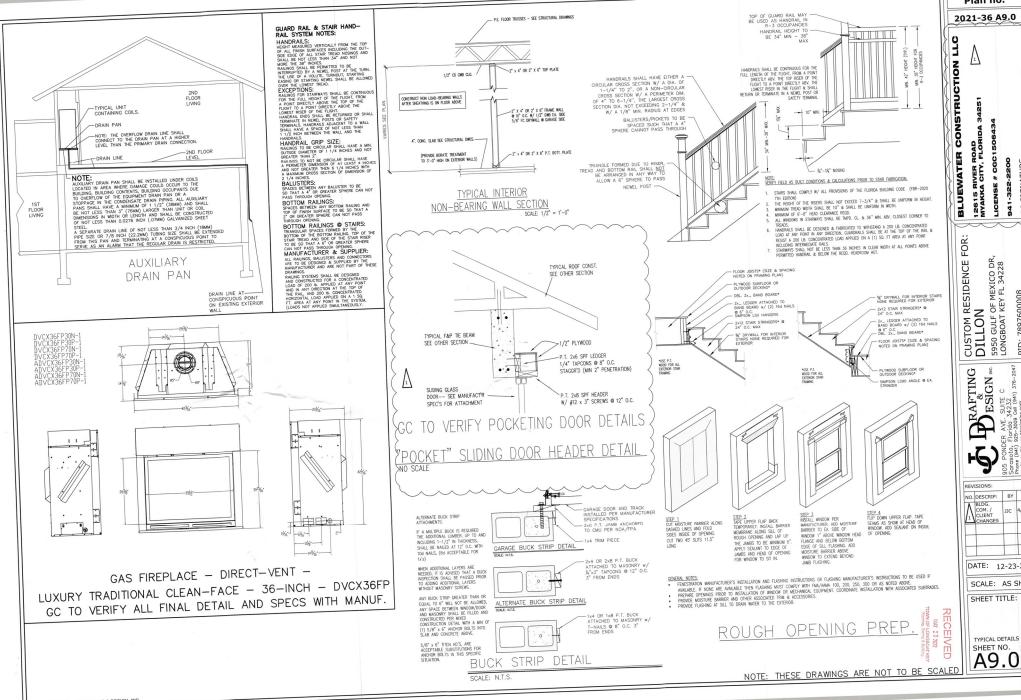

Plan no.

5950 GULF OF MEXICO DR, LONGBOAT KEY FL 34228

941-322-2200 SIGNATURE

GC

BY DATE


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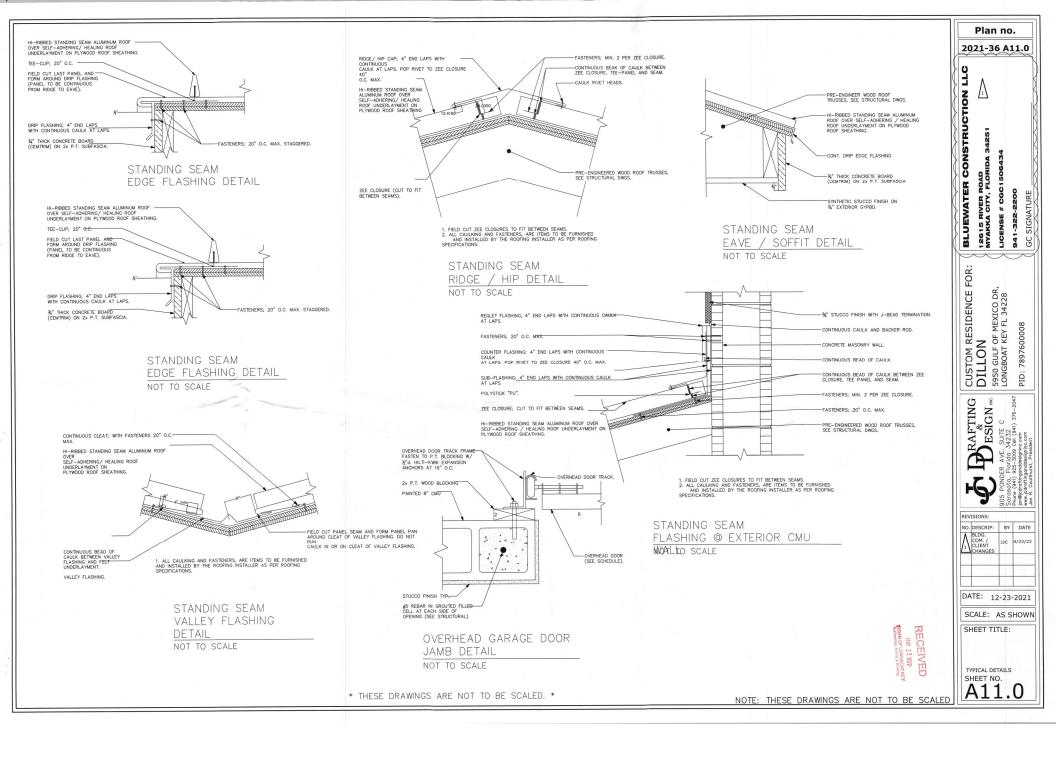
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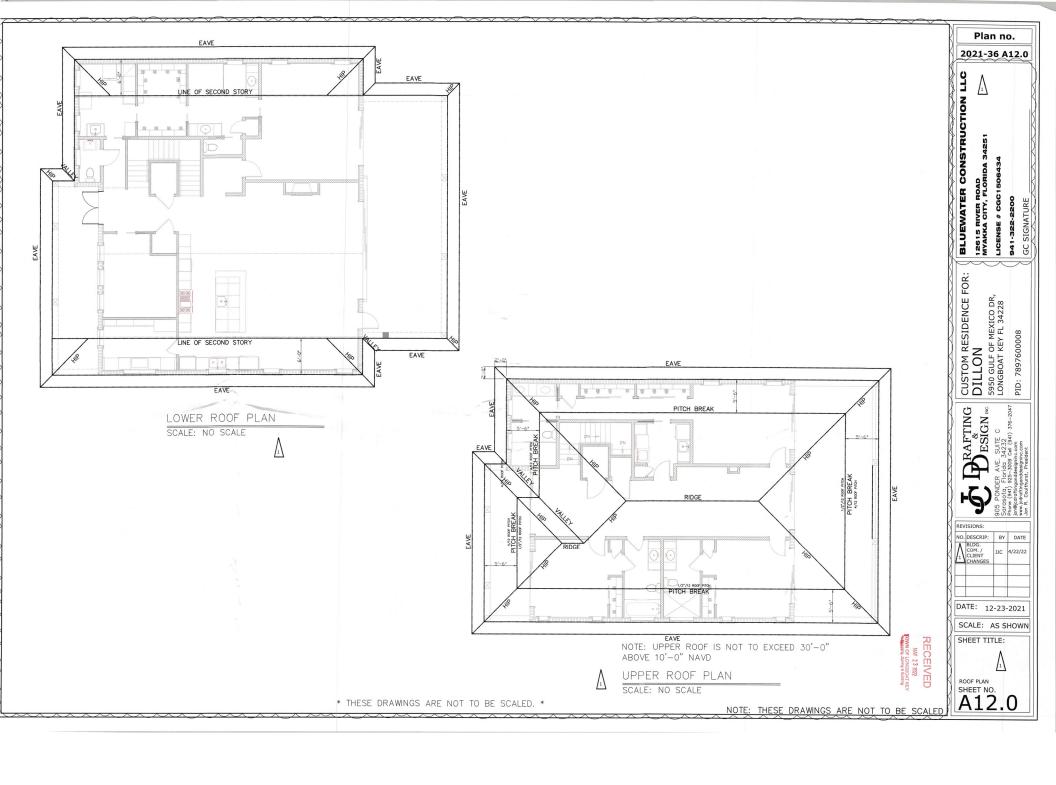
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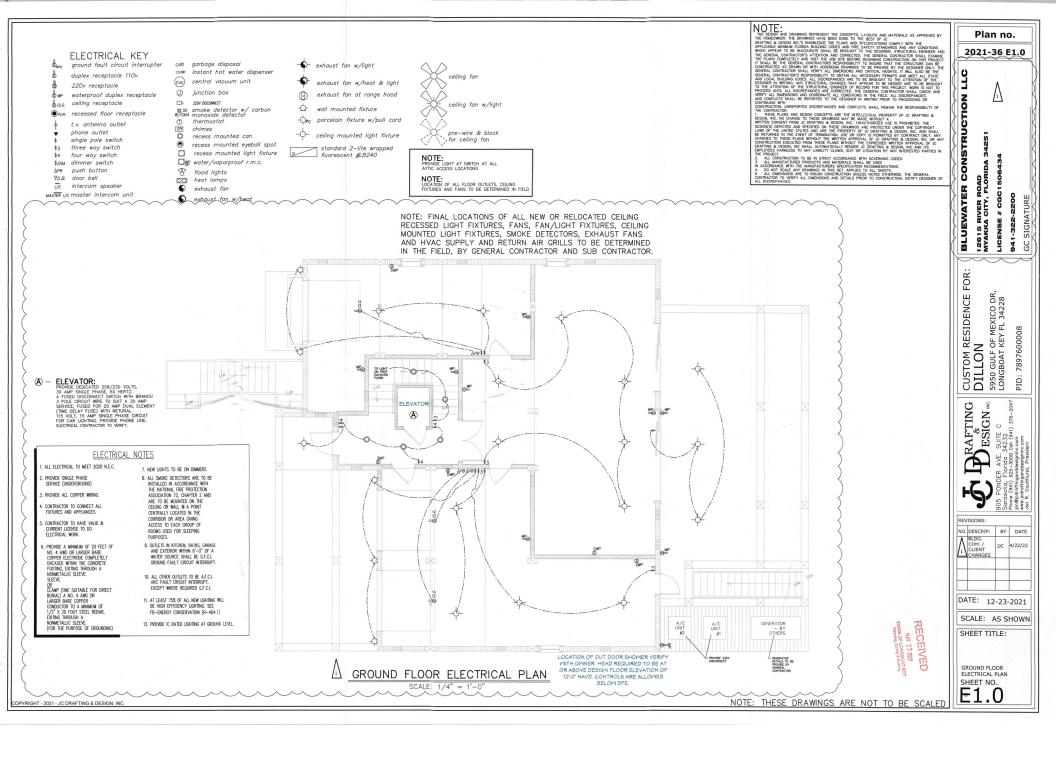
TYPICAL DETAILS SHEET NO.

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**ELECTRICAL KEY** 

ground fault circuit interrupter duplex receptacle 110v

220v receptacle waterproof duplex receptacle

bas ceiling receptacle ●FLR. recessed floor receptacle

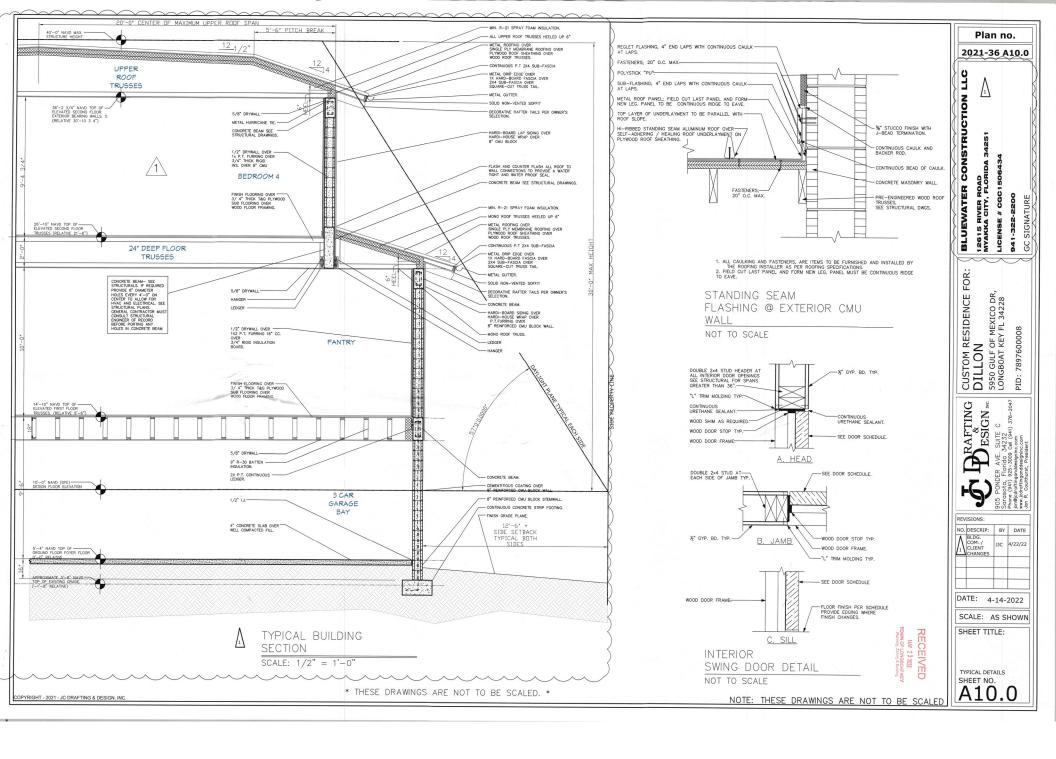t.v. antenna outlet phone outlet single pole switch

three way switch four way switch

\$DIM dimmer switch BPB push button ₹D.B. door bell

i/c intercom speaker MASTER I/c master intercom unit

garbage disposal CHW instant hot water dispense CVU central vacuum unit

exhaust fan at range hood

SD smoke detector w/ carbon w/cma monoxide detector wall mounted fixture

recess mounted can recess mounted eyeball spot recess mounted light fixture

water/vaporproof r.m.c. flood lights
heat lamps
exhaust fan

()

☐h 220V DISCONNECT


① thermostat
② chimes
② recess moun

exhaust fan • exhaust fan w/heat exhaust fan w/light

exhaust fan w/heat & light

-OPC porcelain fixture w/pull cord

ceiling mounted light fixture standard 2-lite wrapped fluorescent #LB240

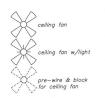

NOTE: PROVIDE LIGHT AT SWITCH AT ALL ATTIC ACCESS LOCATIONS

NOTE: LOCATION OF ALL FLOOR OUTLETS, CEILING FIXTURES AND FANS TO BE DETERMINED IN FIELD

NOTE: FINAL LOCATIONS OF ALL NEW OR RELOCATED CEILING RECESSED LIGHT FIXTURES, FANS, FAN/LIGHT FIXTURES, CEILING MOUNTED LIGHT FIXTURES, SMOKE DETECTORS, EXHAUST FANS AND HVAC SUPPLY AND RETURN AIR GRILLS TO BE DETERMINED IN THE FIELD, BY GENERAL CONTRACTOR AND SUB CONTRACTOR Plan no.

2021-36 E2.0

CONSTRUCTION BLUEWATER

FOR:

LICENSE # CGC15064 SIGNATURE

CUSTOM RESIDENCE FI DILLON
5950 GULF OF MEXICO DR, LONGBOAT KEY FL 34228

BRAFTING ESIGN ...

NO. DESCRIP: BY DATE BLDG. COM. / CLIENT CHANGES

DATE: 12-23-2021 SCALE: AS SHOWN

SHEET TITLE:

ELEVATED 1ST FLOOR ELECTRICAL SHEET NO. E2.0

NOTE: THESE DRAWINGS ARE NOT TO BE SCALED

NOTE: PROVIDE POWER FOR ROLL DOWN SCREENS

Ø SD W/CMA D.B.

NOTE: CONTRACTOR TO PROVIDE SMOKE ALARM AT TOP AND BOTTOM OF STAIRS, INTERCONNECTED WITH ALL OF THE OTHERS, ON PLAN.

ELEVATED 1ST FLOOR ELECTRICAL PLAN

SCALE: 1/4" = 1'-0"

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ELECTRICAL KEY ground fault circuit interrupter duplex receptacle 110v CVU 220v receptacle (1) waterproof duplex receptacle ceiling receptacle ●FLR. recessed floor receptacle t.v. antenna outlet CH chimes
O recess phone outlet recess mounted can single pole switch necess mounted eyeball spot three way switch recess mounted light fixture four way switch ☐₩ water/vaporproof r.m.c. \$nim dimmer switch push button 8 90.8. door bell lool heat lamps intercom speaker MASTER I/C master intercom unit

exhaust fan s exhaust fan w/heat NOTE: PROVIDE LIGHT AT SWITCH AT ALL ATTIC ACCESS LOCATIONS NOTE: LOCATION OF ALL FLOOR OUTLETS, CEILING FIXTURES AND FANS TO BE DETERMINED IN FIELD

flood lights

oco garbage disposal exhaust fan w/light OHW instant hot water dispenser central vacuum unit exhaust fan w/heat & light iunction box (8) exhaust fan at range hood □h 220V DISCONNECT Φ wall mounted fixture SD smoke detector w/ carbon w/CMA monoxide detector porcelain fixture w/pull cord thermostat ceiling mounted light fixture

standard 2-lite wrapped

\_\_ fluorescent #LB240

pre-wire & block for ceiling fan

NOTE: FINAL LOCATIONS OF ALL NEW OR RELOCATED CEILING RECESSED LIGHT FIXTURES, FANS, FAN/LIGHT FIXTURES, CEILING MOUNTED LIGHT FIXTURES, SMOKE DETECTORS, EXHAUST FANS AND HVAC SUPPLY AND RETURN AIR GRILLS TO BE DETERMINED IN THE FIELD, BY GENERAL CONTRACTOR AND SUB CONTRACTOR.

> ₩ SD W/CMA **(A)** DN ELEVATOR P SSO \$\$ ⊠ SD W/CMA Die

NOTE: CONTRACTOR TO PROVIDE SMOKE ALARM AT TOP AND BOTTOM OF STAIRS, INTERCONNECTED WITH ALL OF THE OTHERS, ON PLAN.

ELEVATED 2ND FLOOR ELECTRICAL PLAN

THE CESSI AND DRAWING REPRESENT THE CONCEPTS, LAYOUTS AND MATERIALS AS APPROVED BY THE CESSION AND DRAWING REPRESENT THE CONCEPTS, LAYOUTS AND MATERIALS AS APPROVED BY DISCUSSION, TO STORE THE PLANT AND SECRETARILY COMPLY THE PLANT AND SECRETARILY CONTRACTORS SHALL DRAWING AND THE CONTRACTORS ATTENDED AND CONSECUTION AND CONSECUT

REVISIONS NO. DESCRIP: BY

COM. / CLIENT CHANGES

2ND ELEVATED FLOOR PLAN AND ROOF TOP DECK ELECTRICAL PLAN SHEET NO.

NOTE: THESE DRAWINGS ARE NOT TO BE SCALED

NOTE: PROVIDE POWER FOR ROLL DOWN SCREENS

RECEIVED

MAY 23 7072

OWN OF LONGBOAT KEY
Planning, Zoning & Building

RAFTING ESIGN INC.

FOR: CUSTOM RESIDENCE FIDELLON
5950 GULF OF MEXICO DR,
LONGBOAT KEY FL 34228

12615 RIVER ROAD MYAKKA CITY, FLORIDA

LICENSE # CGC15064

941-322-2200

Plan no. 2021-36 E3.0

NO

CONSTRU

BLUEWATER

7897600008 PID:

DATE 4/22/22

DATE: 12-23-2021

SCALE: AS SHOWN

SHEET TITLE:

E3.0

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SCALE: 1/4" = 1'-0'

#### STRUCTURAL NOTES


GENERAL NOTES: THE STRUCTURAL DRAWNOS SHALL BE USED IN CONJUNCTION WITH ALL OTHER CONSTRUCTIONS DOCUMENTS. THIS INCLIDES, BUT IS NOT LIMITED TO, SPECIFICATION ARCHITECTURAL MECHANICAL, ELECTRICAL, PLUMBING AND SITE DRAWNOS.

DESIGN LOADS: THE STRUCTURAL SYSTEMS FOR THIS BUILDING HAVE BEEN DESIGNED IN ACCORDANCE WITH THE FLORIDA BUILDING CODE, 2000 SEV LOADS WERE UTILIZED IN THE DESIGN.

FOUNDATION DESIGN: FOUNDATIONS ARE DESIGNED FOR AN ALLOWABLE SOIL BEARING PRESSURE OF 2000 PSF ON WELL COMPACTED FILL. BEFORE CONSTRUCTION COMMENCES, THE SOIL BEARING PRESSURE, SOIL CONDITIONS, AND SOIL COMPACTION REQUIREMENTS SHALL BE VERIFIED BY A LICENSED GEOTECHNICAL ENGINEER.

CONCRETE: SHALL BE PER AN APPROVED MIX DESIGN PROPORTIONED TO ACHIEVE A STRENGTH AT 28 DAYS AS LISTED BELOW WITH A PLASTIC AND WORKABLE MIX.


PENETRATIONS: NO PENETRATIONS SHALL BE MADE IN ANY STRUCTURAL MEMBERS OR SLASS OTHER THAN THOSE LOCATED ON THESE DRAWNOS. IF ADDITIONAL PENETRATIONS ARE NECESSARY CONTACT SEA FOR RECOMMENDATIONS.

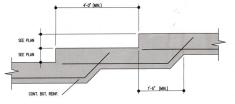

STEP FOOTING DETAIL




PROVIDE AT JAMBS, HEADS, & SILLS TYPICAL WINDOW BUCK

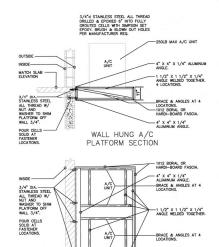

WALL HUNG A/C

PLATFORM PLAN VIEW

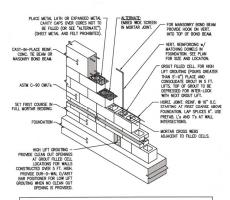

NOTES:

1). PROVIDE CLEAN OUTS IN LOW LIFT GROUTING IF MORTOR FINS AND DEBRIS IS EXCESSIVE.

2). FOR HIGH LIFT GROUTING, GROUT LIFT HEIGHT MAY BE INCREASED TO 12"-8" IF CONDITIONS ARE IN ACCORDANCE WITH ACI \$30-05 SUBSECTION 3.50 OF SPECIFICATIONS FOR MACKING YINDICURIES. ACCURATION IN THE ASSURED SUBSECTION ASSURED THE MEMORY FOR MASCRIFT STRUCTURES.


3). CONSCIDENTE AND RECONSCIDENTE GROUP FOUR BY MECHANICAL MERATION IN ACCORDANCE WITH ACL

530-05 SUBSECTION 3.55 OF SPECIFICATIONS FOR MASCRIFY STRUCTURES.

TYP. MASONRY WALL CONSTRUCTION

	SCHEDULE OF COMP	ONENTS AND CLADDING LOA	ADS	
ZONE	ZONE DESCRIPTION	TRIBUTARY AREA (SF)	( + PSF)	OUT (PRESSURE ( - PSF)
1	ROOF INTERIOR ZONE	LESS THAN 20 20 - 100 MORE THAN 100	22.37 20.73 15.79	35.53 33.90 32.25
2	ROOF, EDGE ZONE	LESS THAN 20 20 - 100 MORE THAN 100	22.37 20.73 15.79	61.86 56.92 45.40
	ROOF, OVERHANG, EDGE ZONE	LESS THAN 20 20 - 100 MORE THAN 100		78.31 78.31 78.31
3	ROOF, CORNER ZONE	LESS THAN 20 20 - 100 MORE THAN 100	22.37 20.73 15.79	91.46 85.87 71.72
3	ROOF, OVERHANG CORNER ZONE	LESS THAN 20 20 - 100 MORE THAN 100		127.66 114.50 88.16
4	WALL, INTERIOR ZONE	LESS THAN 20 20 - 100 MORE THAN 100	38.82 37.18 32.90	42.11 40.47 36.85
5	WALL, EDGE ZONE	LESS THAN 20 20 - 100 MORE THAN 100	38.82 37.18 32.90	51.99 48.69 40.47

NOTE: WIND PRESSURES SHOWN ARE BASED ON Vosd

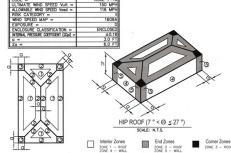

ABBREVIATIONS

O = AT

A.B. = ANCHOR BOLT

ALT. = ALTERNATE

APPROX. = APPROXIMA

ARCH. = ARCHITECT ARACH ARCHITCHINA
ARACH SOUTH ARCHITCHINA
BRU SEAN ARCHITCHINA
BRU SEAN ARCHITCHINA
BRU SEAN ARCHITCHINA
BRU SEAN
BRU SE

ISOLATION JOINT (IJ)

COLUMN SYMBOLS — INDICATES COLUMN BELOW - INDICATES COLUMN THRU — INDICATES COLUMN ABOVE



CONSTRUCTION JOINT (KJ)



CONTROL JOINT (CJ)

TOTAL 2 — ROOF SOURCE S

W = WITH
WD. = WOOD
WP = WORK POINT
W.W.F. = WELDED WRE FABRIC



Thomas F Winkler

Date: 2022.04.26 21:10:42

Plan no.

2021-36 S1.0

DR. 34228 RESIDENCE F DILLON MEXICO I 5950 GULF OF N LONGBOAT KEY, F PID: 789760008 CUSTOM R RENEE

BRAFTING ESIGN INC.

REVISIONS: NO. DESCRIP: BY DATE


DATE: 12-23-2021


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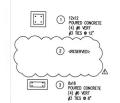
SHEET TITLE: STRUCTURAL NOTES AND TYPICAL DETAILS

SHEET NO. S1.0

\* THESE DRAWINGS ARE NOT TO BE SCALED. \*



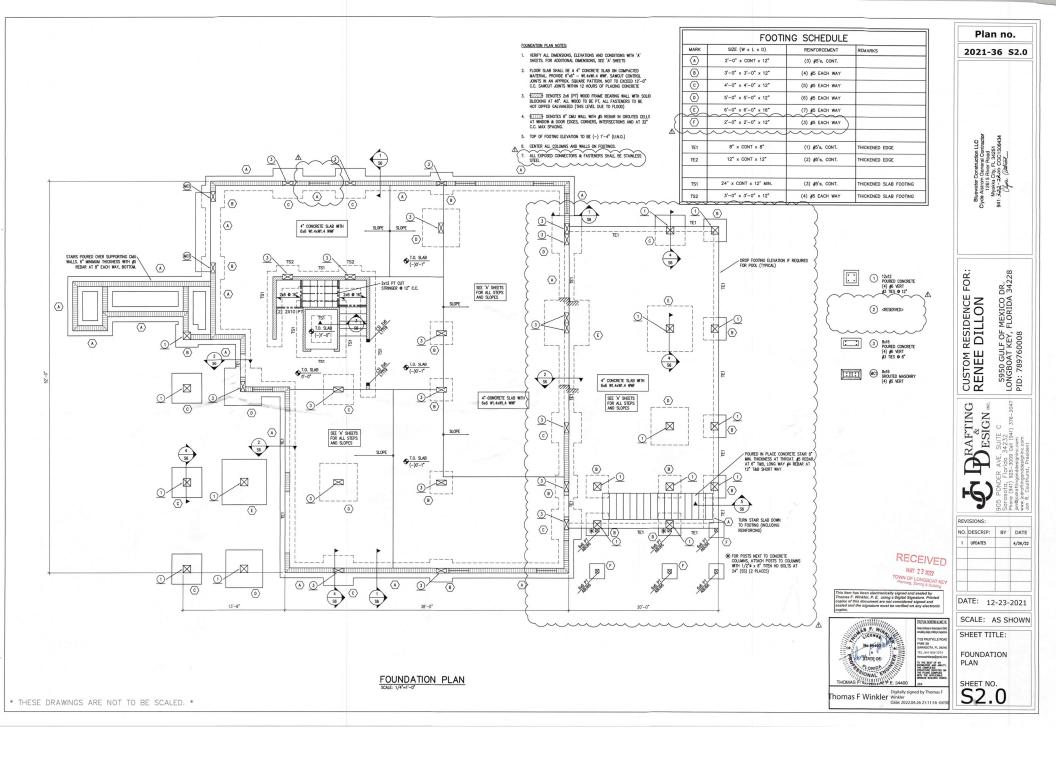

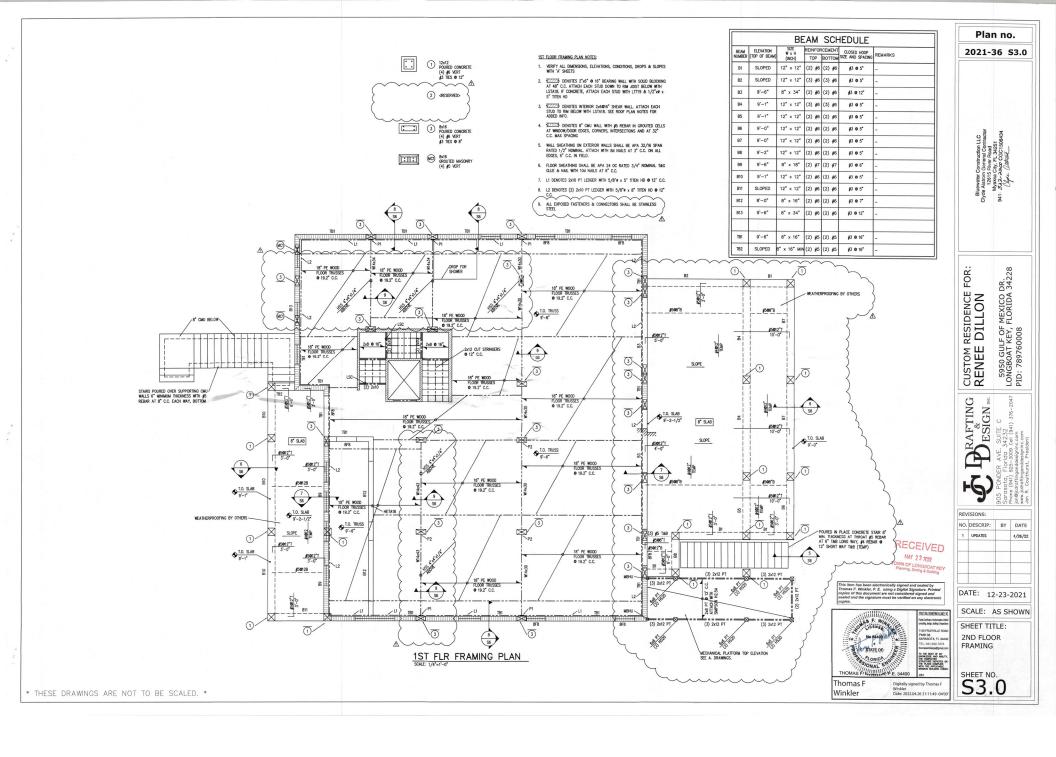

### Skife


GROUTED MASONRY

(4) #5 VERT

2ND FLOOR FRAMING PLAN NOTES:

- VERIFY ALL DIMENSIONS, ELEVATIONS, CONDITIONS, DROPS & SLOPES WITH 'A' SHEETS
- PROVIDE WATERPROOFING MEMBRANE ON ALL BALCONIES BY OTHERS DENOTES 8° CAIU WALL WITH 45 REMAR IN GROUTED CELLS

  AT WINDOW/DOOR EDGES, CORNERS, INTERSECTIONS AND AT 32°
  C.C. MAX SPACING
- WALL SHEATHING ON EXTERIOR WALLS SHALL BE APA 32/16 SPAN RATED 1/2" NOMINAL ATTACH WITH 8d NAILS AT 3" C.C. ON ALL EDGES, 6" C.C. IN FIELD.
- FLOOR SHEATHING SHALL BE APA 24 OC RATED 3/4" NOMINAL T&G GLUE & NAIL WITH 10d NAILS AT 6" C.C.
- 7. L1 DENOTES 2x10 PT LEDGER WITH 5/8"\$ x 5" TITEN HD @ 12" C.C.
- 8. L2 DENOTES (2) 2x10 PT LEDGER WITH 5/8" x 8" TITEN HD @ 12"

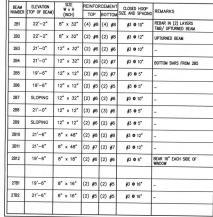

BEAM SCHEDULE

FOR BEAMS DEEPER THAN 24", ADD (1) #5 EACH FACE AT 12" C.C.

CUSTOM RESIDENCE FOR: RENEE DILLON

5950 GULF OF MEXICO DR. LONGBOAT KEY, FLORIDA 34228 PID: 789760008 PRAFTING ESIGN INC.

Plan no.

2021-36 S4.0

REVISIONS:


NO. DESCRIP: BY DATE 1 UPDATES 4/26/22

DATE: 12-23-2021

SCALE: AS SHOWN STRUTURE DIGHERMS ALLANCE, NO SHEET TITLE:

SECOND FLOOR FRAMING PLAN

SHEET NO. S4.0

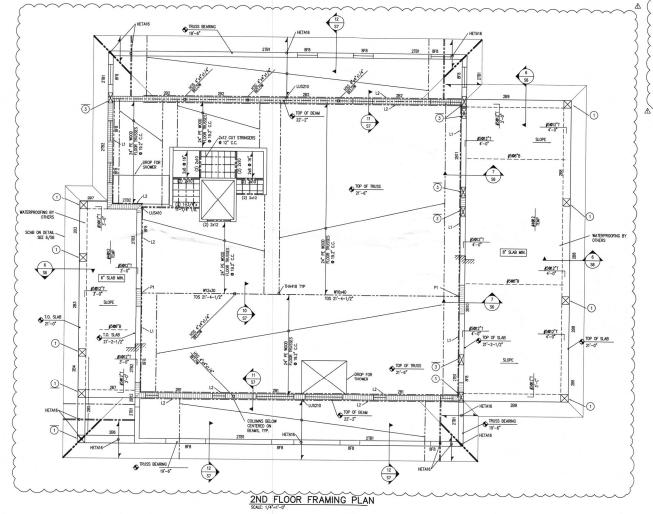

RECEIVED MAY 23 2022

A 1111 - F. 691/2.
AS F. WINATIA
OLICENS
No 84400 m
TATE OF
A CORIDA A
SIONAL ENGLIS
THOMAS F: 4-11111111 P.E. 54400

Thomas F Winkler Digitally signed by Thomas F Winkler Winkler Date: 2022.04.26 21:12:16-04

\* THESE DRAWINGS ARE NOT TO BE SCALED. \*

12x12 POURED CONCRETE (4) #6 VERT #3 TIES © 12" 2 12x20
POURED CONCRETE
(6) #6 VERT
#3 TIES © 12" 3 8x16
POURED CONCRETE
(4) #6 VERT
#3 TIES • 8"

ROOF FRAMING PLAN

8x16 GROUTED MASONRY (4) #5 VERT

):11:(

ROOF FRAMING PLAN NOTES:

- 1. VERIFY ALL DIMENSIONS, ELEVATIONS, CONDITIONS, DROPS & SLOPES WITH 'A' SHEETS
- ROOF SHEATHING SHALL BE APA 32/16 SPAN RATED 5/8" NOMINAL ATTACH WITH 10d NAILS AT 3"C.C. ON SUPPORTED EDGES, 6" C.C. IN FIELD
- 3. WALL SHEATHING SHALL BE APA 32/16 SPAN RATED 1/2" NOMINAL ATTACH WITH 8d NAILS AT 3" C.C. ALL EDGES (BLOCKED) AND 6" C.C. IN FIELD 4. TYPICAL ROOF TRUSS CONNECTOR SHALL BE HETA16 U.N.O.

		BE	EAM	SCH	HEDULE	
BEAM NUMBER	ELEVATION (TOP OF BEAM)	SIZE W x H (INCH)	REINFOR		CLOSED HOOP SIZE AND SPACING	REMARKS
RTB1	30'-10-3/4"	8" x 16"	(2) #5	(2) #5	<b>₽</b> 3 <b>0</b> 16°	-
RB1	30'-10-3/4"	8" x 16"	(2) #5	(2) #5	#3 <b>0</b> 7*	-
RB2	30'-10-3/4"	8" x 16"	(2) #6	(2) #6	<b>€3 9</b> 7"	

Plan no.

2021-36 S5.0

CUSTOM RESIDENCE FOR: RENEE DILLON LES950 GULF OF MEXICO DR. LONGBOAT KEY, FLORIDA 34228 PID: 789760008

BRAFTING ESIGN INC.

REVISIONS: NO. DESCRIP: DATE 4/26/22

DATE: 12-23-2021

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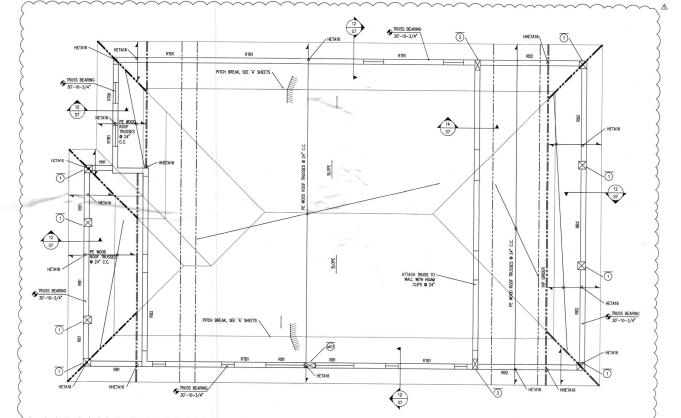
HIGH ROOF

S5.0

FRAMING PLAN SHEET NO.

TO THE BEST OF MY KNOWLEDGE AND ABILIT THE COMPLETED STRUCTURE COPICED OTHER PLANS COMPLET WITH THE APPLICABLE MINIMUM BUILDING COOK

Digitally signed by Thoma Winkler Date: 2022.04.26 21:12:45




RECEIVED MAY 23 2022 TOWN OF LONGBOAT KEY Planning, Zoning & Building


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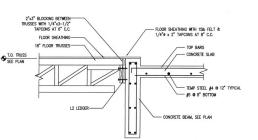


Thomas F Winkler


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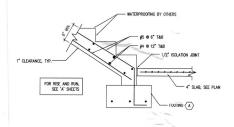




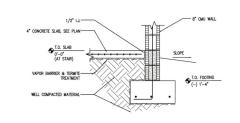


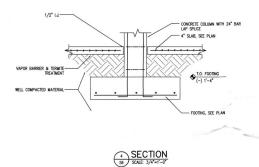




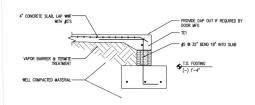




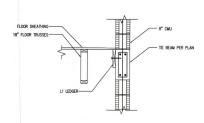




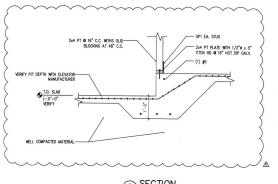

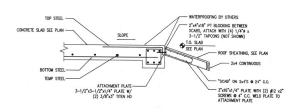



9 SECTION S8 SCALE: 3/4"=1'-0"

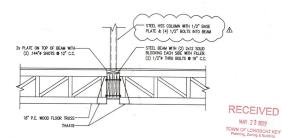



Thomas F Winkler

Digitally signed by Thor F Winkler Date: 2022 04 26 21:13:13

**DETAILS** 

S6.0

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Plan no. 2021-36 S6.0


CUSTOM RESIDENCE FOR: RENEE DILLON MEXICO DR. FLORIDA 34228 5950 GULF OF N LONGBOAT KEY, F PID: 789760008


PRAFTING ESIGN INC. REVISIONS:


4/26/22

DATE: 12-23-2021


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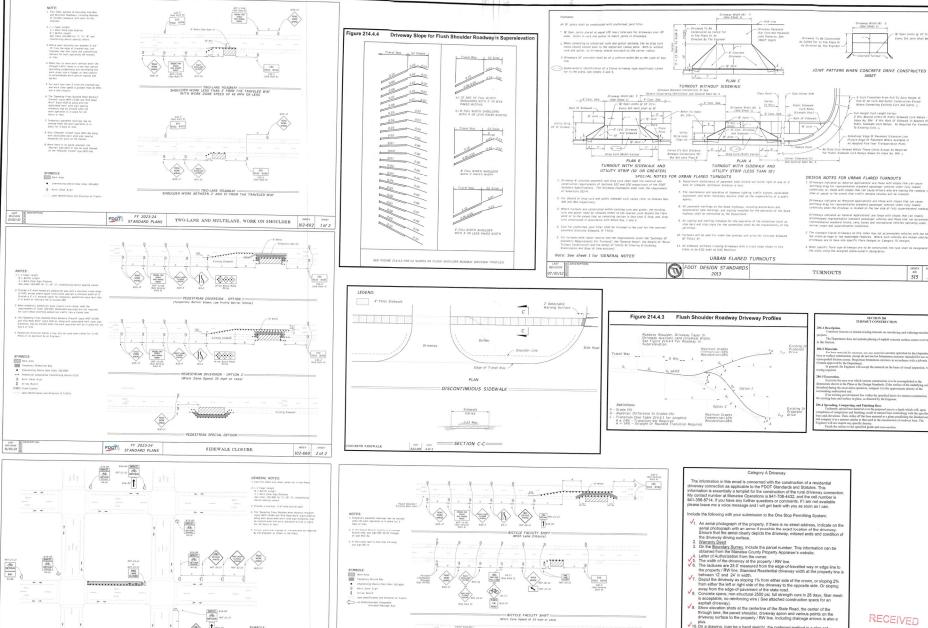


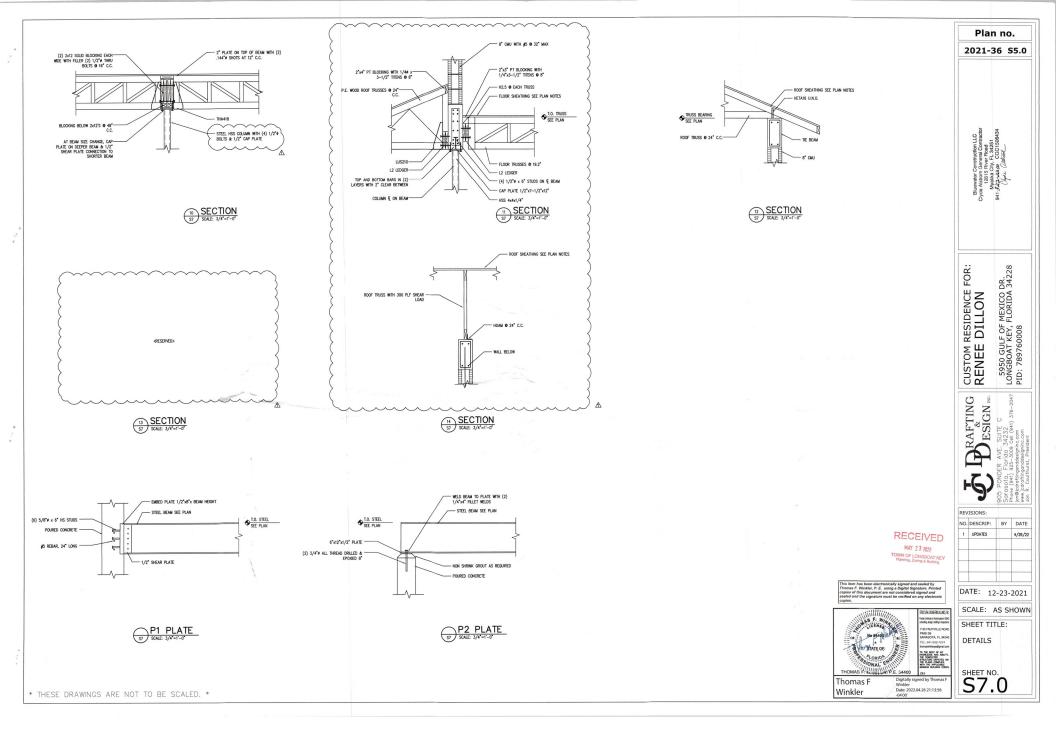

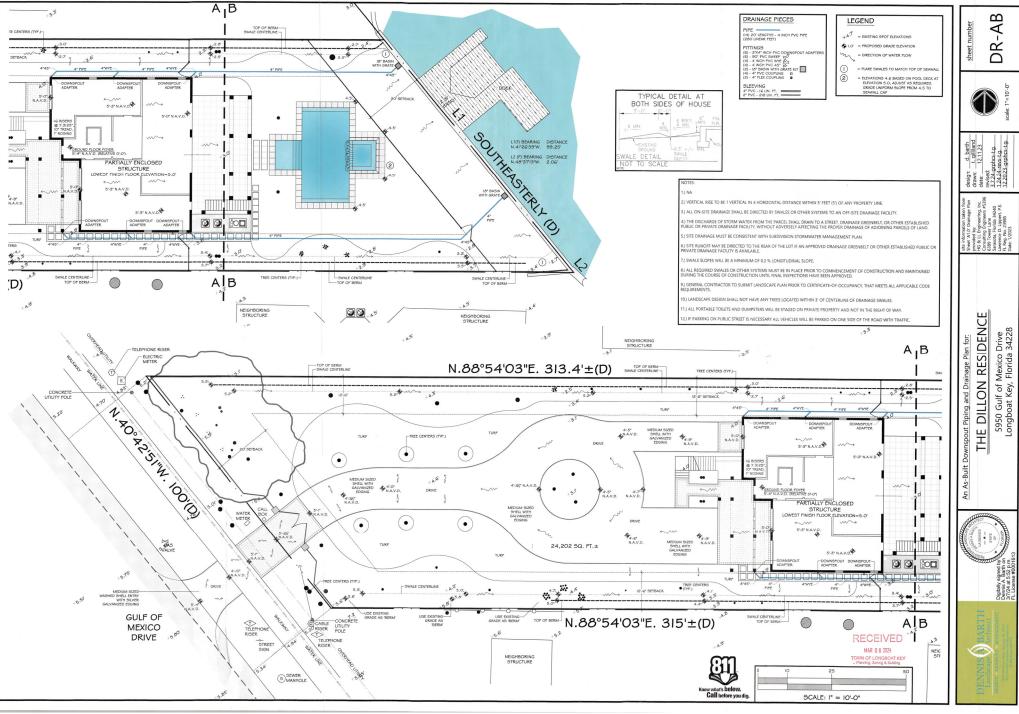

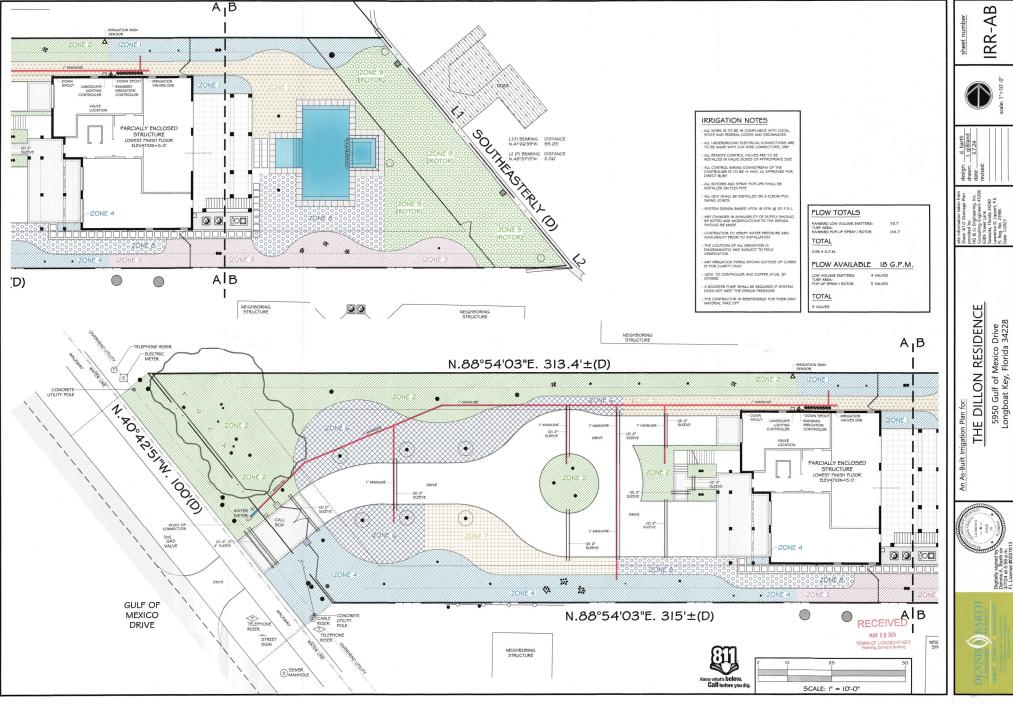



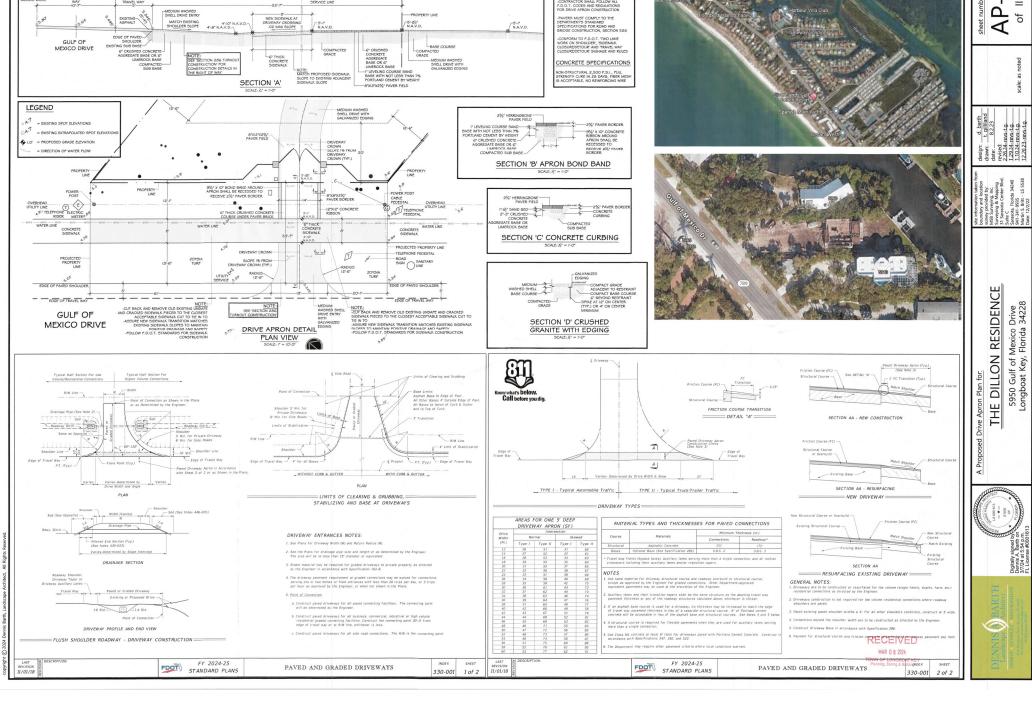

Faved Shoulder/ Existing Bike Lane

dip orrown AMEAG

FDOT FY 2023-24 STANDARD PLANS

102-661 1 of 2

BICYCLE FACILITY CLOSURES

FY 2023-24 STANDARD PLANS

MA-OX (NA-OX (NA-OX METOR TO MET

BICYCLE FACILITY CLOSURES

10. On a drawing, (can be a hand sketch), the preferred method is a plan set depicting the driveway and drainage and its dimensions. Include a cross-set of the driveway, a profile view and label the different layers, see example included.

✓ 11. Include the FDOT FY 2022 – 2023 Standard Plans

Thank you Tim Long Permit Coordinator I Manatee Operations Vernon long@dot state fl.us Cell 941-356-8714

102-661 2 of 2

NOTE: CHECKED ITEMS INCLUDED WITHIN THE I/30/24 AP-I AND AP-II REVISIONS V

RECEIVED MAR 0 8 2024



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Driveway Wisth (W) ( (See Sheet 1)

NO. NO. 515 2

RESIDENCE

5950 Gulf of Mexico Drive Longboat Key, Florida 34228 **DILLON** THE

Plan Sheet II for:

Drive Apron

A Proposed





# THE DILLON RESIDENCE

5950 GULF OF MEXICO DRIVE Longboat Key, Florida 34228 Dated: 3/7/24

## INDEX


SHEET	DESCRIPTION
L5	Landscape
L52	Landscape Plant List
HS	Hardscape
L	Lighting
DR	———— Drainage
IRR	Irrigation
AP-I	Apron Details-I
AP-II	Apron Details-II

RECEIVED MAR 0 8 2024 TOWN OF LONGBOAT KEY
Planning, Zoning & Building



4370 Woodview Drive phone: 941.374.8304 fax: 941.488.6236

DennisBarthLA@GMail.com FL RLA License #0001613

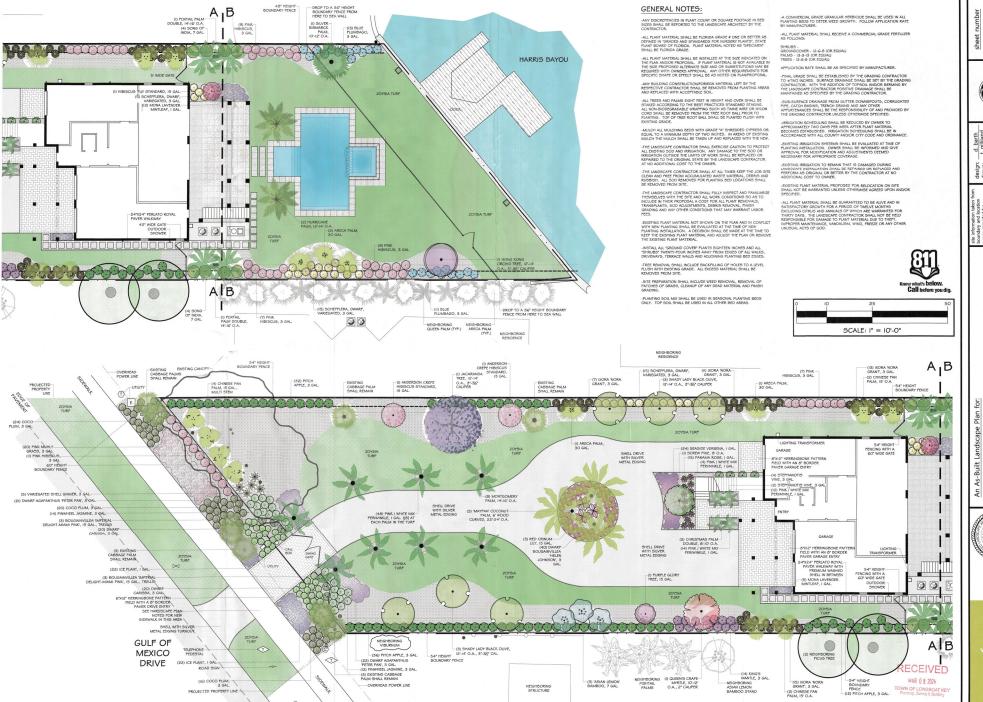

B ⋖ Ś

revs-tg. revs-tg. revs-tg.

site information taken boundary and location survey provided by: MSB Surveying, Inc. Surveying & Mapping 31 Sansota Center Bh Suite C Sursota, Florida 3424 941-341-9938 Martin S Britz - 5 55.

DILLON RESIDENCE Drive 34228 5950 Gulf of Mexico Longboat Key, Florida

TE

Digitally signed by Dennis A. Barth of 3/7/24 at 5:34 p.n.

	CHEDULE CO		
	CC3 78	PINK AND WHITE MIX PERIWINKLE / CATHARANTHUS ROSEUS	I GAL.
	AP 43	DWARF AGAPANTHUS 'PETER PAN' / AGAPANTHUS AFRICANUS DWARF 'PETER PAN'	3 GAL
TURF	QTY	TYPE	
	9,200 SQ. FT. (23 PALLETS)	EMPIRE ZOYSIA	
MULCH	QTY	TYPE	
	8,800 SQ. FT. (80 YARDS)	GRADE 'A' CYPRESS (OPTION 2: COCO BROWN MULCH)	
TOPSOIL	QTY	TYPE	
	8,800 SQ. FT. (80 YARDS)	PLANTING MIX	
AGGREGATE	QTY	TYPE	
WALK AREA	IIO 9Q. FT. (ACTUAL)	PREMIUM WASHED SHELL	
DRIVE	4,018 SQ.FT. (ACTUAL)	MEDIUM SIZED SHELL MEDIUM SIZED WASHED SHELL	
EDGING	QTY	TYPE	
WALK AND DRIVE	548 LIN. FT.	SILVER GALVANIZED	

MAR 0 8 2024




.S2-AB


THE DILLON RESIDENCE 5950 Gulf of Mexico Drive Longboat Key, Florida 34228



**⊘** 

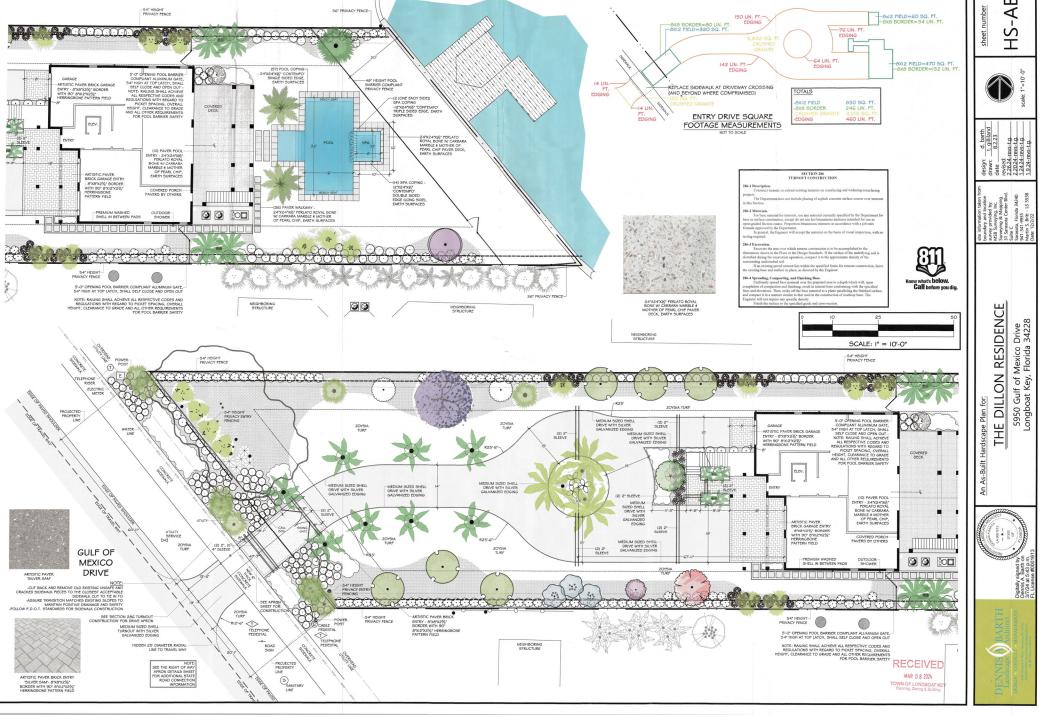

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5950 Gulf of Mexico Drive Longboat Key, Florida 34228

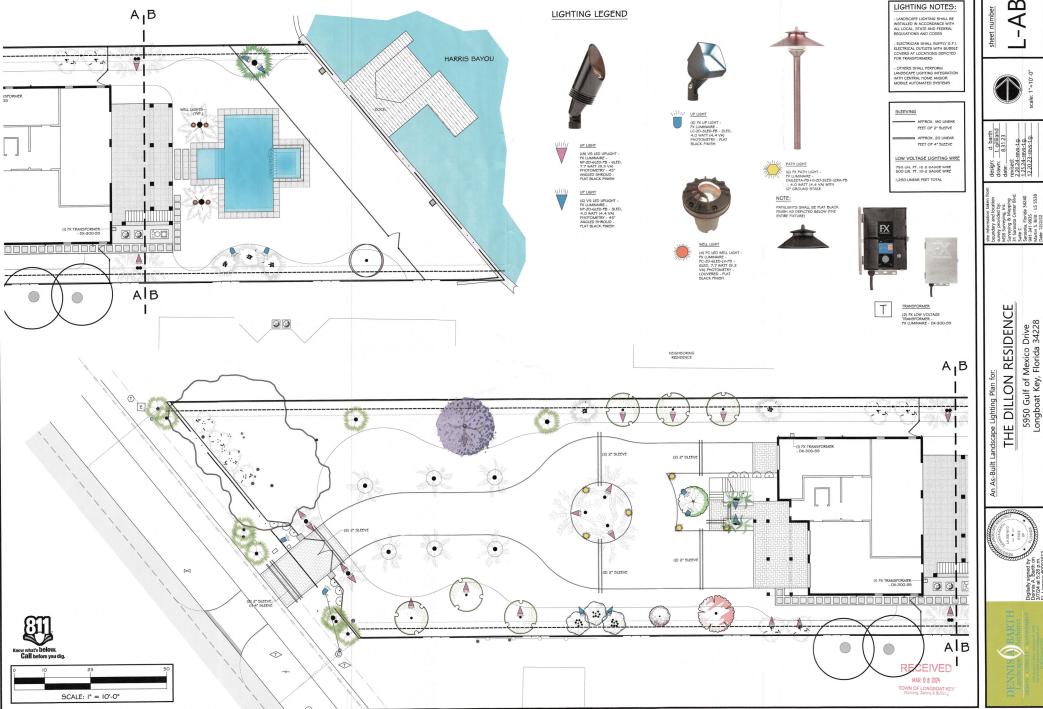Digitally signed by E Dennis A. Barth on 3/7/24 at 5:28 p.m. FL License #0001611

