

A NEW CUSTOM RESIDENCE FOR

ANTHONY & VICKI SKIDMORE

608 Bayview Drive | Longboat Key, Florida | 34228
Manatee County



BUILD PERMIT PLANS
FILE
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NPDES

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Permit # **AB21-0839**
REVIEWED FOR CODE COMPLIANCE
LONGBOAT KEY BUILDING DEPT.

AUG 20 2021

Reviewer: **APPROVED**
MATT PAGE

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GENERAL NOTES	EROSION & SEDIMENT CONTROL NOTES	TYPICAL ABBREVIATIONS	DRAWING SHEET INDEX																																																												
<p>1. DRAWINGS DO NOT SCALE THESE DRAWINGS. WRITTEN DIMENSIONS AND NOTES SHALL CONTROL. CONTACT THE SUPERINTENDENT WITH ANY CONFLICTS IN THE PLANS BEFORE BEGINNING WORK. UNLESS OTHERWISE SPECIFIED, ALL DIMENSIONS ARE TO STRUCTURAL ITEMS AND DO NOT INCLUDE FINISHES, DIMENSIONS, SIZES, MEASUREMENTS AND LOCATION INSTRUCTIONS ARE NOMINAL AND APPROXIMATE AND MAY VARY FROM WHAT IS SPECIFIED OR REQUIRED.</p> <p>2. ON-SITE VERIFICATION: OF ALL DIMENSIONS AND CONDITIONS SHALL BE THE RESPONSIBILITY OF THE SUB-CONTRACTOR. EACH SUB-CONTRACTOR SHALL REPORT ANY DISCREPANCY OR OTHER QUESTIONS PERTAINING TO THE DRAWINGS TO THE JOHN CANNON HOMES, INC. SUPERINTENDENT, OTHERWISE ACCEPTING FULL RESPONSIBILITY FOR ANY ERRORS, OMISSIONS & DISCREPANCIES TO PLANS AS NOTED.</p> <p>3. APPLICABLE CODES: IT IS THE INTENT THAT THESE DRAWINGS BE IN CONFORMANCE WITH THE 2020 FBC, 2017 IRC AND ALL APPLICABLE LOCAL, COUNTY, STATE AND FEDERAL CODES, ORDINANCES, LAWS, REGULATIONS AND RESTRICTIVE COVENANTS GOVERNING THE SITE.</p> <p>4. SCOPE OF WORK: ALL TRADES SHALL FURNISH ALL LABOR, EQUIPMENT, AND MATERIALS, AND SHALL PERFORM ALL WORK NECESSARY, INCLUDING, REASONABLY INFERRED OR REQUIRED BY ANY CODE WITHIN THE RELEVANT JURISDICTION(S) GOVERNING THE SITE TO COMPLETE THEIR SCOPE OF WORK.</p> <p>5. MATERIALS: ALL MATERIALS SHALL BE INSTALLED PER MANUFACTURERS SPECIFICATIONS.</p> <p>6. CEILING HEIGHTS: MAY BE ADJUSTED AS REQUIRED FOR STRUCTURAL ENGINEERING OR MECHANICAL EQUIPMENT.</p> <p>7. CABINET DRAWINGS: CONTAINED HEREIN ARE FOR SCHEMATIC LAYOUT ONLY, AS SUCH ALL DIMENSIONS AND LOCATIONS ARE APPROXIMATE. CABINETS ARE TO BE BUILT AND INSTALLED PER APPROVED CABINET DRAWINGS AS SUPPORTED BY CONTRACT DOCUMENTATION.</p>	<p>1. WHEN RAINFALL AND RUNOFF OCCURS, DAILY INSPECTIONS OF THE EROSION AND SEDIMENT CONTROLS AND DISCHARGE OUTFALLS MUST BE PROVIDED BY SOMEONE KNOWLEDGEABLE AND EXPERIENCED IN THE PRINCIPLES, PRACTICES, INSTALLATION, AND MAINTENANCE OF EROSION AND SEDIMENT CONTROLS WHO WORKS FOR THE PERMITTEE.</p> <p>2. DURING WET WEATHER PERIOD, TEMPORARY STABILIZATION OF THE SITE MUST OCCUR AT THE END OF EACH WORK DAY.</p> <p>3. SEDIMENT CONTROLS MUST BE INSTALLED AND MAINTAINED ON ALL DOWN GRADIENT SIDES OF THE CONSTRUCTION SITE AT ALL TIMES DURING CONSTRUCTION. THEY MUST REMAIN IN PLACE UNTIL PERMANENT VEGETATION OR OTHER PERMANENT COVERING OF EXPOSED SOIL IS ESTABLISHED.</p> <p>4. ALL ACTIVE INLETS MUST HAVE SEDIMENT CONTROLS INSTALLED AND MAINTAINED AT ALL TIMES DURING CONSTRUCTION, UNLESS OTHERWISE APPROVED. A SURFACE MOUNTED AND ATTACHABLE, U-SHAPED FILTER BAG IS REQUIRED FOR ALL CURB INLET CATCH BASINS.</p> <p>5. SIGNIFICANT AMOUNTS OF SEDIMENT WHICH LEAVES THE SITE MUST BE CLEANED UP WITHIN 24 HOURS AND PLACED BACK ON THE SITE AND STABILIZED OR PROPERLY DISPOSED. THE CAUSE OF THE SEDIMENT RELEASE MUST BE FOUND AND PREVENTED FROM CAUSING A REOCCURRENCE OF THE DISCHARGE WITHIN THE SAME 24 HOURS.</p> <p>6. SEDIMENT MUST NOT BE INTENTIONALLY WASHED INTO STORM SEWERS, DRAINAGE WAYS, OR WATER BODIES.</p> <p>7. SEDIMENT MUST BE REMOVED FROM BEHIND ALL SEDIMENT CONTROL MEASURES WHEN IT HAS REACHED A HEIGHT OF ONE-THIRD OF THE BARRIER HEIGHT, AND PRIOR TO THE CONTROL MEASURES REMOVAL.</p> <p>8. CLEANING OF ALL STRUCTURES WITH SUMPUS MUST OCCUR WHEN THE SEDIMENT RETENTION CAPACITY HAS BEEN REDUCED BY 50% AND AGAIN AT COMPLETION OF PROJECT.</p> <p>9. ANY USE OF TOXIC OR OTHER HAZARDOUS MATERIALS MUST INCLUDE PROPER STORAGE, APPLICATION, AND DISPOSAL. THE PERMITTEE MUST PROPERLY MANAGE HAZARDOUS WASTES, USED OILS, CONTAMINATED SOILS, CONCRETE WASTE, SANITARY WASTE, LIQUID WASTE, OR OTHER TOXIC SUBSTANCES DISCOVERED OR GENERATED DURING CONSTRUCTION.</p> <p>10. THE APPLICATION RATE OF FERTILIZERS USED TO REESTABLISH VEGETATION MUST FOLLOW MANUFACTURERS' RECOMMENDATIONS. NUTRIENT RELEASES FROM FERTILIZERS TO SURFACE WATERS MUST BE MINIMIZED. TIME RELEASE FERTILIZERS SHOULD BE USED AND CARE SHOULD BE TAKEN IN APPLICATION OF FERTILIZERS WITHIN ANY WATER WAY RIPARIAN ZONE.</p> <p>11. OWNER OR DESIGNATED PERSON SHALL BE RESPONSIBLE FOR PROPER INSTALLATION AND MAINTENANCE OF ALL EROSION AND SEDIMENT CONTROL MEASURES IN ACCORDANCE WITH CURRENT CLEAN WATER SERVICES STANDARDS, STATE, AND FEDERAL REGULATIONS.</p> <p>12. PRIOR TO ANY LAND DISTURBING ACTIVITIES, THE BOUNDARIES OF THE CLEARING LIMITS, VEGETATED BUFFERS, AND ANY SENSITIVE AREAS SHOWN ON THE PLAN SHALL BE CLEARLY DELINEATED IN THE FIELD. UNLESS OTHERWISE APPROVED, NO DISTURBANCE IS PERMITTED BEYOND THE CLEARING LIMITS. THE OWNER/PERMITTEE MUST MAINTAIN THE DELINEATION FOR THE DURATION OF THE PROJECT. NOTE: VEGETATED CORRIDORS TO BE DELINEATED WITH ORANGE CONSTRUCTION FENCE OR APPROVED EQUAL.</p> <p>13. PRIOR TO ANY LAND DISTURBING ACTIVITIES, THE BMPs THAT MUST BE INSTALLED INCLUDE: GRAVEL CONSTRUCTION ENTRANCE, PERIMETER SEDIMENT CONTROL, AND INLET PROTECTION. THESE BMPs MUST BE MAINTAINED FOR THE DURATION OF THE PROJECT.</p> <p>14. IF VEGETATIVE SEED MIXES ARE SPECIFIED, SEEDING MUST TAKE PLACE NO LATER THAN SEPTEMBER 1ST; THE TYPE AND PERCENTAGES OF SEED IN THE MIX ARE AS IDENTIFIED ON THE PLANS OR AS SPECIFIED BY THE DESIGN ENGINEER.</p> <p>15. ALL FLOWING OF SEDIMENT LADEN WATER MUST BE DISCHARGED OVER AN UNDISTURBED, PREFERABLY VEGETATED AREA, AND THROUGH A SEDIMENT CONTROL BMP (I.E. FILTER BAG).</p> <p>16. THE ESC PLAN MUST BE KEPT ON-SITE. ALL MEASURES SHOWN ON THE PLAN MUST BE INSTALLED PROPERLY TO ENSURE THAT SEDIMENT LADEN WATER DOES NOT ENTER A SURFACE WATER SYSTEM, ROADWAY, OR OTHER PROPERTIES.</p> <p>17. ALL ESC MEASURES SHOWN ON THIS PLAN ARE THE MINIMUM REQUIREMENTS FOR ANTICIPATED SITE CONDITIONS. DURING THE CONSTRUCTION PERIOD, THESE MEASURES SHALL BE UPGRADDED AS NEEDED TO MAINTAIN COMPLIANCE WITH ALL REGULATIONS.</p> <p>18. IN AREAS SUBJECT TO WIND EROSION, APPROPRIATE BMPs MUST BE USED WHICH MAY INCLUDE THE APPLICATION OF FINE WATER SPRAYING.</p>	<p>THIS LIST CONTAINS GENERAL ABBREVIATIONS WHICH MAY BE USED THROUGHOUT THIS PROJECT. ADDITIONAL ABBREVIATIONS AND SYMBOLS CAN BE FOUND WITHIN THE RELEVANT SHEETS' LEGEND AND/OR NOTES.</p> <table border="0"> <tr> <td>ABV ABOVE</td> <td>CP CROWN PERMITS</td> <td>HR HOSE BIBB</td> <td>REF REFRIGERATOR</td> </tr> <tr> <td>AFT ABOVE FINISHED FLOOR</td> <td>DPE DESIGN FLOOD ELEVATION</td> <td>LAV LAVATORY</td> <td>SGD SLIDING GLASS DOOR</td> </tr> <tr> <td>AHU AIR HANDLER UNIT</td> <td>DC DISAPPEARING CORNER</td> <td>MFG MANUFACTURER</td> <td>SF SQUARE FEET (FOOT)</td> </tr> <tr> <td>ALUM ALUMINUM</td> <td>DSP DISPOSAL</td> <td>WAK WALKWAY</td> <td>S SQUARE INCHES</td> </tr> <tr> <td>ARCH ARCHITECTURAL</td> <td>DST DISTANCE</td> <td>MECH MECHANICAL</td> <td>SHR SHOWER</td> </tr> <tr> <td>BFE BASE FLOOD ELEVATION</td> <td>ELEC ELECTRICAL</td> <td>MIN MINIMUM</td> <td>SH SINKING WINDOW</td> </tr> <tr> <td>BDD BUILDING</td> <td>ELY ELEVATION</td> <td>MIR MIRROR</td> <td>SPCS SPECIFICATIONS</td> </tr> <tr> <td>CA CABINET</td> <td>ENG ENGINEER</td> <td>NAV NORTH AMERICAN</td> <td>STRUC STRUCTURAL</td> </tr> <tr> <td>CALC CALCULATIONS</td> <td>EQUIP EQUIPMENT</td> <td>VERT VERTICAL</td> <td>T&G TONGUE AND GROOVE</td> </tr> <tr> <td>CA CASEMENT WINDOW</td> <td>FF FINISHED FLOOR</td> <td>NGVD NATIONAL GEODESIC</td> <td>TYP TYPICAL</td> </tr> <tr> <td>CA## CONTRACT FIRMATION</td> <td>FG FROST GLASS</td> <td>VERT VERTICAL DATUM</td> <td>UC UNDER COUNTER</td> </tr> <tr> <td>CA## CUSTOMER ACCOMMODATION</td> <td>FR FLOOR</td> <td>OC ON CENTER</td> <td>VEE VESTIBULE</td> </tr> <tr> <td>CLG CEILING</td> <td>FR DR FRENCH DOOR</td> <td>CHD OVERHEAD DOOR</td> <td>WC WATER CLOSET</td> </tr> <tr> <td>CMU CONCRETE MASONRY UNIT</td> <td>HDR HEADER</td> <td>PET FOCKET DOOR</td> <td>WH WATER HEATER</td> </tr> <tr> <td>CONC CONCRETE</td> <td>HVAC HEAT & AIR CONDITIONING</td> <td>RA ROOM AREA</td> <td>WC WALK IN CLOSET</td> </tr> </table>	ABV ABOVE	CP CROWN PERMITS	HR HOSE BIBB	REF REFRIGERATOR	AFT ABOVE FINISHED FLOOR	DPE DESIGN FLOOD ELEVATION	LAV LAVATORY	SGD SLIDING GLASS DOOR	AHU AIR HANDLER UNIT	DC DISAPPEARING CORNER	MFG MANUFACTURER	SF SQUARE FEET (FOOT)	ALUM ALUMINUM	DSP DISPOSAL	WAK WALKWAY	S SQUARE INCHES	ARCH ARCHITECTURAL	DST DISTANCE	MECH MECHANICAL	SHR SHOWER	BFE BASE FLOOD ELEVATION	ELEC ELECTRICAL	MIN MINIMUM	SH SINKING WINDOW	BDD BUILDING	ELY ELEVATION	MIR MIRROR	SPCS SPECIFICATIONS	CA CABINET	ENG ENGINEER	NAV NORTH AMERICAN	STRUC STRUCTURAL	CALC CALCULATIONS	EQUIP EQUIPMENT	VERT VERTICAL	T&G TONGUE AND GROOVE	CA CASEMENT WINDOW	FF FINISHED FLOOR	NGVD NATIONAL GEODESIC	TYP TYPICAL	CA## CONTRACT FIRMATION	FG FROST GLASS	VERT VERTICAL DATUM	UC UNDER COUNTER	CA## CUSTOMER ACCOMMODATION	FR FLOOR	OC ON CENTER	VEE VESTIBULE	CLG CEILING	FR DR FRENCH DOOR	CHD OVERHEAD DOOR	WC WATER CLOSET	CMU CONCRETE MASONRY UNIT	HDR HEADER	PET FOCKET DOOR	WH WATER HEATER	CONC CONCRETE	HVAC HEAT & AIR CONDITIONING	RA ROOM AREA	WC WALK IN CLOSET	<p>A0.0 COVER SHEET</p> <p>A1.0 SITE AND DRAINAGE PLAN</p> <p>A2.0 GROUND LEVEL FLOOR PLAN</p> <p>A2.0d GROUND LEVEL DIMENSION PLAN</p> <p>A2.1 MAIN LEVEL FLOOR PLAN</p> <p>A2.1d MAIN LEVEL DIMENSION PLAN</p> <p>A2.2 UPPER LEVEL FLOOR PLAN</p> <p>A2.2d UPPER LEVEL DIMENSION PLAN</p> <p>A3.0 ROOF PLAN</p> <p>A4.0 EXTERIOR ELEVATIONS (FRONT & REAR)</p> <p>A4.1 EXTERIOR ELEVATIONS (SIDES)</p> <p>A5.0 INTERIOR ELEVATIONS</p> <p>A6.0 GROUND LEVEL ELECTRICAL PLAN</p> <p>A6.1 MAIN LEVEL ELECTRICAL PLAN</p> <p>A6.2 UPPER LEVEL ELECTRICAL PLAN</p> <p>A7.0 SCHEDULES & NOTES</p> <p>D1.0 INTERIOR DETAILS</p> <p>D2.0 EXTERIOR DETAILS</p> <p>S1 FOUNDATION PLAN</p> <p>S1.1 FOUNDATION DETAILS</p> <p>S2 GROUND LEVEL STRUCTURAL PLAN</p> <p>S2.1 MAIN LEVEL STRUCTURAL PLAN</p> <p>S2.2 UPPER LEVEL STRUCTURAL PLAN</p> <p>S3 MAIN LEVEL FRAMING PLAN</p> <p>S3.1 UPPER LEVEL FRAMING PLAN</p> <p>S3.2 ROOF FRAMING PLAN</p> <p>S4 STRUCTURAL NOTES/SPECS</p> <p>S5 STRUCTURAL DETAILS</p> <p>S6 STRUCTURAL DETAILS</p> <p>S7 STRUCTURAL DETAILS</p> <p>S8 STRUCTURAL DETAILS</p>
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<p>DESIGN DISCLOSURE</p> <p>THE PURPOSE OF THIS DISCLOSURE IS TO ACKNOWLEDGE THAT JOHN CANNON HOMES, INC. DESIGNS BUILDING PLANS FOR ITS CUSTOMERS FOR THE PURPOSE OF CONSTRUCTING THEIR HOME, AND MAKES NO CLAIMS AS TO REPRESENTING ITSELF AS AN ARCHITECT OR EXPERT IN THE FUNCTIONAL UTILITY OF HOUSE DESIGN. IN AS SUCH NO REPRESENTATIONS ARE MADE AS TO THE AESTHETIC OR FUNCTIONALITY OF THE HOUSE'S OVERALL DESIGN AND LAYOUT. YOUR CONTRACT AND THESE PLANS ARE CUSTOM, ALTHOUGH THEY MAY BE BASED UPON A JOHN CANNON HOMES MODEL. THESE PLANS WILL BE USED AS DRAWING FOR CONSTRUCTION PURPOSES; PLEASE REVIEW THEM CAREFULLY. THERE MAY BE DESIGN CHANGES, ADDITIONS, DELETIONS, SUBSTITUTIONS, DEVIATIONS AND / OR ALTERATIONS FROM WHAT IS SHOWN IN OUR MODELS OR YOUR PLANS SIGNED AT CONTRACT. JOHN CANNON HOMES, INC. FULLY REPRESENTS THE DESIGN OF THE HOUSE'S STRUCTURAL INTEGRITY TO BE IN ACCORDANCE WITH APPLICABLE BUILDING CODES AND GOVERNMENTAL REQUIREMENTS. THESE COPYRIGHTED PLANS ARE THE PROPERTY OF JOHN CANNON HOMES, INC. IN SO MUCH AS ANY UNAUTHORIZED USE, DUPLICATION, OR DISTRIBUTION IS STRICTLY PROHIBITED WITHOUT WRITTEN PERMISSION FROM JOHN CANNON HOMES, INC. IT IS SUGGESTED THAT ANY CUSTOMER HAVING QUESTIONS OR CONCERNS REGARDING THE FUNCTIONAL UTILITY OF THE HOUSE'S DESIGN AND / OR LAYOUT (I.E. ROOM LAYOUT, SIZE AND / OR CONFIGURATION, DOOR AND WINDOW LOCATIONS, ETC.) TO CONTACT AN ARCHITECT OR SIMILAR EXPERT IN THE FIELD OF HOUSE DESIGN AND LAYOUT TO ASSIST THEM IN RESOLVING THOSE QUESTIONS OR CONCERNS. ANY COSTS INCURRED IN OBTAINING THIS ASSISTANCE ARE THE SOLE RESPONSIBILITY OF THE CUSTOMER, AND ADDITIONAL COSTS COULD BE INCURRED SHOULD CHANGES TO THE BUILDING PLANS BE REQUESTED. FURTHERMORE, THESE PLANS ARE A GRAPHIC REPRESENTATION OF THE PRELIMINARY DESIGN OF A HOUSE. ACTUAL PLACEMENT OF THE HOUSE ON THE LOT, ROOM SIZES, WINDOW SIZES AND PLACEMENT, DOOR SIZES AND PLACEMENT, EQUIPMENT LOCATIONS AND OTHER ITEMS MAY CHANGE AS REQUIRED BY BUILDING CODES, LOCAL ORDINANCES, AND STRUCTURAL REQUIREMENTS AFTER ENGINEERING.</p>	<p>AREA CALCULATIONS</p> <table border="1"> <tr> <td>BUILDING AREAS</td> <td></td> </tr> <tr> <td>GROUND LEVEL FOYER</td> <td>286 SQ FT</td> </tr> <tr> <td>MAIN LIVING LEVEL</td> <td>1,752 SQ FT</td> </tr> <tr> <td>SECOND LIVING LEVEL</td> <td>1,371 SQ FT</td> </tr> <tr> <td>TOTAL LIVING(UNDER A/C)</td> <td>3,416 SQ FT</td> </tr> <tr> <td>ENTRY</td> <td>59 SQ FT</td> </tr> <tr> <td>LOWER LANAI</td> <td>959 SQ FT</td> </tr> <tr> <td>GARAGE / STORAGE</td> <td>1,373 SQ FT</td> </tr> <tr> <td>MAIN LIVING BALCONY</td> <td>47 SQ FT</td> </tr> <tr> <td>MAIN LANAI</td> <td>708 SQ FT</td> </tr> <tr> <td>UPPER BALCONY</td> <td>47 SQ FT</td> </tr> <tr> <td>UPPER LANAI</td> <td>159 SQ FT</td> </tr> <tr> <td>MECHANICAL EQUIP. ELEVATED SLABS</td> <td>162 SQ FT</td> </tr> <tr> <td>TOTAL UNDER ROOF</td> <td>3,514 SQ FT</td> </tr> <tr> <td>POOL DECK</td> <td>703 SQ FT</td> </tr> <tr> <td>DRIVEWAY</td> <td>1,275 SQ FT</td> </tr> </table>	BUILDING AREAS		GROUND LEVEL FOYER	286 SQ FT	MAIN LIVING LEVEL	1,752 SQ FT	SECOND LIVING LEVEL	1,371 SQ FT	TOTAL LIVING(UNDER A/C)	3,416 SQ FT	ENTRY	59 SQ FT	LOWER LANAI	959 SQ FT	GARAGE / STORAGE	1,373 SQ FT	MAIN LIVING BALCONY	47 SQ FT	MAIN LANAI	708 SQ FT	UPPER BALCONY	47 SQ FT	UPPER LANAI	159 SQ FT	MECHANICAL EQUIP. ELEVATED SLABS	162 SQ FT	TOTAL UNDER ROOF	3,514 SQ FT	POOL DECK	703 SQ FT	DRIVEWAY	1,275 SQ FT	<p>DESIGN CRITERIA</p> <p>BUILDING CODE 2020 Florida Building Code, 7th Edition 2017 National Electric Code</p> <p>PROJECT SPECIFIC INFORMATION PARCEL ID: 7866800007 JURISDICTION: LONGBOAT KEY (MANATEE COUNTY) ZONING: R-4SF FEMA FLOOD ZONE: AE BASE FLOOD ELEVATION: 9'-0" NAVD DESIGN FLOOD ELEVATION: 10'-0" NAVD LOT SIZE: 10,000 +/- SF</p> <p>ALLOWABLE LOT COVERAGE: 30% (3,000 SF) ACTUAL LOT COVERAGE: 28% (2,840 SF) ALLOWABLE IMPERVIOUS LOT COVERAGE: 50% (5,000 SF) ACTUAL IMPERVIOUS LOT COVERAGE: 48% (4,818 SF)</p>	<p>RECEIVED AUG 16 2021 TOWN OF LONGBOAT KEY Planning, Zoning & Building</p>																												
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LOT 19 | TOWN OF LONGBOAT KEY | MANATEE COUNTY

NO.	DATE	DESCRIPTION
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81	08/16/2021	ISSUED FOR PERMIT
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98	08/16/2021	ISSUED FOR PERMIT
99	08/16/2021	ISSUED FOR PERMIT
100	08/16/2021	ISSUED FOR PERMIT

DRAWING TITLE
COVER SHEET
SHEET NUMBER

A0.0

BUILD PERMIT PLANS
Copy of Record


SITE & DRAINAGE PLAN NOTES

- SURFACE SLOPES SHALL NOT EXCEED ONE FOOT VERTICAL RISE IN SIX FEET HORIZONTAL DISTANCE WITHIN FIVE FEET OF ANY PROPERTY LINE.
- ALL ON-SITE DRAINAGE SHALL BE DIRECTED BY SWALES OR OTHER SYSTEMS TO AN OFF SITE DRAINAGE FACILITY.
- SITE DRAINAGE TO BE CONSISTENT WITH ANY EXISTING SUBDIVISION STORM WATER MANAGEMENT PLAN.
- SWALE SLOPES SHALL BE A MINIMUM OF 0.22% LONGITUDINAL SLOPE.
- SITE RUNOFF MAY BE DIRECTED TO REAR OF LOT IF AN APPROVED DRAINAGE GREENBELT OR OTHER ESTABLISHED PUBLIC OR PRIVATE DRAINAGE FACILITY IS AVAILABLE.
- ALL REQUIRED SWALES OR OTHER SYSTEMS MUST BE IN PLACE PRIOR TO COMMENCEMENT OF CONSTRUCTION.
- SITE DRAINAGE TO BE SWALES AS TO NOT ALLOW DRAINAGE ON TO ADJACENT PROPERTIES.
- A REGISTERED FLORIDA SURVEYOR SHALL LOCATE BUILDING ON SITE FOR CONFORMANCE PRIOR TO FOOTING PLACEMENT.
- IF APPLICABLE, ALL PLUMBING, MECHANICAL, AND ELECTRICAL EQUIPMENT, INCLUDING DUCTWORK WILL BE LOCATED ABOVE THE DESIGN FLOOD ELEVATION (DFE). DFE = BASE FLOOD ELEVATION (BFE) + 1'-0" FREEBOARD.
- IF APPLICABLE, ALL MATERIALS BELOW THE DFE WILL BE MADE OF FLOOD RESISTANT MATERIAL.
- IF APPLICABLE, NO PLUMBING, MECHANICAL AND ELECTRICAL EQUIPMENT, WILL BE INSTALLED IN THE ELEVATOR SHAFT UNLESS IT IS REQUIRED FOR THE ELEVATOR OPERATION.
- ALL TOPOGRAPHIC INFORMATION IS SHOWN IN NAVD.
- UNLESS OTHERWISE SPECIFIED, ALL DIMENSIONS ARE TO STRUCTURAL ITEMS AND DO NOT INCLUDE FINISHES, DIMENSIONS, SIZES, MEASUREMENTS AND LOCATION INSTRUCTIONS ARE NOMINAL AND APPROXIMATE AND MAY VARY FROM WHAT IS SPECIFIED

TREE DISCLOSURE


THE PURPOSE OF THIS DISCLOSURE IS TO ACKNOWLEDGE THAT JOHN CANNON HOMES, INC. MIGHT NEED TO TRIM EXISTING TREES IN ORDER TO BUILD THIS HOUSE, BUT JOHN CANNON HOMES, INC DOESN'T WARRANT OR GUARANTEE SURVIVAL.

SWALE DETAIL

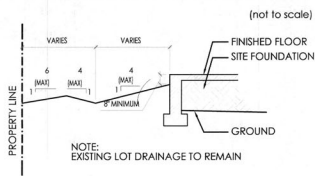

WHITNEY BAYOU

PROPOSED RESIDENCE
MIN. F.F.E = 3'-6" NAVD GROUND LEVEL
DFE = 11'-0" NAVD MAIN LIVING LEVEL
3 STORY C.B.S. AND FRAME CONSTRUCTION
2 COURSE STEM WALL, AT HOUSE CI-21
POOL AT GRADE CI-21


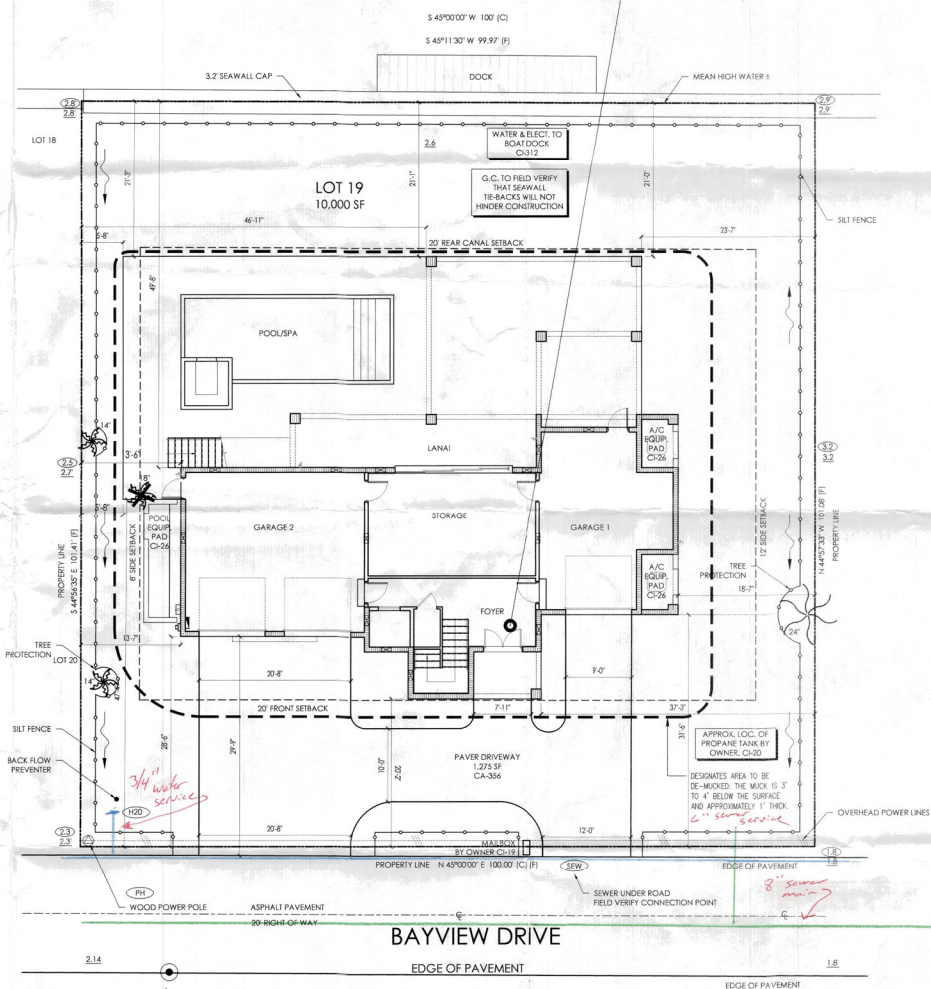


LEGEND

- PROPERTY LINE
- SEAWALL
- BASEMENT
- CENTRELINE
- SILT FENCE
- FENCING AS NOTED
- EXISTING ELEVATION
- PROPOSED ELEVATION
- HIGH POINT
- FLOW
- POWER
- PHONE
- BACKFLOW
- WATER
- GAS
- SEWER
- FIRE HYDRANT
- RECLAIMED WATER
- TREE TO REMAIN
- TREE TO BE REMOVED

SILT FENCE DETAILS & NOTES

- STAKES SPACED @ 8' MAXIMUM, USE 2" X 2" WOOD OR EQUIVALENT STEEL STAKES.
- SILT FENCE TO BE INSTALLED AT PERIMETER OF CONSTRUCTION AREA ALONG PROPERTY LINE AS PER SURVEY/PLAN AND WILL REMAIN IN PLACE DURING CONSTRUCTION, MAY BE ADJUSTED AS NEEDED TO ACCOMMODATE INSTALLATION OF FENCING, WALLS, LANDSCAPING, AND TREE RELOCATIONS. A DOUBLE SILT SCREEN SHALL BE MAINTAINED ALONG THE SHORELINE AND UPSTREAM OF MANGROVES.
- PERMANENT LANDSCAPING MUST BE PROTECTED FROM DAMAGE DURING THE CONSTRUCTION PROCESS. THIS INCLUDES BOXING THE TREE TRUNKS BEHIND A 2 X 4 "FENCE" WHICH ALSO SURROUND THE ROOTS.
- FILTER FABRIC FENCE MUST BE PLACED AT LEVEL EXISTING GRADE. BOTH ENDS OF THE BARRIER MUST BE EXTENDED AT LEAST 8 FEET UP SLOPE AT 45 DEGREES TO THE MAIN BARRIER ALIGNMENT.
- SILT FENCE TO BE INSPECTED AFTER EACH STORM EVENT AND TO BE MAINTAINED AS REQUIRED.
- SEDIMENT MUST BE REMOVED WHEN ACCUMULATIONS REACH 1/2 THE ABOVE GROUND HEIGHT OF THE FENCE.
- EXISTING DRAINAGE SHALL BE MAINTAINED OR IMPROVED TO MATCH SWALE DETAIL.
- ANY SECTION OF FILTER FABRIC FENCE WHICH HAS BEEN UNDERMINED OR TAPPED MUST BE IMMEDIATELY REPLACED WITH A ROCK FILTER OUTLET.

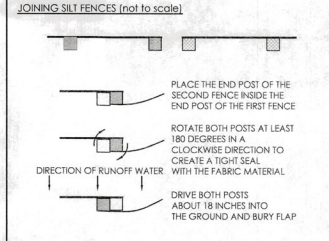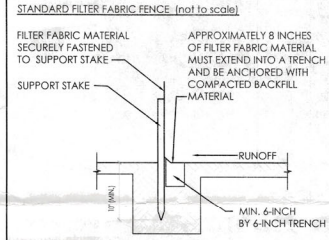

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A NEW CUSTOM RESIDENCE FOR
ANTHONY & VICKI SKIDMORE
608 Bayview Drive | Longboat Key, Florida | 34228
LOT 19 | TOWN OF LONGBOAT KEY | MANATEE COUNTY


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3	07/19/2021	REVISED PER COMMENTS
4	07/19/2021	REVISED PER COMMENTS
5	07/19/2021	REVISED PER COMMENTS
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48	07/19/2021	REVISED PER COMMENTS
49	07/19/2021	REVISED PER COMMENTS
50	07/19/2021	REVISED PER COMMENTS

RECEIVED
JUL 19 2021
TOWN OF LONGBOAT KEY
Planning, Zoning & Safety

SITE AND DRAINAGE PLAN
SCALE: 1/8" = 1'-0"

DRAWING TITLE
SITE AND DRAINAGE PLAN
SHEET NUMBER
A1.0

POOL EQUIPMENT SCREEN ENCLOSURE DETAILS

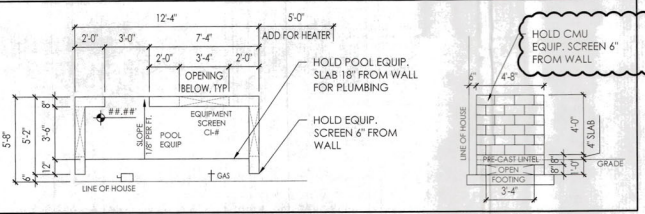


FLO-THRU VENT SCHEDULE					
AREA	SQUARE FOOTAGE	NO. OF VENTS PROVIDED	SIZE OF VENT PROVIDED	DRAIN CAPACITY PROVIDED	DRAIN CAPACITY REQUIRED
GARAGE 1	321	2	8 x 16	440	321
GARAGE 2	532	3	8 x 16	660	532
STORAGE	325	2	8 x 16	440	325
FOYER	288	1	8 x 16	220	288
ELEVATOR SHAFT	27	2	8 x 16	440	27

- GENERAL NOTES**
- ALL MATERIALS ARE TO BE INSTALLED PER MANUFACTURERS SPECIFICATIONS AND IN ACCORDANCE WITH ALL APPLICABLE BUILDING CODES.
 - CEILING HEIGHTS MAY BE ADJUSTED AS REQUIRED FOR STRUCTURAL ENGINEERING OR MECHANICAL EQUIPMENT.
 - COORDINATE POOL AND PLUMBING SLEEVES WITH POOL CONTRACTOR PRIOR TO POURING THE FOUNDATION.
 - CABINET DRAWINGS CONTAINED HEREIN ARE FOR SCHEMATIC LAYOUT ONLY. AS SUCH ALL DIMENSIONS AND LOCATIONS ARE APPROXIMATE. CABINETS ARE TO BE BUILT AND INSTALLED PER THE APPROVED CABINET DRAWINGS AS SUPPORTED BY CONTRACT DOCUMENTATION.
 - CRACK SUPPRESSION APPLIED AT ALL EXISTING SLAB CRACKS/JOINTS AT ALL TILED AREA.
 - SOLID CORE INTERIOR DOORS WITH 3/4" FINGER JOINT CASING.
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- LEGEND**
- (A) 22'X36" ATTIC ACCESS
 - (AHU) AHU IN ATTIC
 - (L) 10' STEP LADDER W/STORAGE HOOK @ATTIC ACCESS
 - (A) ARCHED OPENING—SEE INTERIOR DETAILS
 - (S) SQUARE CASED OPENING
 - (AG) AQUARIUM WINDOW TEMPERED GLASS
 - (B) BAR TOP ON 30" HIGH KNEE WALL (2X6)
 - (C) CONCRETE PAD AND STAIR
 - (CS) CORNER SHELF
 - (D) DRYER VENT TO EXTERIOR DAMPERED AND NON-SCREENED
 - (FH) FLAT HEADER - HEIGHT NOTED
 - (GB) GLASS BLOCK
 - (H) HOOD VENT TO BE INSTALLED PER MFG SPECS
 - (L) LINEN OR BATHING CLOSET WITH 6 1/4" DEEP WOOD SHELVES
 - (M) MEDICINE CABINET - 14" X 24" TOP AT 70"
 - (N) 1 1/2" DIA. GRABBAR, 36" ABOVE STAIR TREAD NOSING
 - (H) HANDRAIL 36" ABOVE STAIR TREAD NOSING OR ADJACENT FLOOR WALL/RAILERS W/ NO SPACE 4" OR GREATER
 - (R) 36" HIGH RAILING W/ BALLUSTERS W/ NO SPACE 4" OR GREATER
 - (RH) RAIN SHOWER HEAD
 - (R) ROD AND SHELF
 - (S) SHOWER ENCLOSURE TEMPERED GLASS
 - (SG) SHOWER GLASS - TEMPERED GLASS IN ALUM FRAME 2 TO 8' AFF
 - (SH) SHAMPOO NICHE 12" X 15" TOP AT - VARIES
 - (S) SHOWER SEAT
 - (SH) SHOWER HEAD
 - (W) WOOD SHELVING
 - (K) 4" KNEE WALL WITH STANDARD CAP
 - (L) PULL DOWN LADDER ACCESS

BUILDING AREAS

GROUND LEVEL FOYER	288 SQ FT
MAIN LIVING LEVEL	1,757 SQ FT
SECOND LIVING LEVEL	1,371 SQ FT
TOTAL LIVING(UNDER A/C)	3,416 SQ FT
ENTRY	59 SQ FT
LOWER LANAI	959 SQ FT
GARAGE / STORAGE	1,371 SQ FT
MAIN LIVING BALCONY	47 SQ FT
MAIN LANAI	708 SQ FT
UPPER BALCONY	47 SQ FT
UPPER LANAI	159 SQ FT
MECHANICAL EQUIP. ELEVATED SLABS	162 SQ FT
TOTAL UNDER ROOF	3,514 SQ FT
POOL DECK	703 SQ FT
DRIVEWAY	1,275 SQ FT

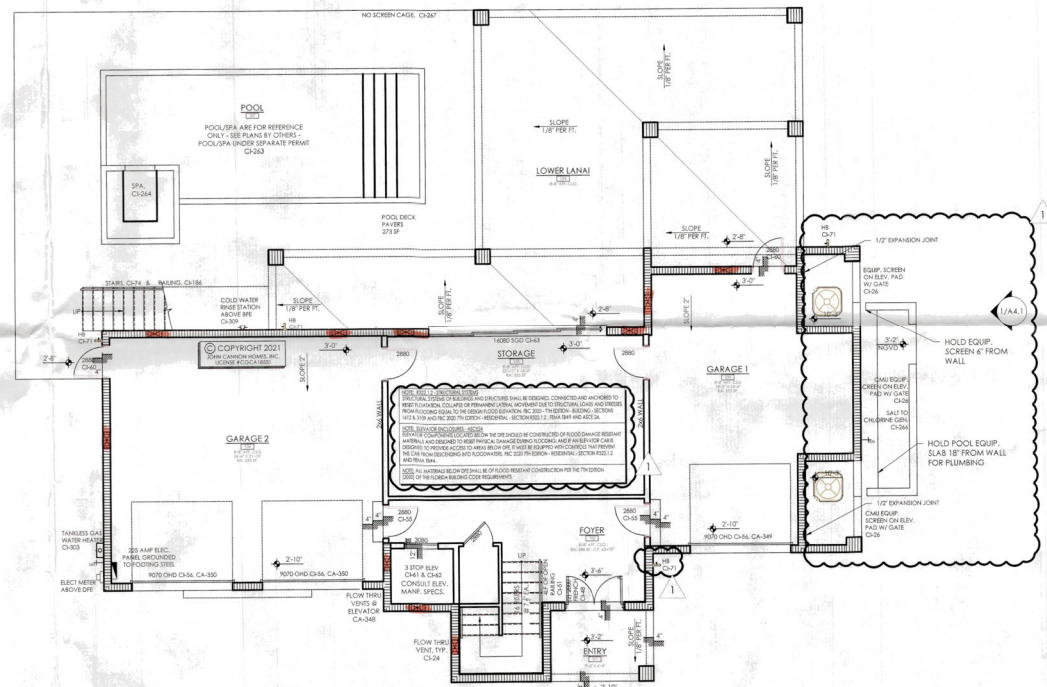

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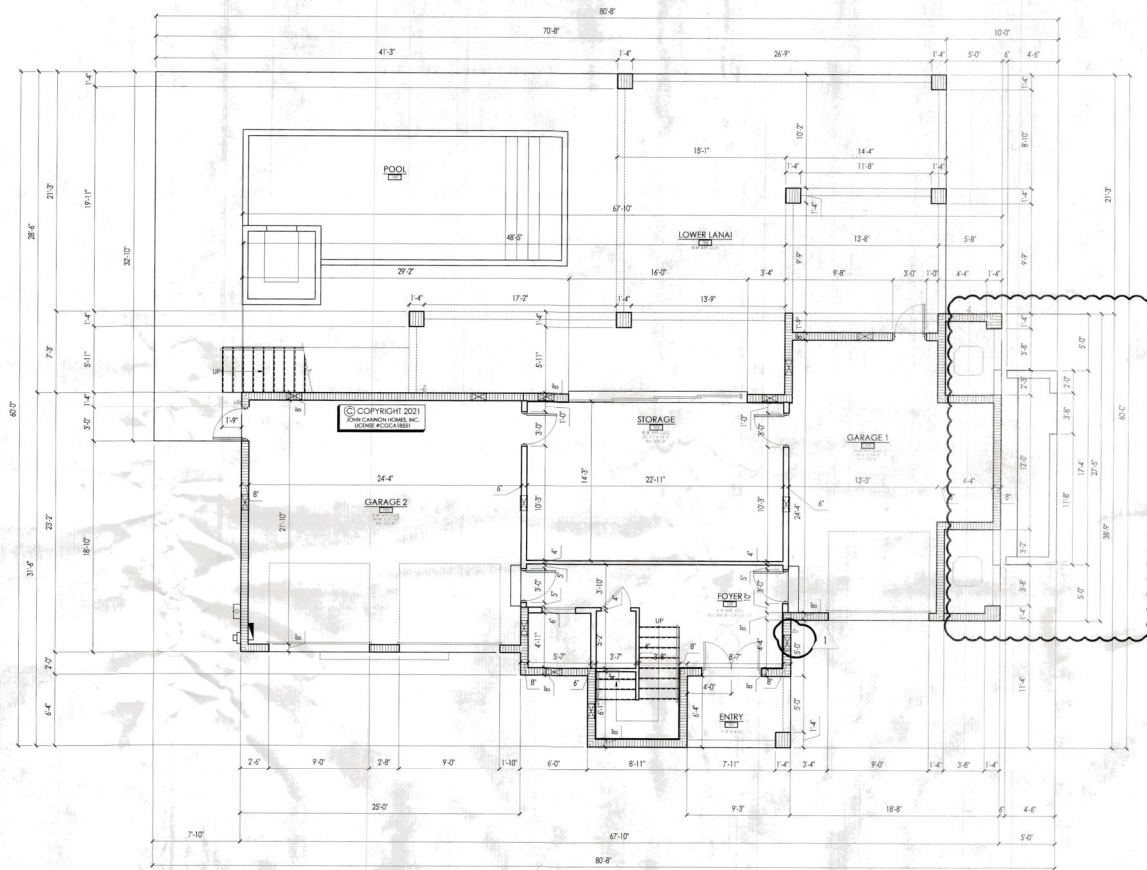
A NEW CUSTOM RESIDENCE FOR ANTHONY & VICKI SKIDMORE
 6088 Bayview Drive, L Longboat Key, Florida | 34228
 LOT 191, TOWN OF LONGBOAT KEY | MANATEE COUNTY

REV #	DATE	DESCRIPTION	BY	CHK	APP
1	03/15/23	ISSUED FOR PERMIT	YH	YH	YH
2	03/15/23	REVISIONS	YH	YH	YH
3	03/15/23	REVISIONS	YH	YH	YH
4	03/15/23	REVISIONS	YH	YH	YH
5	03/15/23	REVISIONS	YH	YH	YH
6	03/15/23	REVISIONS	YH	YH	YH
7	03/15/23	REVISIONS	YH	YH	YH
8	03/15/23	REVISIONS	YH	YH	YH
9	03/15/23	REVISIONS	YH	YH	YH
10	03/15/23	REVISIONS	YH	YH	YH
11	03/15/23	REVISIONS	YH	YH	YH
12	03/15/23	REVISIONS	YH	YH	YH
13	03/15/23	REVISIONS	YH	YH	YH
14	03/15/23	REVISIONS	YH	YH	YH
15	03/15/23	REVISIONS	YH	YH	YH
16	03/15/23	REVISIONS	YH	YH	YH
17	03/15/23	REVISIONS	YH	YH	YH
18	03/15/23	REVISIONS	YH	YH	YH
19	03/15/23	REVISIONS	YH	YH	YH
20	03/15/23	REVISIONS	YH	YH	YH

BLDG PERMIT PLANS FILE
 Copy of Record
RECEIVED
 APR 2 8 2023
 TOWN OF LONGBOAT KEY
 Planning, Zoning & Building

GROUND LEVEL FLOOR PLAN
 SCALE: 3/16" = 1'-0"

DRAWING TITLE
 Ground Level Floor Plan
SHEET NUMBER
 A2.0



- DIMENSION NOTES**
1. DRAWINGS ARE NOT TO BE SCALED. CONTACT BUILDER FOR ANY DIMENSION NOT SHOWN.
 2. EXTERIOR DIMENSIONS ARE TO APPROXIMATE FACE OF BLOCK.
 3. INTERIOR DIMENSIONS ARE TO APPROXIMATE FINISH FACE OF WALL.
 4. INTERIOR DOOR OFFSETS TO BE 3" MIN. UNLESS OTHERWISE NOTED.
 5. WINDOW OPENINGS ARE DIMENSIONED TO THE CENTER OF THE OPENING. WINDOW SIZES PROVIDED ARE APPROXIMATE AND SHOULD BE VERIFIED WITH WINDOW MANUFACTURER.

JOHN CANNON HOMES
 6781 Phoenix Blvd., Suite 100
 Sarasota, FL 34235
 941.224.8357 | 941.224.8131 F
 john@johncannonhomes.com

YH YOUNG & HEDRICK
 10000 W. Bay Blvd., Suite 100
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 813.289.1100 | 813.289.1101 F
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NEW CUSTOM RESIDENCE FOR
ANTHONY & VICKI SKIDMORE
 608 Bayview Drive | Longboat Key, Florida | 34228
 LOT 19 | TOWN OF LONGBOAT KEY | MANATEE COUNTY

REV #	DATE	DESCRIPTION	BY	CHK	APP
1	08/18/2021	ISSUED FOR PERMIT	YH	YH	JCH
2	08/18/2021	REVISIONS	YH	YH	JCH
3	08/18/2021	REVISIONS	YH	YH	JCH
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5	08/18/2021	REVISIONS	YH	YH	JCH
6	08/18/2021	REVISIONS	YH	YH	JCH
7	08/18/2021	REVISIONS	YH	YH	JCH
8	08/18/2021	REVISIONS	YH	YH	JCH
9	08/18/2021	REVISIONS	YH	YH	JCH
10	08/18/2021	REVISIONS	YH	YH	JCH

RECEIVED
 AUG 18 2021
 TOWN OF LONGBOAT KEY
 Planning, Zoning & Building

GROUND LEVEL FLOOR PLAN
 SCALE: 3/16" = 1'-0"


DRAWING TITLE
 GROUND LEVEL DIMENSION PLAN
 SHEET NUMBER
A2.0d

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6. CRACKS/JUNCTIONS AT ALL TILED AREA
7. SOLID CORE INTERIOR DOORS WITH 3 1/4" FINGER JOINT CASING.
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LEGEND

- ① 22'X36" ATTIC ACCESS
- ② AHU IN ATTIC
- ③ 10 STEP LADDER W/STORAGE HOOK @ATTIC ACCESS
- ④ ARCHED OPENING—SEE INTERIOR DETAILS
- ⑤ SQUARE CASED OPENING
- ⑥ AQUARIUM WINDOW TEMPERED GLASS.
- ⑦ BAIT TOP ON 30" HIGH KNEE WALL (2X4)
- ⑧ CONCRETE PAD AND STAR
- ⑨ CORNER SHELF
- ⑩ DRYER VENT TO EXTERIOR DAMPERED AND NON-SCREENED
- ⑪ FLAT HEADER - HEIGHT NOTED
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- ⑬ HOOD VENT TO BE INSTALLED PER MFG SPECS
- ⑭ LINEN OR PAINTY CLOSET WITH 5 1/8" DEEP WOOD SHELVES
- ⑮ MEDICINE CABINET - 14" X 24" TOP AT 7'
- ⑯ 1 1/2" DIA. GRABRAIL 36" ABOVE STAR TREAD NOING
- ⑰ HANDRAIL 36" ABOVE STAR TREAD NOING OR ADJACENT FLOOR
- ⑱ W/BALLUSTERS W/ NO SPACE 4" OR GREATER
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- ⑳ RAIN SHOWER HEAD
- ㉑ ROD AND SHELF
- ㉒ SHOWER ENCLOSURE TEMPERED GLASS
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- ㉔ SHAMPOO NICHE 12" X 13" TOP AT - VARIES
- ㉕ SHOWER SEAT
- ㉖ SHOWER HEAD
- ㉗ WOOD SHELVING
- ㉘ 4" O" KNEE WALL WITH STANDARD CAP
- ㉙ PULL DOWN LADDER ACCESS



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A NEW CUSTOM RESIDENCE FOR
ANTHONY & VICKI SKIDMORE
 608 Bayview Drive | Longboat Key, Florida | 34228
 LOT 19 | TOWN OF LONGBOAT KEY | MANATEE COUNTY

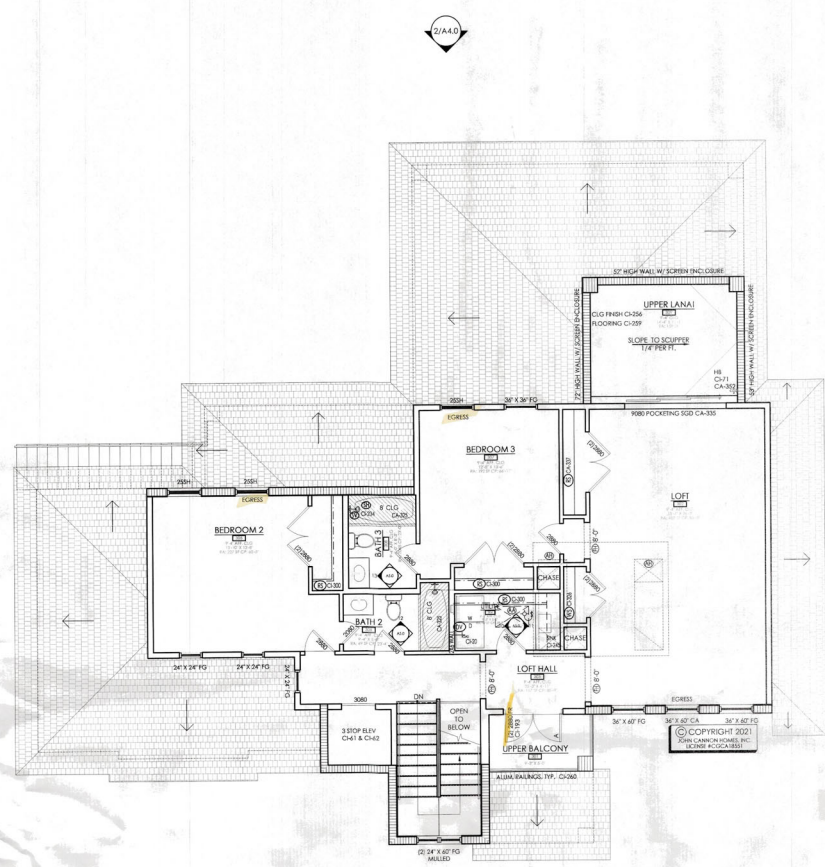NO.	DATE	DESCRIPTION	BY	CHK	APP
1		ISSUED FOR PERMIT			
2		ISSUED FOR PERMIT			
3		ISSUED FOR PERMIT			
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10		ISSUED FOR PERMIT			

BLDG PERMIT PLANS
 JUL 19 2021
 TOWN OF LONGBOAT KEY
 Planning & Zoning Department

UPPER LEVEL FLOOR PLAN
 SCALE: 3/16" = 1'-0"

DRAWING TITLE
 UPPER LEVEL FLOOR PLAN
 SHEET NUMBER

A2.2

ROOF VENTS

GARAGE : 1,313 SF	ENTRY: 59 SF	UPPER LANAI: 1,59 SF
ROOF VENT: 315 S1	ROOF VENT: 14 S1	ROOF VENT: 38 S1
EYE VENT: 315 S1	EYE VENT: 14 S1	EYE VENT: 38 S1
VENTS REQUIRED: 5	VENTS REQUIRED: 1	VENTS REQUIRED: 1




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A NEW CUSTOM RESIDENCE FOR
ANTHONY & VICKI SKIDMORE
 638 Bayview Drive | Longboat Key, Florida | 34228
 LOT 191 TOWN OF LONGBOAT KEY | MANATEE COUNTY

NO.	DATE	DESCRIPTION	BY	CHK	APP
1	11.13.20	PRELIMINARY DESIGN			
2	11.13.20	REVISED DESIGN			
3	11.13.20	REVISED DESIGN			
4	11.13.20	REVISED DESIGN			
5	11.13.20	REVISED DESIGN			
6	11.13.20	REVISED DESIGN			
7	11.13.20	REVISED DESIGN			
8	11.13.20	REVISED DESIGN			
9	11.13.20	REVISED DESIGN			
10	11.13.20	REVISED DESIGN			

DRAWING TITLE
 ROOF PLAN
 SHEET NUMBER
A3.0

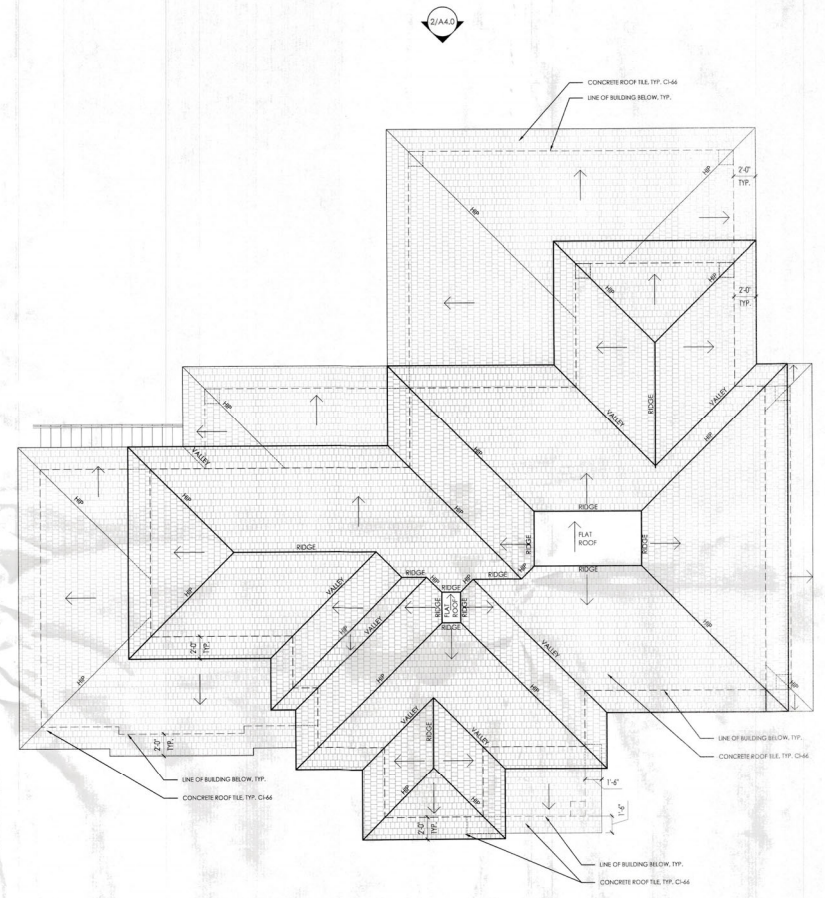


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ROOF PLAN
 SCALE: 3/16" = 1'-0"



TEMPORARY BRACKET DETAILS

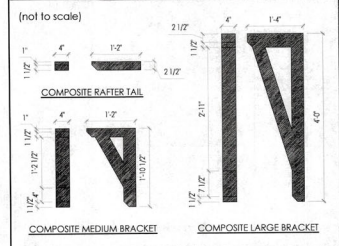

- ELEVATION NOTES**
- 5/8" SAND FINISH CEMENTITIOUS PARGE COAT OVER CONCRETE MASONRY UNITS OR 7/8" SAND FINISH CEMENTITIOUS PARGE COAT OVER PAPERBACK WIRE LATH OVER 1/2" SHEATHING, U.N.O.
 - PARGE COAT TO FINISH 4" BELOW FINISH GRADE.
 - ENTRY CEILING TO BE PARGE COAT OVER EXPANDED RIB METAL LATH.
 - SAND FINISH ON ALL BANDS, TRIM DETAILS, AND WINDOW RETURNS FROM BANDS, U.N.O.
 - ADD NAILERS AS REQUIRED FOR FIBER CEMENT SOFFITS.
 - NO EXPOSED CONDUIT IN GARAGE OR ON EXTERIOR OR HOME.
 - IF APPLICABLE, ALL MATERIALS BELOW THE DFE WILL BE MADE OF FLOOD RESISTANT MATERIAL.
 - IF APPLICABLE, NO PLUMBING, MECHANICAL AND ELECTRICAL EQUIPMENT WILL BE INSTALLED IN THE ELEVATOR SHAFT UNLESS IT IS REQUIRED FOR THE ELEVATOR OPERATION.
 - ALL ELEC. EQUIPMENT TO BE MOUNTED ABOVE BFE.

1 FRONT (NORTH) ELEVATION
SCALE: 3/16" = 1'-0"



2 REAR (SOUTH) ELEVATION
SCALE: 3/16" = 1'-0"

JOHN CANNON HOMES, INC.
1400 S. GARDNER AVE., SUITE 100
TALLAHASSEE, FL 32310
941.282.8888 | 941.354.4278
jchomes.com

YH YOUNG HEDRICK
ARCHITECTS
1000 N. GARDNER AVE., SUITE 100
TALLAHASSEE, FL 32310
941.282.8888 | 941.354.4278
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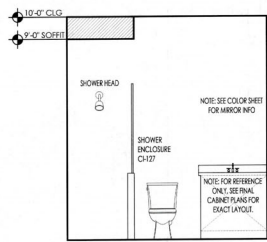
JOHN CANNON HOMES, INC.
LICENSE #EC0041803
This plan was prepared by the architect or engineer, and the contractor is responsible for obtaining all necessary permits and for complying with all applicable codes and regulations. The contractor shall obtain the consent of John Cannon Homes, Inc. prior to construction.

ANTHONY & VICKI SKIDMORE
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LOT 191 TOWN OF LONGBOAT KEY | MANATEE COUNTY


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9	08/16/2021	ISSUED FOR PERMIT
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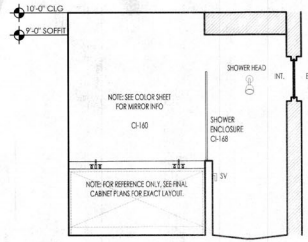
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EXTERIOR ELEVATIONS
SHEET NUMBER
A4.0




1 BATH 1 ELEV
A5.0 SCALE: 3/8" = 1'-0"




2 BATH 1 ELEV
A5.0 SCALE: 3/8" = 1'-0"

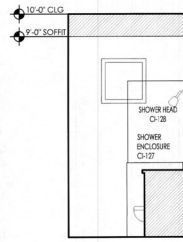


3 MASTER BATH ELEV
A5.0 SCALE: 3/8" = 1'-0"

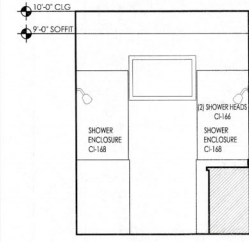


4 MASTER BATH ELEV
A5.0 SCALE: 3/8" = 1'-0"

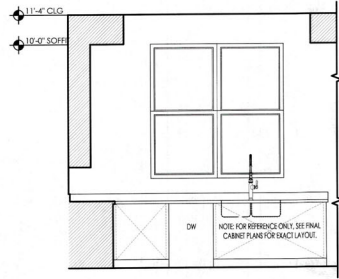


5 KITCHEN ELEV
A5.0 SCALE: 3/8" = 1'-0"

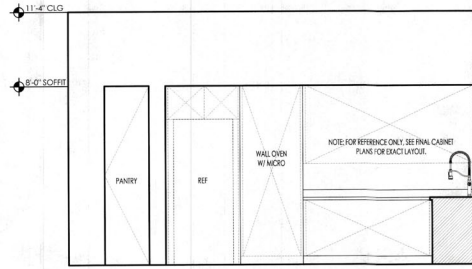


6 KITCHEN ELEV
A5.0 SCALE: 3/8" = 1'-0"

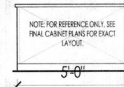

7 KITCHEN ISLAND ELEV
A5.0 SCALE: 3/8" = 1'-0"

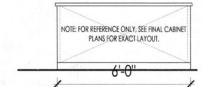


8 KITCHEN ISLAND ELEV
A5.0 SCALE: 3/8" = 1'-0"

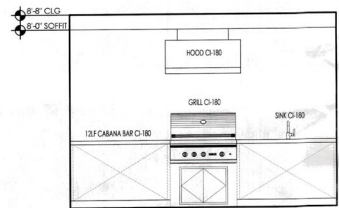


9 CABANA BAR ELEV
A5.0 SCALE: 3/8" = 1'-0"




10 UTILITY ROOM ELEV
A5.0 SCALE: 3/8" = 1'-0"

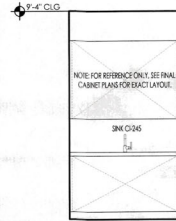

11 UTILITY ROOM ELEV
A5.0 SCALE: 3/8" = 1'-0"

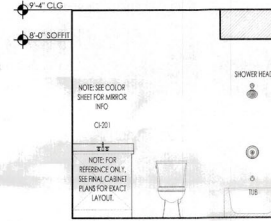

12 BATH 2 ELEV
A5.0 SCALE: 3/8" = 1'-0"

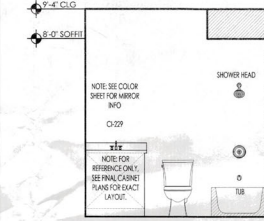

13 BATH 3 ELEV
A5.0 SCALE: 3/8" = 1'-0"



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ANTHONY & VICKI SKIDMORE
608 Bayview Drive | Longboat Key, Florida | 34228
LOT 19 | TOWN OF LONGBOAT KEY | MANATEE COUNTY

REV #	DATE	DESCRIPTION
1	03/19/2021	ISSUED FOR PERMIT
2	03/19/2021	ISSUED FOR PERMIT
3	03/19/2021	ISSUED FOR PERMIT
4	03/19/2021	ISSUED FOR PERMIT
5	03/19/2021	ISSUED FOR PERMIT
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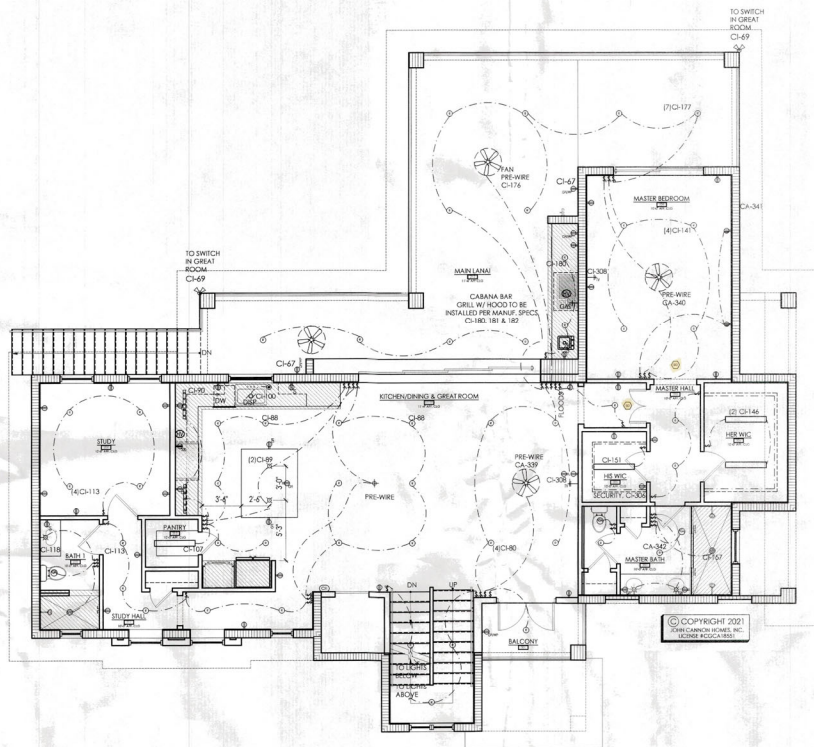
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INTERIOR ELEVATIONS

SHEET NUMBER

A5.0

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ELECTRICAL SYMBOL LEGEND

LIGHTING	
⓪	LED RECESSED CEILING LIGHT - 6"
⓪	LED RECESSED CEILING LIGHT - 4"
⓪	SEALED LED RECESSED CEILING LIGHT
⓪	PRE-WIRE FOR PENDANT LIGHT FIXTURE
⓪	PRE-WIRE FOR CEILING MOUNTED FIXTURE/CHANDELIER
⓪	DIRECTIONAL CEILING LIGHT
⓪	PRE-WIRE FOR WALL SCONCE
⓪	FLOOD LIGHT - SOFFIT MOUNTED
⓪	WALL MOUNTED EXTERIOR LIGHT
⓪	LINEAR LED SURFACE MOUNTED LIGHT
⓪	LED LIGHTING UNDER CABINETS
SWITCHES	
⓪	SINGLE POLE SWITCH
⓪	3-WAY SWITCH
⓪	4-WAY SWITCH
⓪	DIMMER SWITCH
⓪	PUSHBUTTON SWITCH
⓪	AIR SWITCH
⓪	GARBAGE DISPOSAL
OUTLETS	
⓪	DUPLEX OUTLET
⓪	WEATHERPROOF OUTDOOR DUPLEX OUTLET
⓪	GROUND FAULT INDICATOR DUPLEX OUTLET
⓪	SPECIAL CONNECTION
⓪	220v OUTLET
⓪	SPLIT DUPLEX OUTLET, ONE SIDE SWITCHED
⓪	QUADRUPLUX OUTLET
⓪	DUPLEX FLOOR OUTLET
⓪	PLUGMOLD/OUTLET STRIP
⓪	DISCONNECT - EQUIPMENT OUTLET AS REQUIRED
⓪	USB OUTLET
OTHER	
⓪	ATTIC ACCESS LIGHT/SWITCH
⓪	EXHAUST FAN
⓪	DOORBELL
⓪	DOORBELL CHIME
⓪	GARAGE DOOR OPENER
⓪	SMOKE/CARBON MONOXIDE DETECTOR
⓪	CABLE TELEVISION
⓪	GAS CONNECTION
⓪	PRE-WIRE FOR CEILING FAN

ELECTRICAL NOTES

- STRUCTURED WIRING SYSTEM: (6) ACTIVE DUAL PORT JACKS (6 TV/6 DATA) WITH STRUCTURED WIRE ENCLOSURE AND 110 OUTLET, ONE MINI HOUSE CONTROLLER.
- ALL ELECTRICAL TO BE INSTALLED ABOVE BFE, UNLESS OTHERWISE INDICATED.
- PROVIDE AND INSTALL GROUND FAULT CIRCUIT-INTERRUPTERS (GFI) AS INDICATED ON PLANS, TO INCLUDE GARAGES, UTILITY ROOMS, KITCHEN, BATHS, DOCK, AND ALL EXTERIOR OUTLETS.
- ALL OUTLETS NOT REQUIRED TO BE GFCI OUTLETS MUST BE ARC-FAULT WITH TAMPER PROOF SWITCHES.
- PROVIDE A SWITCH FOR POOL LIGHT, IF UPGRADE CONTROL SYSTEM IS PROVIDED NO SWITCH REQUIRED.
- FOR LOW VOLTAGE AND SUPPORTING ELECTRICAL INFORMATION, PLEASE SEE LOW VOLTAGE DRAWINGS PROVIDED BY OTHERS.
- NO EXPOSED CONDUIT IN GARAGE OR ON EXTERIOR OF HOME.
- 18" CLEAR (MIN.) ON ALL WIC LIGHTS.
- VERIFY ALL APPLIANCE AND EQUIPMENT ELECTRICAL REQUIREMENTS WITH MANUFACTURERS AND MODELS SELECTED BY OWNER.
- PLANS ARE INTENDED TO CONFORM WITH 2017 NEC ELECTRICAL CODE. ELECTRICAL LOCATIONS SHOWN ON DRAWINGS MAY BE CHANGED TO COMPLY W/ NATIONAL AND MUNICIPAL BUILDING AND ELECTRICAL CODES. BUILDER WILL NOT GUARANTEE LOCATION OR QUANTITY OF OUTLETS AND / OR SWITCHES SHOWN.



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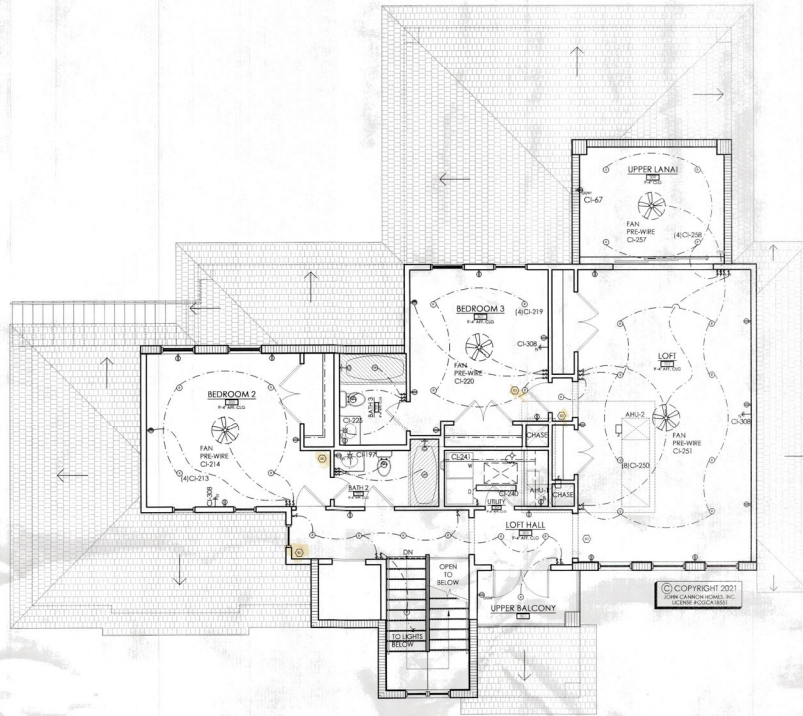
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ANTHONY & VICKI SKIDMORE
608 Bayview Drive | Longboat Key, Florida | 34228
LOT 191 TOWN OF LONGBOAT KEY | MANATEE COUNTY

REV #	DATE	DESCRIPTION	BY	CHK	APP
1	10/13/21	ISSUED FOR PERMIT			
2	10/13/21	REVISIONS			
3	10/13/21	REVISIONS			
4	10/13/21	REVISIONS			
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Planning, Zoning & Building

MAIN LEVEL ELECTRICAL PLAN
SCALE: 3/16" = 1'-0"

DRAWING TITLE
MAIN LEVEL ELECTRICAL PLAN
SHEET NUMBER
A6.1



ELECTRICAL SYMBOL LEGEND

LIGHTING	
	LED RECESSED CEILING LIGHT - 6"
	LED RECESSED CEILING LIGHT - 4"
	SEALED LED RECESSED CEILING LIGHT
	PRE-WIRE FOR PENDANT LIGHT FIXTURE
	PRE-WIRE FOR CEILING MOUNTED FIXTURE/CHANDELER
	DIRECTIONAL CEILING LIGHT
	PRE-WIRE FOR WALL SCONCE
	FLOOD LIGHT - SOFFIT MOUNTED
	WALL MOUNTED EXTERIOR LIGHT
	LINEAR LED SURFACE MOUNTED LIGHT
	LED LIGHTING UNDER CABINETS
SWITCHES	
	SINGLE POLE SWITCH
	3-WAY SWITCH
	4-WAY SWITCH
	DIMMER SWITCH
	PUSHBUTTON SWITCH
	AIR SWITCH
	GARBAGE DISPOSAL
OUTLETS	
	DUPLEX OUTLET
	WEATHERPROOF OUTDOOR DUPLEX OUTLET
	GROUND FAULT INDICATOR DUPLEX OUTLET
	SPECIAL CONNECTION
	220V OUTLET
	SPLIT DUPLEX OUTLET, ONE SIDE SWITCHED
	QUADRUPLUX OUTLET
	DUPLEX FLOOR OUTLET
	PLUGMOLD/OUTLET STRIP
	DISCONNECT - EQUIPMENT OUTLET AS REQUIRED
	USB OUTLET
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	ATTIC ACCESS LIGHT/SWITCH
	EXHAUST FAN
	DOORBELL
	DOORBELL CHIME
	GARAGE DOOR OPENER
	SMOKE/CARBON MONOXIDE DETECTOR
	CABLE TELEVISION
	GAS CONNECTION
	PRE-WIRE FOR CEILING FAN

ELECTRICAL NOTES

- STRUCTURED WIRING SYSTEM: (6) ACTIVE DUAL PORT JACKS (6 TV/6 DATA) WITH STRUCTURED WIRE ENCLOSURE AND 110 OUTLET, ONE MINI HOUSE CONTROLLER.
- ALL ELECTRICAL TO BE INSTALLED ABOVE BFC UNLESS OTHERWISE INDICATED.
- PROVIDE AND INSTALL GROUND FAULT CIRCUIT-INTERRUPTERS (GFI) AS INDICATED ON PLANS. TO INCLUDE GARAGES, UTILITY ROOMS, KITCHEN, BATHS, DOCK, AND ALL EXTERIOR OUTLETS. ALL OUTLETS NOT REQUIRED TO BE GFCI OUTLETS MUST BE ARC-FAULT WITH TAMPER PROOF SWITCHES.
- PROVIDE A SWITCH FOR POOL LIGHT, IF UPGRADE CONTROL SYSTEM IS PROVIDED NO SWITCH REQUIRED.
- FOR LOW VOLTAGE AND SUPPORTING ELECTRICAL INFORMATION, PLEASE SEE LOW VOLTAGE DRAWINGS PROVIDED BY OTHERS.
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UPPER LEVEL ELECTRICAL PLAN
SCALE: 3/16" = 1'-0"

DRAWING TITLE
UPPER LEVEL ELECTRICAL PLAN
SHEET NUMBER
A6.2

LOCATION	QTY.	UNIT CALLOUT	SQ. FT.	WIND ZONE C/S				MFG.	NOTES	STATE OF FL APPROVAL # OR NOA #	EXPIRAT. DATE
				SIGN POSIT.	PSI NEGAT.	MFR. POSIT.	PSI NEGAT.				
STAIR CASE	2	24'x67' FG MULLED	-	-	-	-	-	PGT	IMPACT	19-1126.10	04-30-25
STAIR CASE [INTERMEDIATE LVL]	2	24'x72' FG MULLED	-	-	-	-	-	PGT	IMPACT	19-1126.10	04-30-25
MASTER BATH	1	36'x24' FG TRANSOM	-	-	-	-	-	PGT	IMPACT	19-1126.10	04-30-25
MASTER BEDROOM	1	26 SH EGRESS	18	33.0	42.9	50.0	50.0	PGT	IMPACT	20-0401.03	07-30-25
KITCHEN	1	36 SH	-	-	-	-	-	PGT	IMPACT	20-0401.03	07-30-25
STUDY	2	26 SH EGRESS	18	33.0	42.9	50.0	50.0	PGT	IMPACT	20-0401.03	07-30-25
BATH 1	1	24' x 24' FG TRANSOM	-	-	-	-	-	PGT	IMPACT	19-1126.10	04-30-25
STUDT HALL	2	36 x 60' FG	-	-	-	-	-	PGT	IMPACT	19-1126.10	04-30-25
DINING	1	24' x 24' FG TRANSOM	-	-	-	-	-	PGT	IMPACT	19-1126.10	04-30-25
STAIR CASE	2	24'x67' FG MULLED	-	-	-	-	-	PGT	IMPACT	19-1126.10	04-30-25
LOFT	2	36' x 60' FG	-	-	-	-	-	PGT	IMPACT	19-1126.10	04-30-25
LOFT	1	36' x 36' CA	-	-	-	-	-	PGT	IMPACT	20-0402.03	09-17-25
BEDROOM 3	1	36' x 36' FG	-	-	-	-	-	PGT	IMPACT	19-1126.10	04-30-25
BEDROOM 3	1	25 SH EGRESS	-	-	-	-	-	PGT	IMPACT	20-0401.03	07-30-25
BEDROOM 2	2	25 SH	-	-	-	-	-	PGT	IMPACT	20-0401.03	07-30-25
BEDROOM 2	2	24' x 24' FG TRANSOM	-	-	-	-	-	PGT	IMPACT	19-1126.10	04-30-25
LOFT HALL	1	24' x 24' FG TRANSOM	-	-	-	-	-	PGT	IMPACT	19-1126.10	04-30-25

LOCATION	QTY.	UNIT CALLOUT	SQ. FT.	WIND ZONE C/S				MFG.	NOTES	STATE OF FL APPROVAL # OR NOA #	EXPIRAT. DATE
				SIGN POSIT.	PSI NEGAT.	MFR. POSIT.	PSI NEGAT.				
FOYER	1	(2) 3'-0" x 8'-0" O/S IMPACT GLAZED	-	-	-	-	-	THERMATRU	IMPACT	FL-21142.10	12-31-21
GARAGE 1	1	9070 OVERHEAD GARAGE DOOR	-	-	-	-	-	CLOPLAY	IMPACT	17-0206.11	03-30-22
GARAGE 1	1	2880 OS Solid Core TH Rated	-	-	-	-	-	THERMATRU	IMPACT	FL-21142.4	12-31-21
STORAGE	1	1620 SGD	-	-	-	-	-	PGT	IMPACT	19-1126.04	03-24-25
GARAGE 2	1	9070 OS Solid Core TH Rated	-	-	-	-	-	THERMATRU	IMPACT	FL-21142.4	12-31-21
GARAGE 2	2	9070 OVERHEAD GARAGE DOOR	-	-	-	-	-	CLOPLAY	IMPACT	17-0206.11	03-30-22
BALCONY	1	(2) 3'-0" x 8'-0" O/S IMPACT GLAZED	-	-	-	-	-	THERMATRU	IMPACT	FL-21142.10	12-31-21
MASTER BEDROOM	1	8080 SGD EGRESS	-	-	-	-	-	PGT	IMPACT	19-1126.04	03-24-25
GREAT ROOM	1	16100 PKT SGD	-	-	-	-	-	PGT	IMPACT	19-1126.04	03-24-25
UPPER BALCONY	1	(2) 3'-0" x 8'-0" O/S IMPACT GLAZED	-	-	-	-	-	THERMATRU	IMPACT	FL-21142.10	12-31-21
LOFT	1	9080 PKT SGD	-	-	-	-	-	PGT	IMPACT	19-1126.04	03-24-25

CATEGORY	SUB CATEGORY	PRODUCT DESCRIPTION	MANUFACTURER	STATE OF FL APPROVAL # OR NOA #	EXPIRAT. DATE
WINDOWS	FIXED	SERIES PW-5520 VINYL FIXED WINDOWS	PGT	19-1126.10	04-30-25
	CASEMENT	SERIES CA-5540 VINYL CASEMENT WINDOW	PGT	20-0402.03	09-17-25
	SINGLE HUNG	SERIES SH-5500 VINYL SINGLE HUNG WINDOW	PGT	20-0401.03	07-30-25
EXT. DOORS	SERVICE	THERMATRU I/S O/S IMPACT SINGLE SERVICE DOOR	THERMATRU	FL-21142.4	12-31-21
	SINGLE	THERMATRU I/S O/S IMPACT SINGLE GLAZED	THERMATRU	FL-21142.10	12-31-21
	DOUBLE	THERMATRU I/S O/S IMPACT DOUBLE GLAZED	THERMATRU	FL-20470.12	12-31-21
	SGD	SERIES 770HP ALUMINIUM SLIDING GLASS DOORS	PGT	19-1126.04	03-24-25
	GARAGE OHD	W6 DF38T STEEL SECTIONAL GARAGE DOOR UP TO 18'	CLOPLAY	17-0206.11	03-30-22
MISC.	ROOFING TILE	CONCRETE ROOF TILE	EAGLE ROOFING	21-0114.00	10-05-26
	UNDERLAYMENT	BORAL TILESEAL	BORAL	18-0202.03	08-02-23
	ROOF VENTS	O'HAGINS CLOAKED VENT TILE	O'HAGINS	19-0109.02	04-04-24
	SIDING/SOFFIT	FIBER CEMENT SIDING/SOFFIT	JAMES HARDIE	17-0406.06	05-01-22








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A NEW CUSTOM RESIDENCE FOR ANTHONY & VICKI SKIDMORE 608 Bayview Drive | Longboat Key, Florida | 34228 LOT 19 | TOWN OF LONGBOAT KEY | MANATEE COUNTY

REV #	DATE	DESCRIPTION	BY	APP
1	08/18/2021	ISSUED FOR PERMIT
2	08/18/2021	ISSUED FOR PERMIT
3	08/18/2021	ISSUED FOR PERMIT
4	08/18/2021	ISSUED FOR PERMIT
5	08/18/2021	ISSUED FOR PERMIT
6	08/18/2021	ISSUED FOR PERMIT
7	08/18/2021	ISSUED FOR PERMIT
8	08/18/2021	ISSUED FOR PERMIT
9	08/18/2021	ISSUED FOR PERMIT
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26	08/18/2021	ISSUED FOR PERMIT
27	08/18/2021	ISSUED FOR PERMIT
28	08/18/2021	ISSUED FOR PERMIT
29	08/18/2021	ISSUED FOR PERMIT
30	08/18/2021	ISSUED FOR PERMIT

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DRAWING TITLE SCHEDULES AND NOTES SHEET NUMBER A7.0



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 TOWN OF LONGBOAT KEY
 Planning & Land Use

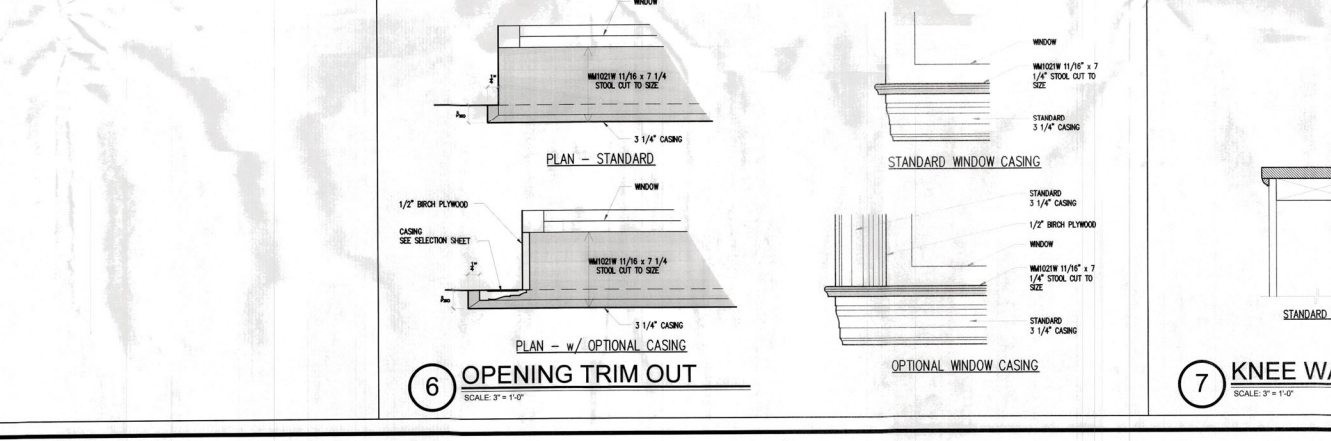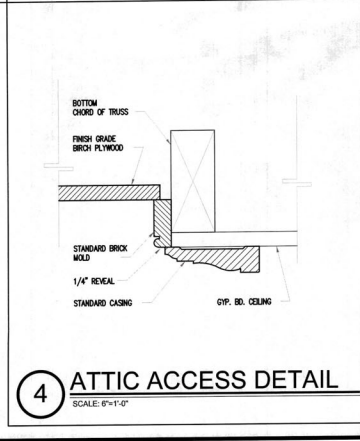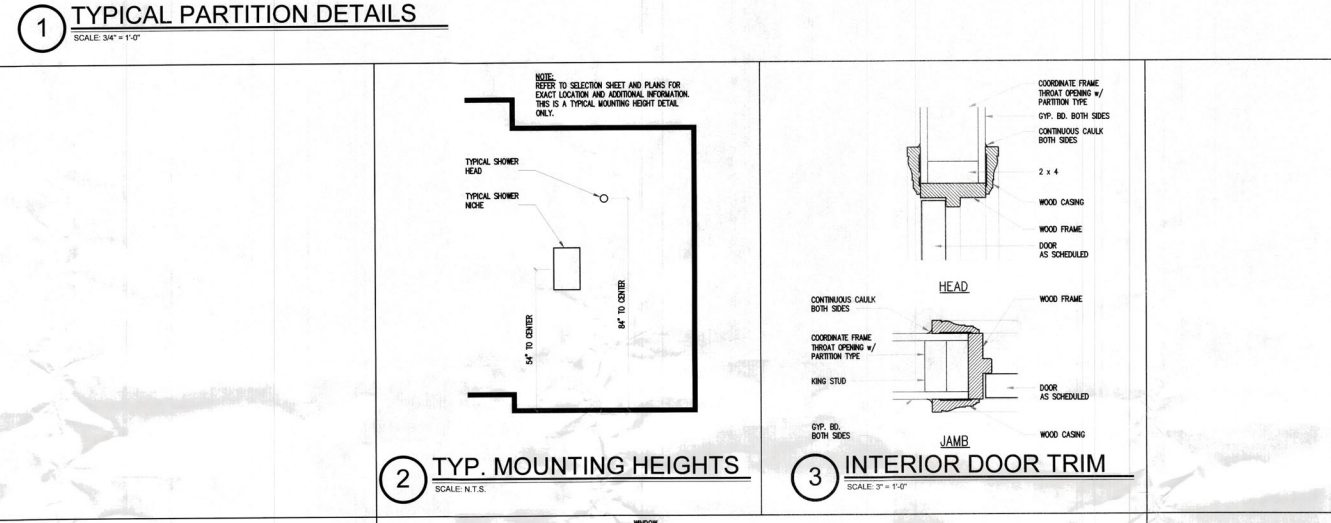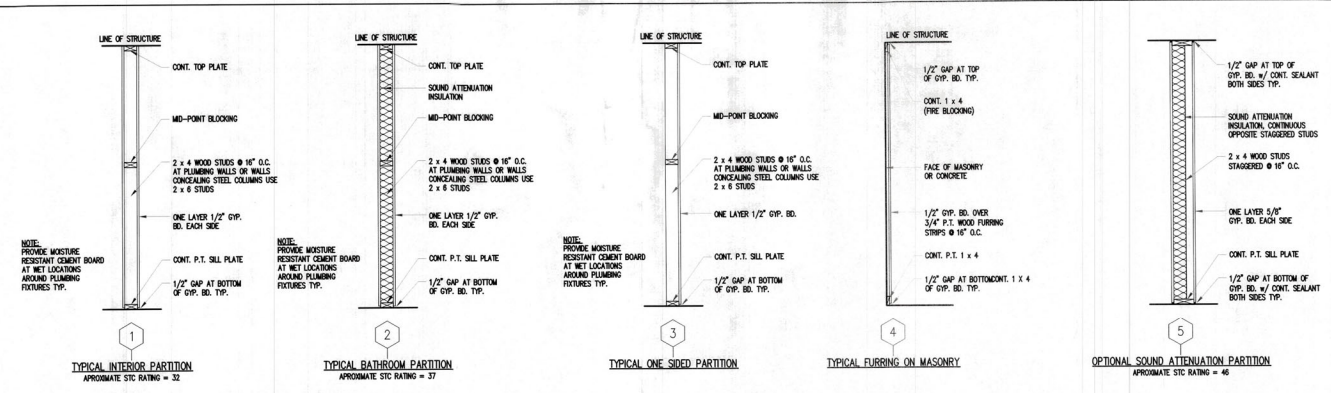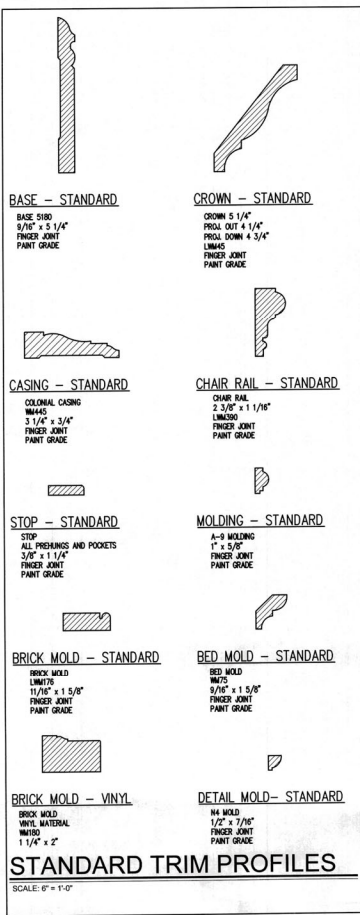


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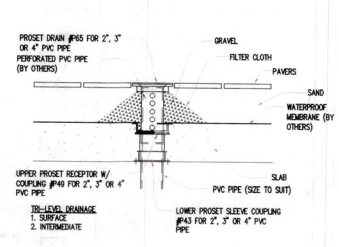
A NEW CUSTOM RESIDENCE FOR
ANTHONY & VICKI SKIDMORE
 608 BoyView Drive | Longboat Key, Florida | 34228
 LOT 19 | TOWN OF LONGBOAT KEY | MANATEE COUNTY

REV.	DATE	DESCRIPTION
1	07/19/21	ISSUED FOR PERMIT
2	07/19/21	REVISIONS
3	07/19/21	REVISIONS
4	07/19/21	REVISIONS
5	07/19/21	REVISIONS
6	07/19/21	REVISIONS
7	07/19/21	REVISIONS
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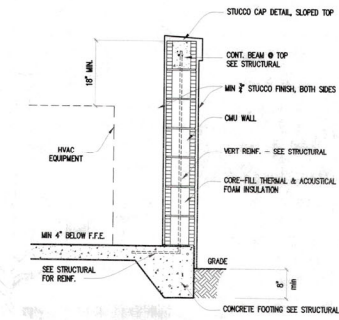
DRAWING TITLE
INTERIOR & TRIM DETAILS
 SHEET NUMBER
D1




1 FLOOD VENT DETAIL
SCALE: 1-1/2" = 1'-0"

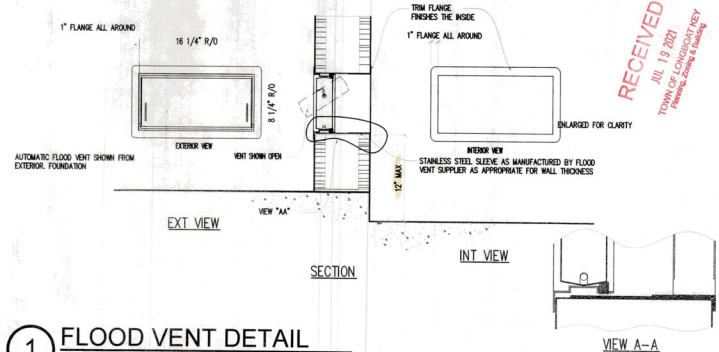


2 PATIO DRAIN DETAIL
SCALE: 1/2" = 1'-0"



3 SOUND SCREEN WALL
SCALE: 3/4" = 1'-0"

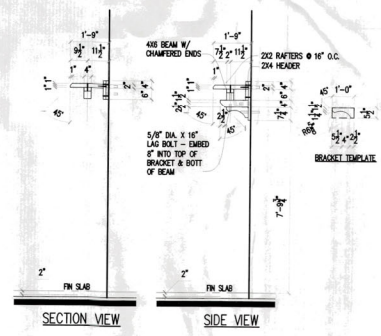

4 CANTILEVER TRELLIS DETAILS
SCALE: 3/8" = 1'-0"

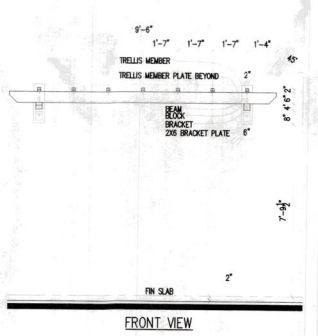

5 SITE SCREEN WALL
SCALE: 3/4" = 1'-0"

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TOWN OF LONGBOAT KEY
Planning, Zoning & Building



JOHN CANNON ARCHITECTS, INC.
LICENSE #00041881
10000 Highway 1A, Suite 100
Longboat Key, Florida 34228
www.john-cannon.com
For other contact of John Cannon Architect, Inc.
please refer to the project file.

A NEW CUSTOM RESIDENCE FOR
ANTHONY & VICKI SKIDMORE
408 Bay View Drive | Longboat Key, Florida | 34228
LOT 191 TOWN OF LONGBOAT KEY | MANATEE COUNTY

NO.	DATE	DESCRIPTION
1	07/19/21	ISSUED FOR PERMIT
2	07/19/21	ISSUED FOR PERMIT
3	07/19/21	ISSUED FOR PERMIT
4	07/19/21	ISSUED FOR PERMIT
5	07/19/21	ISSUED FOR PERMIT
6	07/19/21	ISSUED FOR PERMIT
7	07/19/21	ISSUED FOR PERMIT
8	07/19/21	ISSUED FOR PERMIT
9	07/19/21	ISSUED FOR PERMIT
10	07/19/21	ISSUED FOR PERMIT

DRAWING TITLE
MISC EXTERIOR DETAILS
SHEET NUMBER
D2.0

WOOD BEAM SCHEDULE


MARK	DESCRIPTION
WB-A	3 - 2X10 SYP NO.2 WOOD BEAM WITH 2-1/2" CDX PLYWOOD FLITCH PLATES
WB-B	3 - 1 1/2" X 11 3/8" 1.9E MICROLAM LVL BEAM
WB-C	2 - 1 1/2" X 16" 1.9E MICROLAM LVL BEAM
WB-D	16" HIGH PRE-ENGINEERED FLOOR GIRDER TRUSS BY TRUSS MANF.
WB-E	PRE-ENGINEERED FLOOR/ROOF COMBINATION GIRDER TRUSS BY TRUSS MANF.
WB-F	2 - 2X10 SYP NO.2 WOOD BEAM WITH 2-1/2" CDX PLYWOOD FLITCH PLATE
WB-G	2 - 1 1/2" X 11 3/8" 1.9E MICROLAM LVL BEAM

- NOTES:**
- NAIL 2-PLY SYP NO.2 BEAMS TOGETHER WITH 2-ROWS OF 5D NAILS AT 12" O.C.
 - ADD ADDL. SYP PILES AND FLITCH PLATES AS REQD. TO MATCH WALL THICKNESS.
 - SEE SHEET 64 FOR LVL NAILING/BOLTING PATTERNS.

ROOF TRUSS ANCHOR NOTES

DOUBLE SIMPSON HETA16 STRAPS AT ALL ROOF TRUSSES TO THE BEAMS AT THIS LEVEL.

- INSTALL ANCHORS WITH SPOONS FACING OUTWARD & STRAPS SPACED NO MORE THAN 1/2" WIDER THAN THE TRUSS WIDTH.

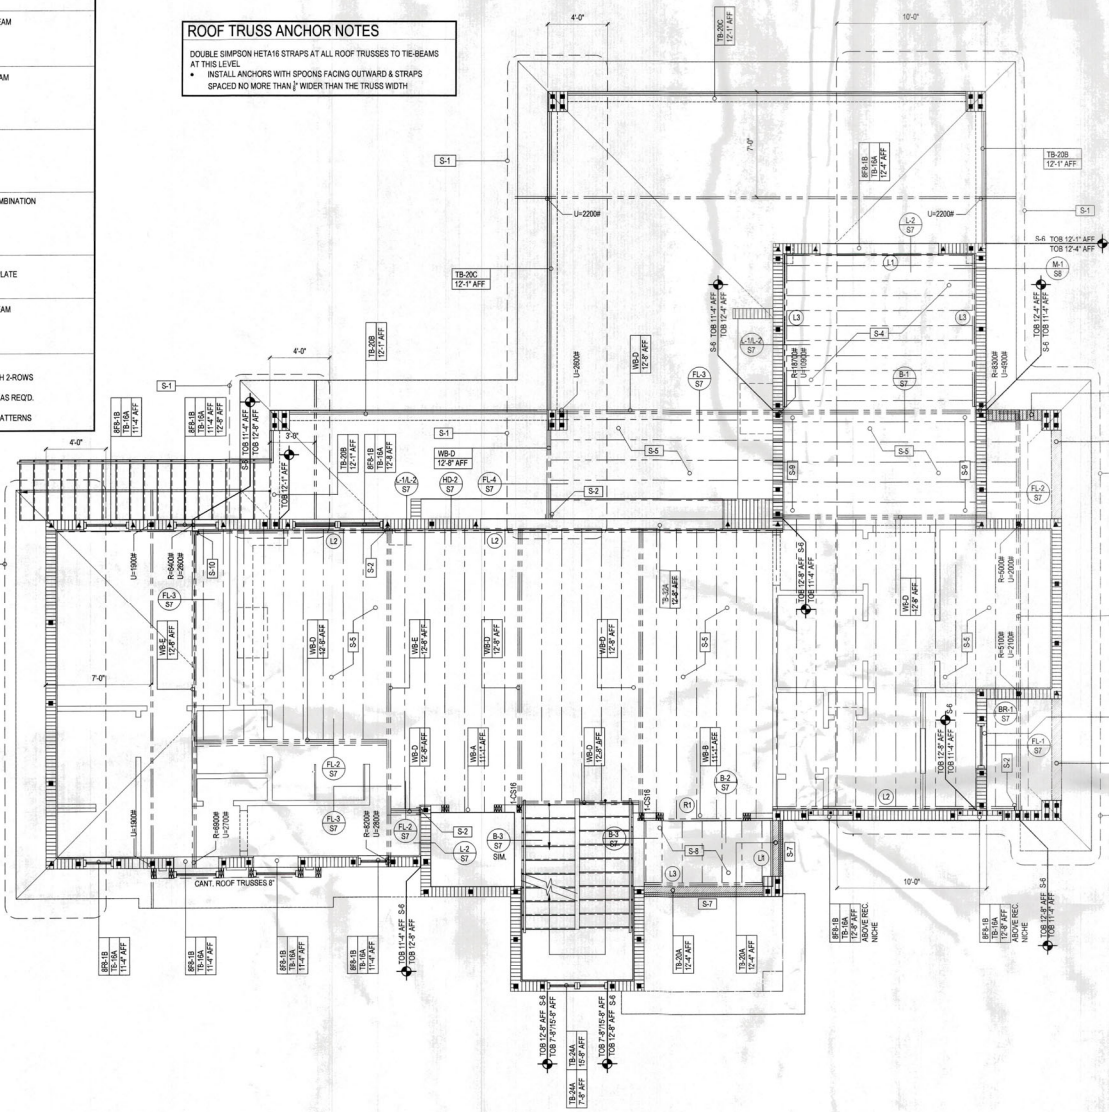

- STRUCTURAL NOTES**
- FILL ALL CELLS ABOVE PRECAST LINTELS.
 - STUB RABBED HEEL ROOF TRUSSES BACK 1/2" FROM FACE OF MASONRY FOR PLYWOOD AND STUCCO.
 - STUB FLOOR TRUSSES BACK 2" FOR RIMBOARD, PLYWOOD AND STUCCO.
 - ALL WOOD OR WOOD PRODUCTS IN CONTACT WITH CONCRETE OR MASONRY TO BE EITHER MOISTURE PROTECTED OR PRESSURE TREATED.
 - SHORING: ALL MASONRY OR CONCRETE BEAMS 10'-FT AND LONGER SHALL BE SHORED FOR A MINIMUM OF 28 DAYS AFTER POUR.

- LEDGER/RIMBOARD SCHEDULE (L1)**
- | MARK | DESCRIPTION |
|------|--|
| L1 | 1 - 2X8 PT LEDGER
SEE TRUSS PARALLEL TO LEDGER DETAIL ON S5 |
| L2 | 2 - 2X8 PT LEDGER
SEE TRUSS PERPENDICULAR TO LEDGER DETAIL ON S5 |
| L3 | 2 - 2X12 PT LEDGER
SEE TRUSS PERPENDICULAR TO LEDGER DETAIL ON S5 (SM.) |
| R1 | 16" HIGH 1.9E MICROLAM LVL RIMBOARD |

DIMENSION NOTES

SEE ARCHITECTURAL PLANS FOR DIMENSIONS NOT SHOWN ON STRUCTURAL SHEETS.

- STRUCTURAL SCHEDULE (S.1)**
- | MARK | DESCRIPTION |
|------|---|
| S-1 | BLOCK ROOF FLOOR DIAPHRAGM BEAMS WITH 2X4 SYP WITH 8D RING-SHANK ROCP. 100 FLOOR AT 8" O.C. |
| S-2 | SIMPSON HUC140 (MAX) WITH 16-2X12 TITEN 3 FASTENERS - HOLD BEAM BACK TO MAINTAIN MIN. 1 1/2" FASTENER EDGE DISTANCE |
| S-3 | ATTACH LVL BEAM TO ADJACENT BEAM WITH SIMPSON HUC140 - RUN SLIDING GLASS DOOR HEADER LONGS FOR ATTACHMENT |
| S-4 | 2X12 PT AT 12" O.C. - RIPSLOPE TOP 1/2" FT SIMPSON HUS26 AT EACH END TO LEDGER |
| S-5 | 16" HIGH PRE-ENGINEERED FLOOR TRUSSES 16" O.C. TOP AT 12'-8" AFF |
| S-6 | SEE THE BEAM STEP DETAIL ON SHEET S6 |
| S-7 | TOP HEIGHT OF BEAM MAY BE LOWERED TO ACCOMMODATE DECK SLOPE - MAX 1/2" AT MAIN LAM/LVL BEAM |
| S-8 | 2X12 PT JOISTS AT 16" O.C. - RIPSLOPE TOP 1/2" FT SIMPSON HUS26 AT EACH END TO LEDGER/RIMBOARD/BEAM |
| S-9 | SIMPSON HETA16 AT EACH FLOOR TRUSS |
| S-10 | SIMPSON HGU4M 2S-SDS (#11) WITH LEFT FLANGE CONCEALED PAD OUT GIRDER TRUSS IF NECESSARY |
| S-11 | SIMPSON HGU4M 2S-SDS (#11) - PAD OUT GIRDER TRUSS IF NECESSARY |
| S-12 | SIMPSON HUC66 (MIN) WITH 8-2X12 TITEN 2 FASTENERS - HOLD BEAM BACK TO MAINTAIN MIN. 1 1/2" FASTENER EDGE DISTANCE |
| S-13 | CLOSERIP TOP OF BEAM 1/2" FT TO ACCOMMODATE DECK SLOPE - MAX 1/2" |
| S-14 | 8" THICK 3000PSI CONCRETE SLAB WITH NO. 5 REBAR 12" O.C. EACH WAY AT MIDHEIGHT - SLOPE TOP 1/2" FT FOR DRAINAGE |
| S-15 | 16" HIGH PRE-ENGINEERED FLOOR TRUSSES 16" O.C. TOP AT 10'-0" AFF |

CONCRETE/PRECAST BEAM SCHEDULE

MARK	DESCRIPTION
TB-1B	8"X16" PRECAST LINTEL BY CAST-CRETE 1-NO.5 REBAR
TB-1B	8"X12" FORM & POUR CONCRETE BEAM 2-NO.5 REBAR TOP 2-NO.5 REBAR BOTTOM NO.3 TIES 4" O.C.
TB-1B	8"X16" FORM & POUR CONCRETE BEAM 1-NO.5 REBAR TOP 1-NO.5 REBAR BOTTOM
TB-15A	8"X16" FORM & POUR CONCRETE BEAM 2-NO.5 REBAR TOP 2-NO.5 REBAR BOTTOM NO.3 TIES 8" O.C.
TB-15B	8"X16" FORM & POUR CONCRETE BEAM 2-NO.5 REBAR TOP 2-NO.5 REBAR BOTTOM NO.3 TIES 8" O.C.
TB-15C	8"X16" FORM & POUR CONCRETE BEAM 2-NO.5 REBAR TOP 2-NO.5 REBAR BOTTOM NO.3 TIES 8" O.C.
TB-15D	8"X20" FORM & POUR CONCRETE BEAM 1-NO.5 REBAR TOP 1-NO.5 REBAR BOTTOM
TB-20A	8"X20" FORM & POUR CONCRETE BEAM 2-NO.5 REBAR TOP 2-NO.5 REBAR BOTTOM NO.3 TIES 8" O.C.
TB-20B	8"X20" FORM & POUR CONCRETE BEAM 2-NO.5 REBAR TOP 2-NO.5 REBAR BOTTOM NO.3 TIES 8" O.C.
TB-20C	8"X20" FORM & POUR CONCRETE BEAM 1-NO.5 REBAR TOP 1-NO.5 REBAR MIDDLE 1-NO.5 REBAR BOTTOM
TB-24A	8"X24" FORM & POUR CONCRETE BEAM 2-NO.5 REBAR TOP 2-NO.5 REBAR BOTTOM NO.3 TIES 10" O.C.
TB-24B	8"X24" FORM & POUR CONCRETE BEAM 2-NO.5 REBAR TOP 2-NO.5 REBAR BOTTOM NO.3 TIES 10" O.C.
TB-24C	8"X24" FORM & POUR CONCRETE BEAM 2-NO.5 REBAR TOP 2-NO.5 REBAR BOTTOM NO.3 TIES 10" O.C.
TB-28B	8"X28" FORM & POUR CONCRETE BEAM 2-NO.5 REBAR TOP 2-NO.5 REBAR BOTTOM NO.3 TIES 12" O.C.
TB-32A	8"X32" FORM & POUR CONCRETE BEAM 2-NO.5 REBAR TOP 2-NO.5 REBAR 2ND LAYER 2-NO.5 REBAR 3RD LAYER 2-NO.5 REBAR BOTTOM NO.3 TIES 12" O.C.

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 TOWN OF LONGWOOD DEPT. of Planning, Zoning & Building

YOUNG & HERDRICK
 STRUCTURAL ENGINEERING
 6721 Professional Parkway West
 Suite 201 - Lakewood Ranch, FL 34140
 www.YHengineers.com | Tel (941) 366-1925
 Fax (941) 366-1925

A Custom Home for:
ANTHONY & VICKI SKIDMORE
 608 BAYVIEW DRIVE, LONGBOAT KEY, FL 34228

UPPER LEVEL FRAMING PLAN
 1/4" = 1' - 0"

REVISIONS

BY	DATE	DESCRIPTION

