A NEW CUSTOM RESIDENCE FOR:

CLARE AND JAMES FOX

5910 Gulf of Mexico Drive | Longboat Key, Florida | 34228

MANATEE COUNTY

NPDES

DIST.

ELEC. ELECTRICA

ENG.

FOLLIP

FRZ.

HDP

FLOOR FREEZER

HOSE BIB

CONDITIONING





AREA CALCULATIONS GROUND FLOOR SECOND FLOOR 4,210 SQ. FT TOTAL LIVING : 92 SQ. FT. 125 SQ. FT. 804 SQ. FT. COVERED BALCONY : GARAGE : 404 SQ. FT 414 SO FT TOTAL UNDER ROOF OBSERVATION DECK POOL AREA: ABBREVIATIONS LIST ABV. ABOVE ALUM. ALUMIN MANUF. MANUFACT MAX. MAXIMUM ARCHITECTURA N.A.V.D. NORTH AMERICAN VERTICAL DATUM N.G.V.D NATIONAL GEODETIC VERTICAL CALC. CALCULATED CEILING

CASEMENT WINDOW

CONCRETE MASONR CMU REFRIGERATOR ONCRETE SHWR. SHOWER
SH. SINGLE HUNG WINDO

SPECS. SPECIFICATIONS
STO. STORAGE

T.O.C. TOP OF CONCRETE

W.H. WATER HEATER

STRUCT. STRUCTURAL

GENERAL NOTES

- DRAWINGS, DO NOT SCALE HESE DRAWINGS. WRITTEN DIMENSIONS AND NOTES SHALL CONTROL. CONTACT HE SUPERINFRIGHT WITH ANY CONDICTS IN THE PLANS SERVICE SEGMENTS WORK. LUSES ON HERMES SPECIFIED, ALL DIMENSIONS AND ARE OS TRUCKINGS HINDER AND DO NOT HOLDER EMBESS, DIMENSIONS, SESS, MANESQUARMS AND LOCATION NITRIBUCIDIOS ARE NOWARL AND APPROXIMATE AND MAY VARY FROM WITH IS SPECIFIED SERVICE MAY BE NOT ANY CONTROL OF THE PLANS OF THE SERVICE AND LOCATION SHOULD NOT ANY CONTROL OF THE SERVICE AND LOCATION SHOULD NOT ANY CONTROL OF THE SERVICE AND LIFE OF THE SE
- AUDITION TO PLANS AS NOTICES.

 APPLICABLE CODES: IT S THE INTENT THAT THESE DRAWINGS BE IN CONFORMANCE. WITH THE 2017 F.B.C., 2014 NEC AND ALL APPLICABLE LOCAL, COUNTY, STATE AND FEDERAL CODES, ORDINANCES, LAWS, REGULATIONS AND RESTRICTIVE COVENANTS.
- CONSENSE DE SET

 CONCENTRATE ALTRADES SMALT RENIGH ALL LABOR EQUIPMENT, MATERIALS, AND PRECION ALL WORK INCLESSARY,
 COCCO-LINICOSE ALL TRADES SMALT RENIGH ALL LABOR EQUIPMENT, MATERIALS, AND PRECION ALL WORK INCLESSARY,
 COCCO-LINICATOR ALL TRADES CON RECORDANCE ALL RESIDENCIA OF COMPANIES ALL RENIGHES CON RECORDANCE ALL RESIDENCIA CON RECORDANCE ALL RESIDENCIA CONTRACT EQUIPMENT.

 CEASE TO BANKING, CONTRACT DESCRIPTION AND SCILIC RESIDENCIA CONTRACT CONTRACT

DESIGN DISCLOSURE

EROSION & SEDIMENT CONTROL PLAN NOTES

- WHEN PANEAU, AND RENOTE OCCURS DAN'T INSPECTIONS OF THE EROSION AND SEDMENT CONTROLS AND DISCHARGE CUITHALS MAST SER PROVIDED BY SOME ONE NOW MICROSPASE AND DEPRENCED IN THE PRINCIPLES. FRACTICES, INSTALLATION, AND MAINTENANCE OF SERSON AND SERVING CONTROLS WIN MOVES FOR THE PRINCIPLES. AND ALL AND MAINTENANCE OF SERVING HE MAY THE OF SEAVE HORSE CAN'T AND MAINTENANCE AND HE MAY SERVING HORSE OF SEAVE HORSE CAN'T AND MAINTENANCE AND HE MAY SERVING HORSE OF SEAVE HORSE CAN'T AND MAINTENANCE AND HE MAY SERVING HORSE AND HE MAY SEAVE AND MAINTENANCE AND HE MAY SERVING CONTROL FOR MAINTENANCE AND HE CONTROL CONTROL SEAVE AND MAINTENANCE AND HES CHARGE OF SEAVE AND HE MAY SEAVE AND HE MAY SERVING HORSE CAN'T SEAVE AND HE MAY SEAVE A

- CHEMINE APPOVED. A SURFACE MOUNTED AND ATTACHABLE USARADO IN USE AND SEQUED FOR ALL CLASS AND FLAC CATON BASIS.

 SCONICANT ANDURATO DE SEDIMENT WHICH LEAVES THE SIZE MUST SECLEMENT UP WITHIN 24 HOUSE AND FLACED SACC ON THE SEA MOST SHALLONG OR PROPREY TO PROSED THE CAUSE OF THE SEDIMENT WELL ASK MUST SECURED AND PROPREY TO THE CAUSE OF THE SEDIMENT WELL ASK MUST SECURED AND THE CHARGE AND THE CAUSE OF THE SEDIMENT WAS ALL OWNER OWNER OF THE SEDIMENT WAS ALL OWNER OWNER

- SENIORI CONFEC, MAGNES, NACCIONACE WITH CURRENT CLEAN WATER SERVICES STANDARDS AND STATE, AND STERRA RESOLUTION AND TABLE AND STANDARDS AND STATE, AND STANDARDS AND STATE AND STANDARDS AND STANDARDS

DRAWING INDEX COVER SHEE


- MAIN LEVEL FLOOR PLAN
- MAIN LEVEL DIMENSION PLAN
- SECOND LEVEL FLOOR PLAN A2.2
- A2.3 SECOND LEVEL DIMENSION PLAN
- A3 ROOF PLAN
- EXTERIOR ELEVATIONS
- EXTERIOR FLEVATIONS
- INTERIOR FLEVATIONS
- A5.1 INTERIOR FLEVATIONS
- MAIN LEVEL ELECTRICAL PLAN
- SECOND LEVEL ELECTRICAL PLAN
- TYPICAL BUILDING DETAILS / SCHEDULES SEGUENT
- D2 DOOR & WINDOW DETAILS
- FOUNDATION PLAN
- FOUNDATION DETAILS
- FOUNDATION DETAILS
- FIRST FLOOR STRUCTURAL PLAN \$2.0
- SECOND FLOOR STRUCTURAL PLAN \$2.1
- \$3.0
- FIRST FLOOR FRAMING PLAN
- \$3.1 ROOF FRAMING PLAN
- STRUCTURAL GENERAL DETAILS \$4.0
- STRUCTURAL DETAILS \$4.1
- \$4.2 STRUCTURAL DETAILS
- \$4.3 STRUCTURAL DETAILS
 - STRUCTURAL DETAILS

James ∞ŏ are O



DRAWING TITLE

COVER SHEET

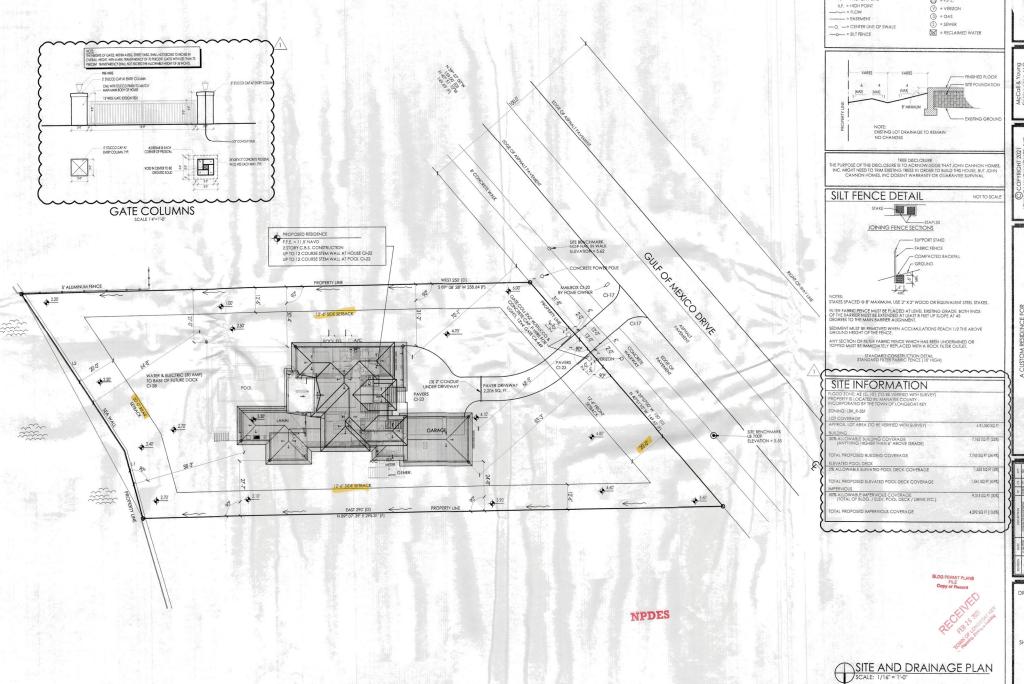

McCall & Young Engineering, LLC 8849 Energy Court sarasota, Fl. 2

LEGEND

- BLEV = EXISTING BLEVATION
BLEV) = PROPOSED BLEVATION
PL = PROPERTY LINE

OCOPYRIGHT 2021
JOHN CANNON HOMES, INC.
LICENSE #CGCA 18531
This crowing is protected under applicable


A CUSTOM RESIDENCE FOR Clare & James Fox

DRAWING SITE A

SITE A DRAIN PLA SHEET NO

-

A

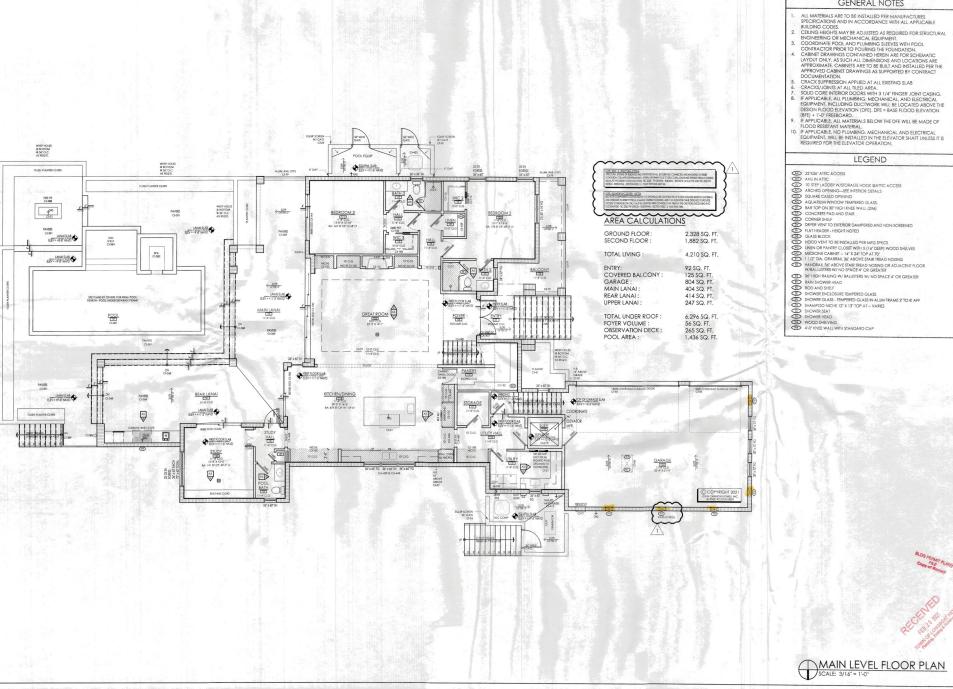

HOLES TOM D.C. 2/D.

GENERAL NOTES

Fox James ∞ŏ Clare


CANN


DRAWING TITLE

MAIN LEVEL FLOOR PLAN

SHEET NUMBER:

A2

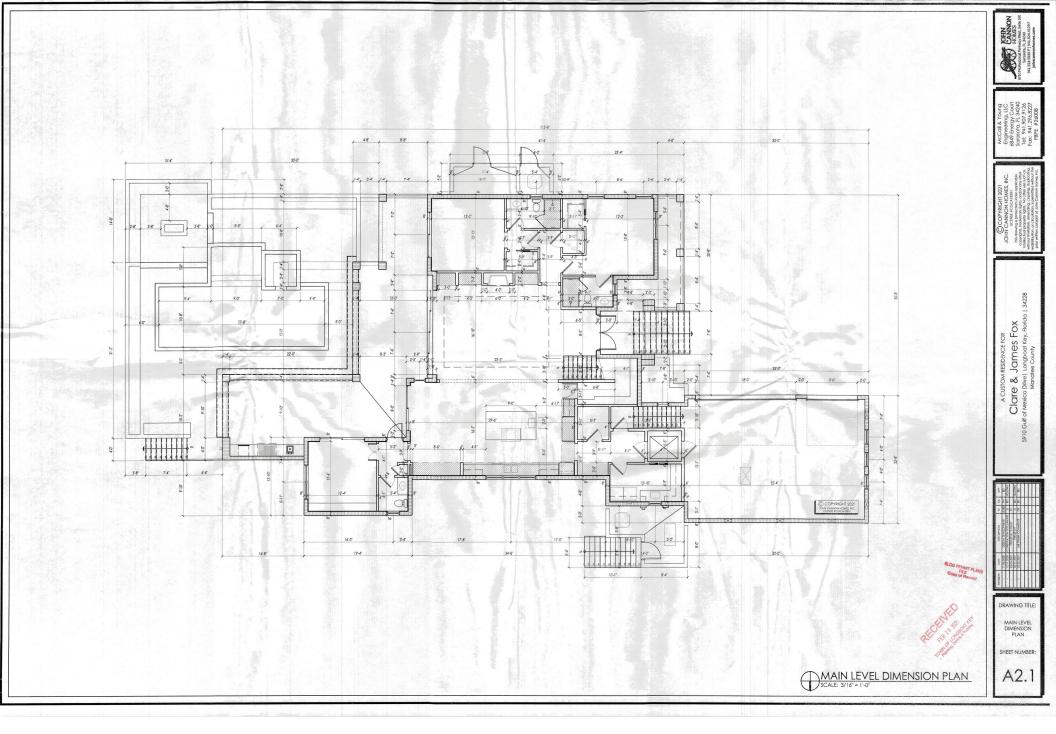

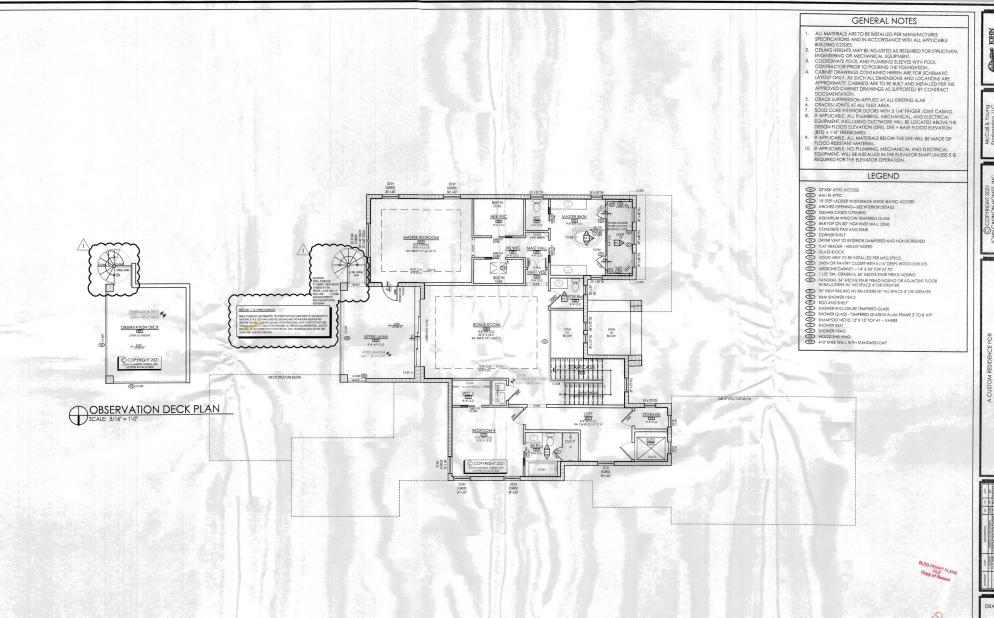

CANNON
FOR THE CANNON

6647 Enelgy Count Sarasota, FL 34240 Tel: 941.907.9126 Fax: 941.296.8227 FBPE #26008

JOHN CANNON HOMES, INC.

ICRNE eCCA. RISSI

This drowing is protectived under applicable copyrights, noderon ray other independent and applicable copyright is ordered and you other independent appropriate from the copyright is ordered applicable. The copyright is ordered applicable in the independent in permitted without line for written content of ident Common Homes. Inc.

A CUSTOM RESIDENCE FOR Clare & James Fox of Mexico Drive | Longboat Key, Florida Manatee County

DRAWING TITLE:


SECOND LEVEL FLOOR PLAN

SHEET NUMBER:

SECOND LEVEL FLOOR PLAN

SCALE: 3/16" = 1'-0"

A2.2

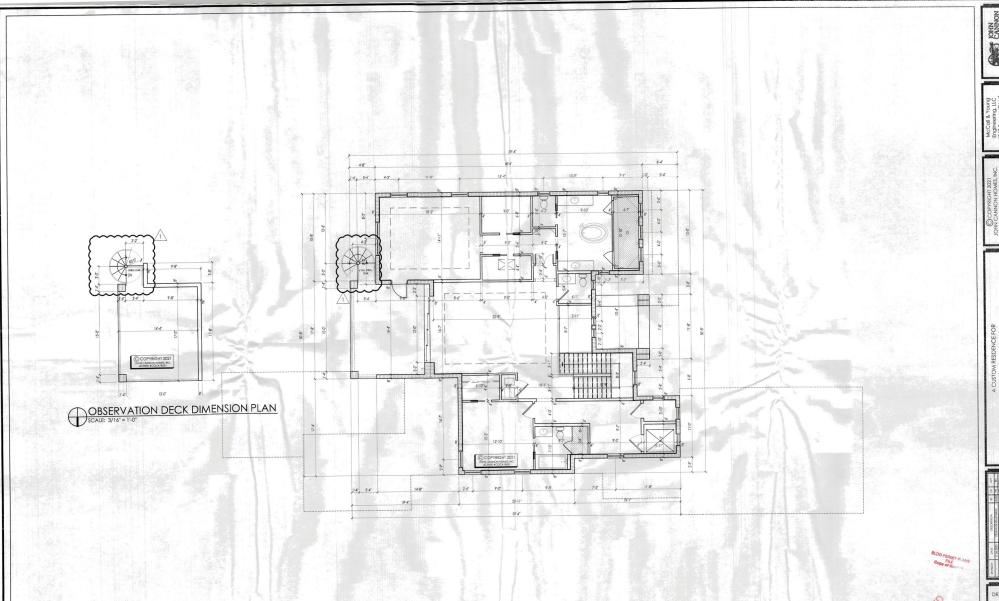

A REPORT OF THE PARTY OF THE PA

SECOND LEVEL DIMENSION PLAN

FIGURE CANTHON
FIGURE FOR THE PROPERTY OF T

MCCGII & Young Engineering, LLC 6849 Energy Court Sarasota, FL 34240 Tel: 941, 907, 9126 Fax: 941, 296,8227 FBPE # 26008

JOHN CANNON HOMES, INC., ICDNS CACCANSSIST Interdevel protected trade opposite copyrights, inclinated solids for other one year in reflective tradement of solids ordice one year of white tradement property oght. No other was solid without developed medicine correctively, accepted academically considerate corporation or extraoristic solid control tradement with pass within a consent of John Common Names. Inc.

A CUSTOM RESPENCE FOR

Clare & James Fox

5910 Gulf of Mexico Drive Longboot Key, Roided 1 34228


Manatee County

| 111.00 | 100.00 | 100.00 | 1

DRAWING TITLE:

SECOND
LEVEL
DIMENSION
PLAN

A2.3

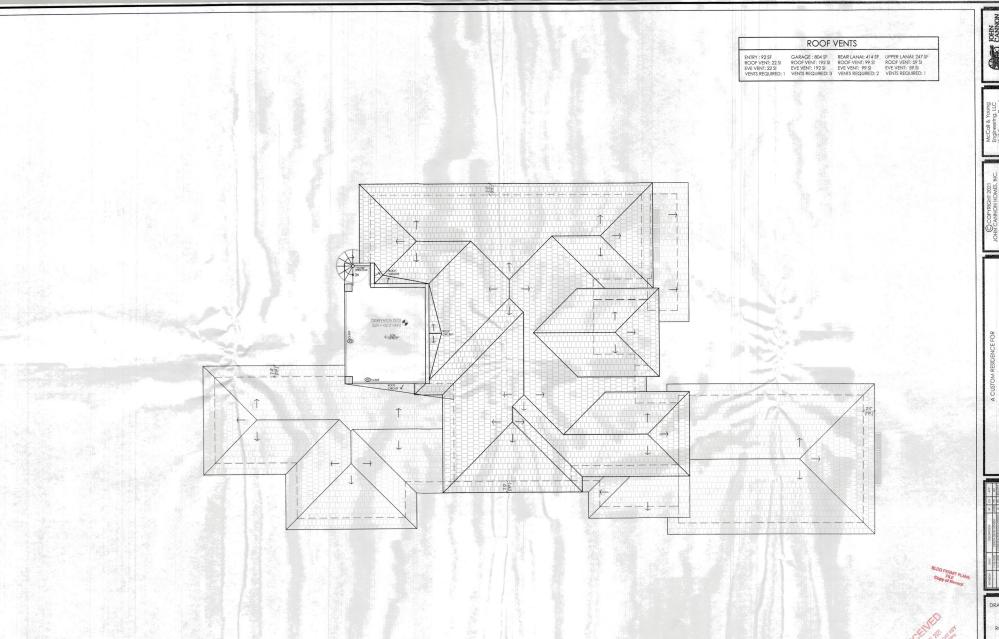

DOHN
CANNON
CANN

Engineering, LLC 6849 Energy Court Sarasola, Fl 34240 Tel: 941.907.9126 Fax: 941.296.8227 FBPE #26008

JOHN CANNON HOMES, INC., JUST AND CANNON HOMES. INC., JUST AND CANNON HOMES. INC., AND CANNON HOMES. TO CANNON HOMES. AND CANNON HOMES. TO CAN

A CUSTOM RESIDENCE FOR Clare & Jampes Fox of Mexico Drive I Longboat Key, Florida I 34228 Manatee County


| 100 | 100 
DRAWING TITLE:

SHEET NUMBER:

A3

ROOF PLAN
SCALE: 3/16" = 1'-0"

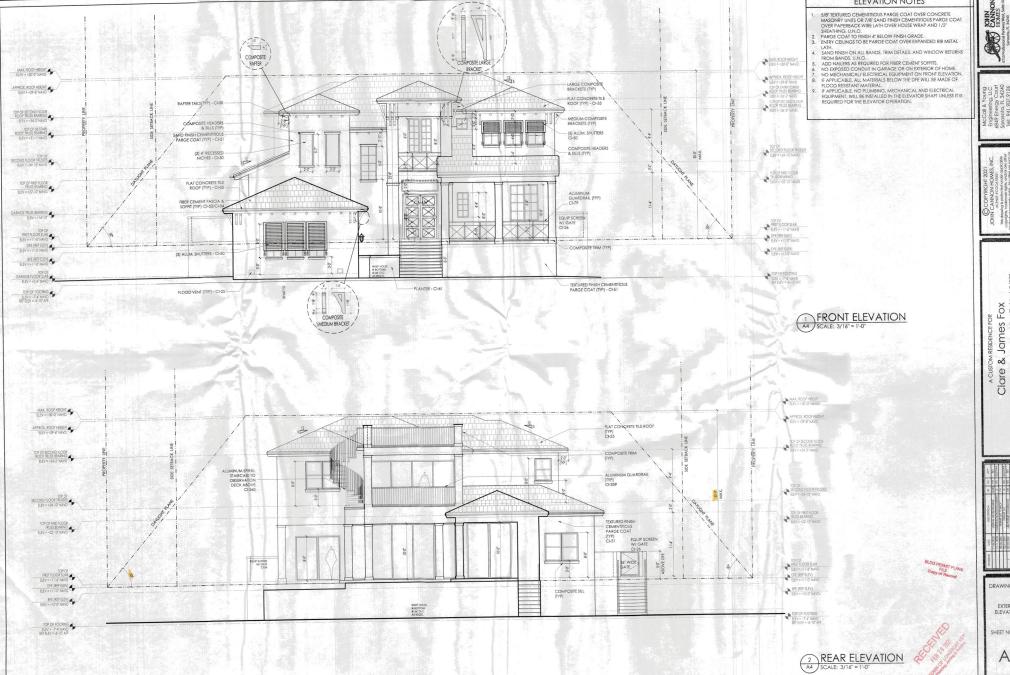

ELEVATION NOTES


& James Fox Clare

DRAWING TITLE


EXTERIOR ELEVATIONS

SHEET NUMBER

A4

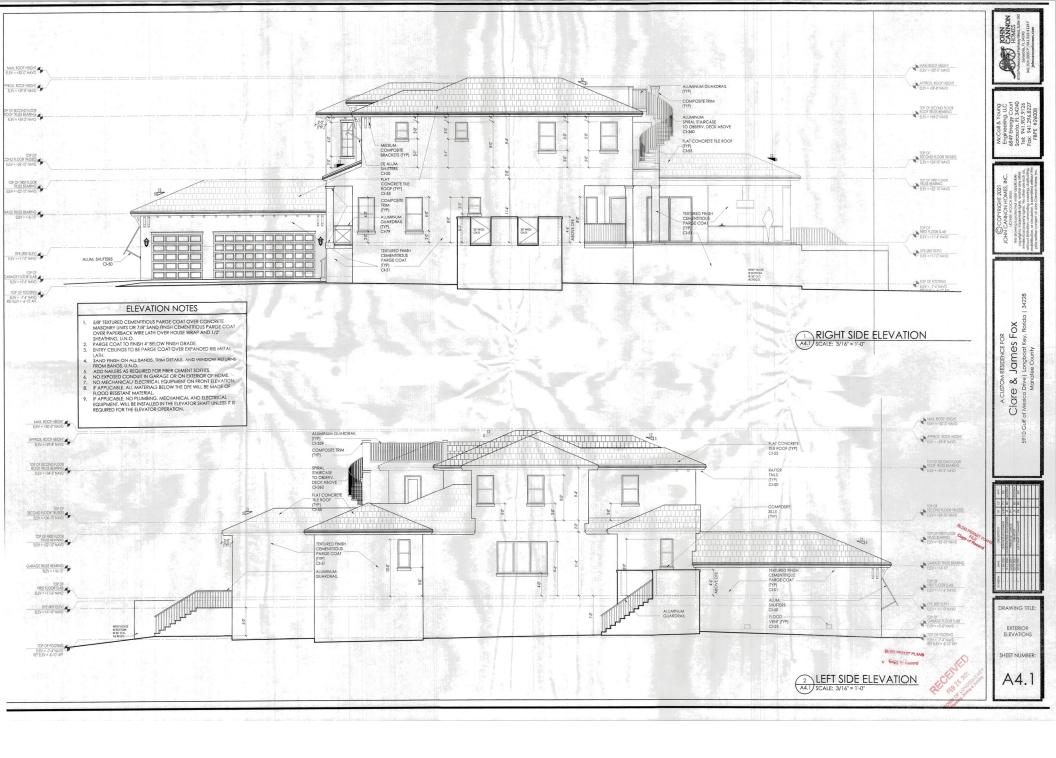



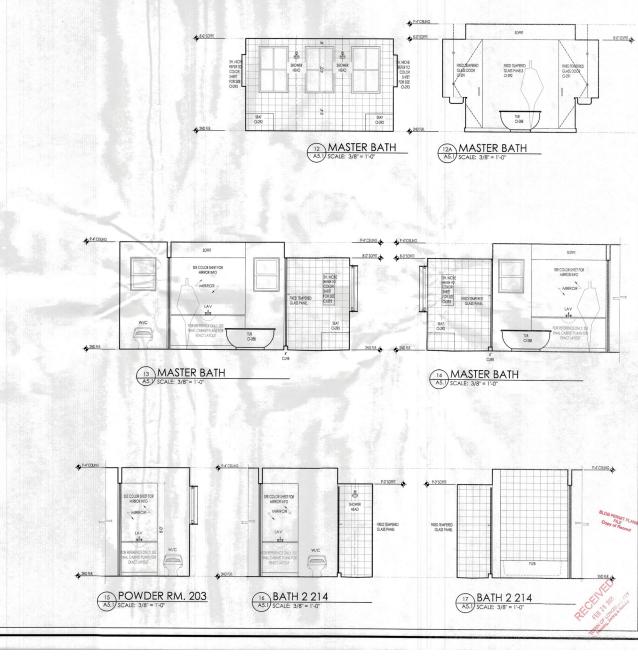

POLICE CANNON CANNON FOR THE PROPERTY OF THE P

Engineening, LLC 6849 Energy Court Sarasola, Fl. 34240 Tel: 941,907,9126 Fax: 941,296,8227 FBPE #26008

JOHN CANNON HOMES, INC.

IECHS ECCENTRES.

The drowing is protected under orpdicates
coppigation that bands and plant and ord value
independent proteins of plant in the original and order or the original and order or the original and order or coppigation and order or consideration in plant in the order or consideration in the order or co


A CUSTOM RESIDENCE FOR

Clare & James Fox
If of Mexico Dive Longboat Key, Florida | 34228
Monalee Coulty

DRAWING TITLE:

INTERIOR ELEVATIONS

A5.1

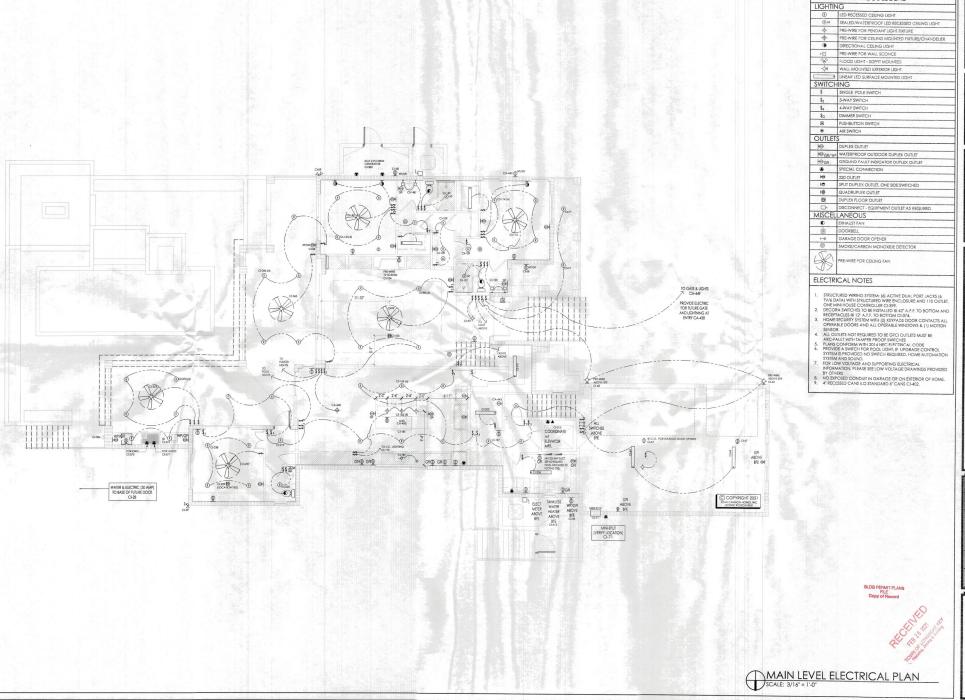

CANNON HOMES kway/West, Suite 100 Ft. 34240 9710 Professional Park

ELECTRICAL SYMBOL LEGEND

Clare & James Fox of Mexico Drive | Longboat Key, Florida | 34228

DRAWING TITLE:

MAIN LEVEL ELECTRICAL PLAN

SHEET NUMBER:

A6



ELECTRICAL SYMBOL LEGEND


A RESIDENCE FOR James Fox ∞ § Clare


DRAWING TITLE:


PLAN

SECOND LEVEL ELECTRICAL PLAN

A6.1

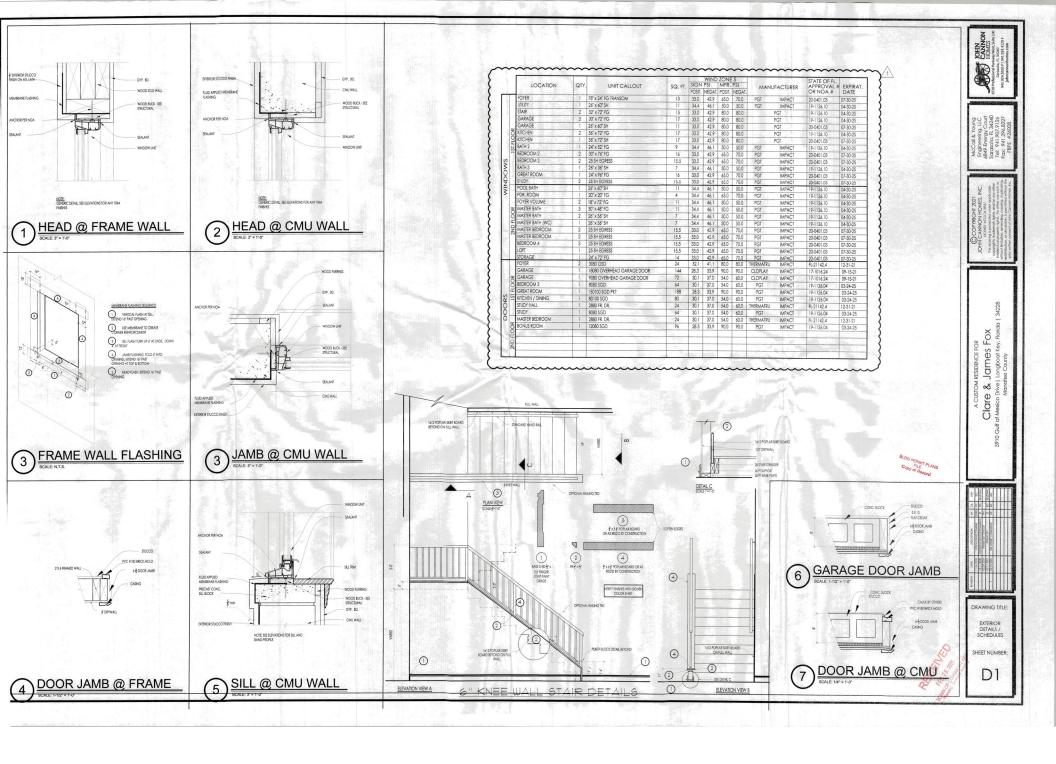

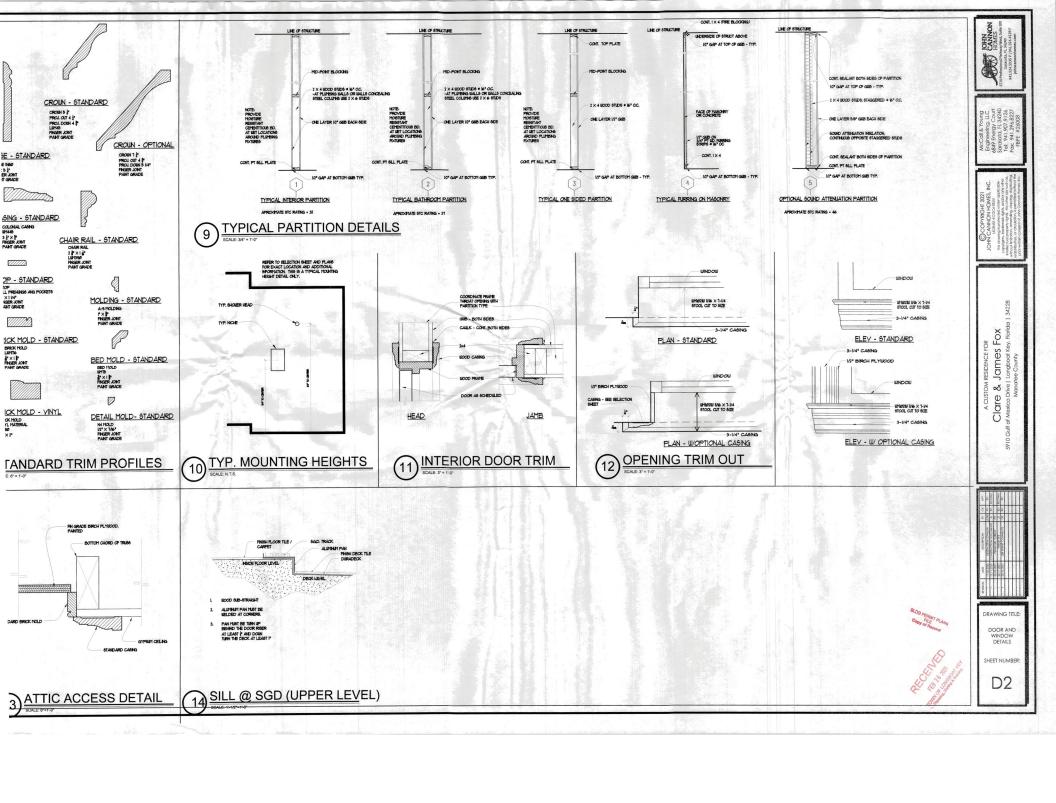

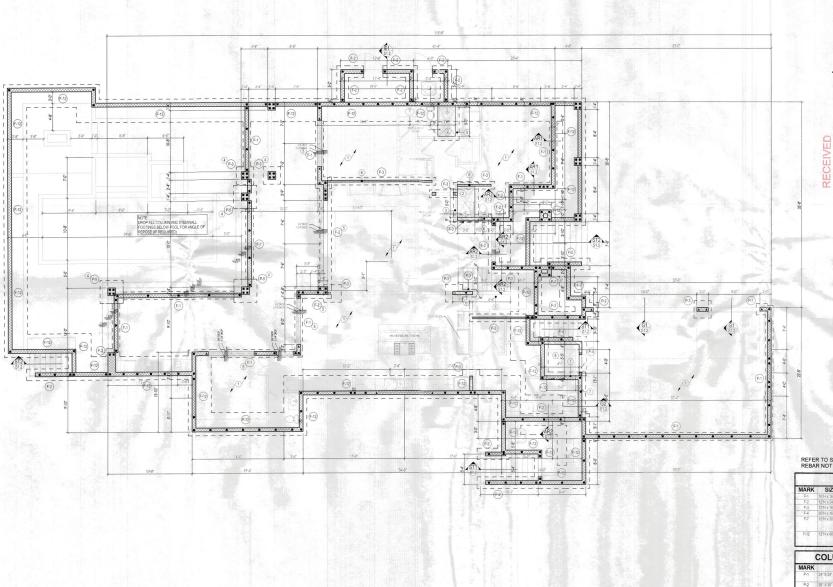

GENERAL NOTES

- SEE ARCHITECTURAL PLANS FOR DIMENSIONS NOT SHOWN ON STRUCTURAL SHEETS.
- 6. REINFORCEMENT IN FOOTINGS IS 3" FROM BOTTOM U.N.O.

FILLED CELLS LEGEND

INDICATES FILLED CELL w/ (2) #5 REBAR FROM FOOTING TO TIE BEAM STEEL.



34228

A New Residence for:
CLARE & JAMES FOX
5910 GULF OF MEXICO DRIVE, LBK, FL

PLAN

FOUNDATION 3/16" = 1'-0"

McCALL & YOUNG ENGINEERING, LLC

RECEIVED
FEB 16 2021
TOWN OF LONGBOAT KEY
Planting, Zoning & Building

THESE DRAWINGS HAVE BEEN ELECTRONICALLY SIGNED AND SEALED BY **STEPHEN E. HEDRICK II, PE,** USING A DIGITAL SIGNATURE. PRINTED COPIES OF THIS DOCUMENT ARE NOT CONSIDERED SIGNED AND SEALED. THE SIGNATURE MUST BE VERIFIED ON ANY ELECTRONIC COPIES.
SIGNED: STRUCTURAL ONLY

DATE SEALED: February 12, 2021

c=US.

o=Unaffiliated, ou=A01410D000001 76499A486E000043 4F, cn=Stephen E 2021.02.12 11:58:26 -05'00'

CONCRETE SLAB NOTES

KEYED NOTES

SLAB ON GRADE: 4" CONCRETE SLAB - SLOPE TO DRAIN AS REQUIRED.

SLAB: RECESS SLAB 4" AT SHOWER

SLAB: 8"W THICKENED EDGE w/ (1) #5 CONT.

TOP OF FOOTING: MINIMUM OF 6" BELOW GRADE.

RECESS ELEVATOR PIT PER MANUFACTURER'S SPECIFICATIONS


REFER TO SHEET S1.1 FOR ADDITIONAL STEMWALL REBAR NOT SHOWN ON FOUNDATION PAGE


FOOTING SCHEDULI			E
	SIZE//TYPE	REINFORCING	REMARKS
	10"H x 16"W STRIP FTG.	(2) #5s CONT.	
	12"H x 24"W STRIP FTG.	(3) #5s CONT.	
	12"H x 16"W THICK, SLAB	(2) #5s CONT.	
	20"H x 16"W THICK, EDGE	(2) #5s CONT.	
	12"H x 30" STRIP FTG.	7 COURSE STEMWALL. REFER TO DETAIL ON SHEET \$1.1	
	12"H x 48"W STRIP FTG.	12 COURSE STEMWALL	The State of the S


COLUMN FOOTING SCHEDULE					
MARK	SIZE	REINFORCING	REMARKS		
P-1	24" X 24" X 12"H PAD	(3) #5s EACH WAY	REFER TO TYP, PAD FOOTING DETAIL ON S1.1		
P-2	30" X 30" X 12"H PAD	(4) #5s EACH WAY	REFER TO TYP, PAD FOOTING DETAIL ON \$1.1		
P-3	36" X 36" X 12"H PAD	(5) #5s EACH WAY	REFER TO TYP, PAD FOOTING DETAIL ON \$1.1		
P-5	48" X 48" X 18"H PAD	(5) #5s EACH WAY	REFER TO TYP. PAD		


REVISIONS BY DATE

SHEET S1.0

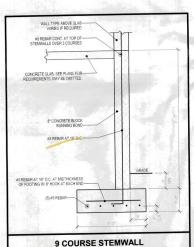

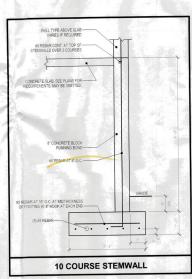

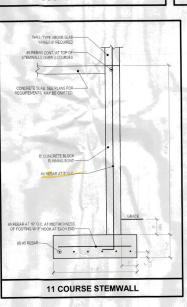

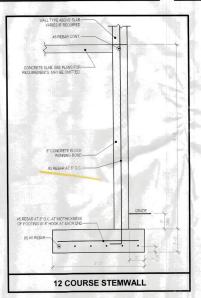

34228 A New Residence for:
CLARE & JAMES FOX
5910 GULF OF MEXICO DRIVE, LBK, FL

No. 8183

McCALL & YOUNG ENGINEERING, LLC


FOUNDATION DETAILS
3/4" = 1-0"

SEH 02.01.202 REVISIONS BY DATE

SHEET

RECEIVED
FEB 16 2021
TOWN OF LONGSOAT KEY
Pleasing, Zonna & Bulding

\$1.1

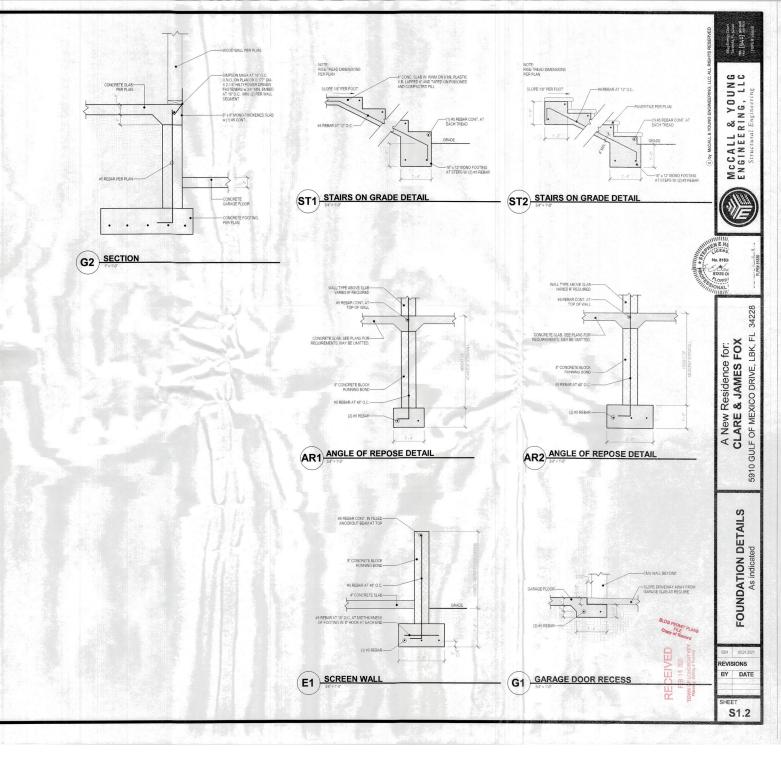


TYPICAL THICKENED SLAB FOOTING

FOOTER STEP DETAIL

SEE PLANS FOR REINFORCING

STD, 90° BEND-

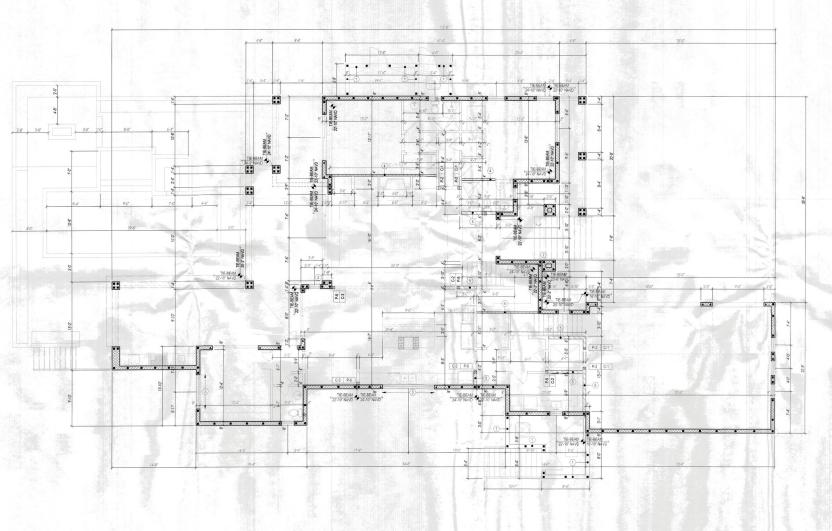

- MASONRY WALL: PROVIDE (1) #5 CONTINEOUS IN FULLY GROUTED COURSE AT TOP OF WALL
- MASONRY WALL: INTERLACE BUMP-OUT W ADJACENT MASON WALL.
- MASONRY WALL: PROVIDE (1) #5 CONTINUOUS IN FULLY GROUTED COURSE BENEATH OPENING. EXTEND 24" PAST OPENING OR TO THE END OF THE WALL
- 4 LOAD BEARING WALL: 2x4 SYP STUDS AT 16" O.C. TOP AT 11" 4" AFF
- 5 LOAD BEARING WALL: 2x6 SPF STUDS AT 16" O.C. TOP AT 11" 4" AFF
- 6 LOAD BEARING WALL: 2x6 SPF STUDS AT 16" O.C. BALLOON FRAME

FILLED CELLS LEGEND

INDICATES FILLED CELL w (2) #5 REBAR FROM FOOTING TO TIE BEAM STEEL.

No. 8183

POST SCHEDULE

ı	MARK	DESCRIPTION
	P-2	(1) 2x SPF KING STUD PLUS ADD'L (2) JACK STUD - MATO WALL THICKNESS
	D.C.	5.10" v 5.10" VERSAI AM 1.8 2750

CC	NNECTOR SCHEDULE
MARK	DESCRIPTION
C-1	(1) SIMPSON LTT19 w 5/6" ALL-THREAD DRILLED & EPOXIED 6" INTO FOOTING BELOW W SIMPSON SET EPOXY.
C-2	(1) SIMPONI LITTE W 60° ALL TUDEAD DDELED & EDOVED

REVISIONS BY DATE


S2.0

KEYED NOTES

McCALL & YOUNG ENGINEERING, LLC

A New Residence for:
CLARE & JAMES FOX
5910 GULF OF MEXICO DRIVE, LBK, FL

FIRST FLOOR STRUCTURAL PLAN 3/16" = 11-0"

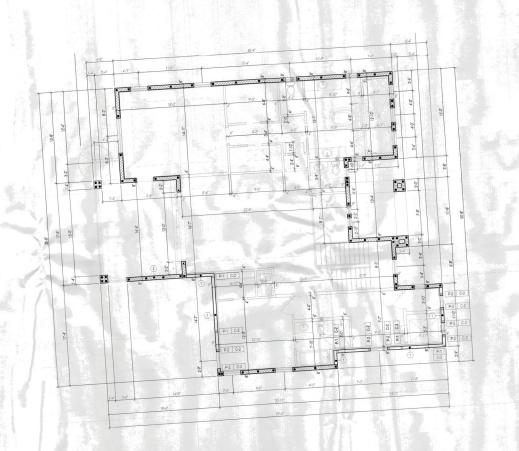



- 246 SPF OR BETTER AT 16" O.C. W 15/32" PLYWOOD SHEATHING W 86 NAILS AT 4" EDGE / 8" FIELD TOP AT 10-0" AFF
- 2 MASONRY WALL: PROVIDE (1) #5 CONTINEOUS IN FULLY GROUTED COURSE AT TOP OF WALL

McCALL & YOUNG ENGINEERING, LLC





POST SCHEDULE

	POST SCHEDULE
MARK	DESCRIPTION
P-1	(2) 2x SPF STUDS - MATCH WALL THICKNESS
P-2	(2) 2x SPF STUDS - MATCH THE ADD'L (2) JACK STUD - MAT WALL THICKNESS
-	E 418" v 5-114" VERSALAM 1.8 2750

CONNECTOR SCHEDULE

ARK

DESCRIPTION

DESCRIPTION

DESCRIPTION

DESCRIPTION


DESCRIPTION

A New Residence for: CLARE & JAMES FOX 5910 GULF OF MEXICO DRIVE, IBK, FL 34228

SECOND FLOOR STRUCTURAL PLAN

SEH 02.0
REVISION
BY D

RECEIVED FEB 16 2021 TOWN OF LONGSOAT WEY

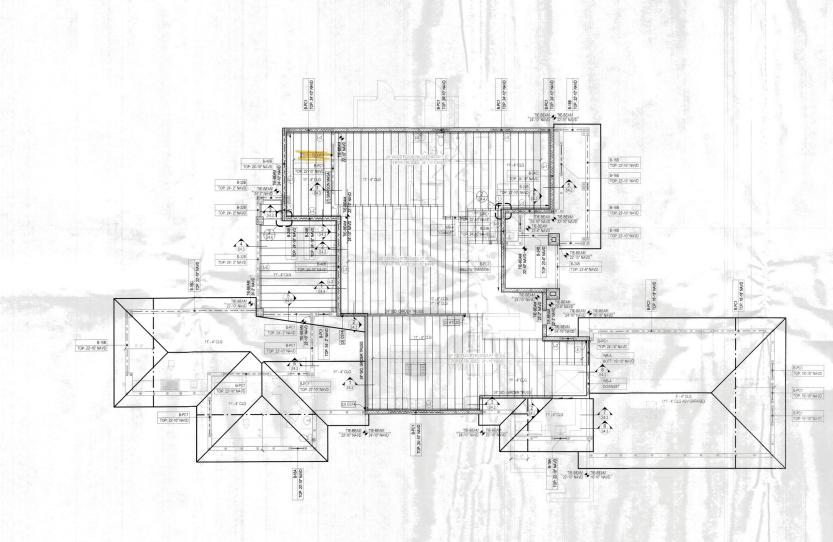

GENERAL NOTES

- 1. FILL ALL CELLS ABOVE PRECAST LINTELS
- STUB RAISED HEEL TRUSSES BACK 34" FROM FACE OF MASONRY FOR PLYWOOD AND STUCCO.
- ALL WOOD OR WOOD PRODUCTS IN CONTACT WITH CONCRETE OR MASONRY TO BE MOISTURE PROTECTED OR PRESSURE TREATED.
- ENTRY / LANAI / CABANA CEILINGS (AREAS EXPOSED TO WING PROVIDE 2rd BLOCKING AT 48° O.C. AT THE BOTTOM CHORD OF ALL TRUSSES. PROVIDE 15/32" EXTERIOR GRADE PLYWOOD SHEA THING WITH 66 HARS AT 4" EDGE 48" FIELD.
- ALL CONCRETE BEAMS AND PRECAST LINTELS 6' OR GREATER SHALL BE SHORED FOR A MINIAMAM OF 28 DAYS AFTER CONCRETE / GROUT HAS BEEN POURED.

STRUCTURAL NOTES

CONORETE BEAM: CANTILEVER BEAM, REINFORCEMENT SHALL EXTEND TO END OF WALL

HANGER: SIMPSON HU068 w/ (14) 1/4" x 1-3/4" SIMPSON TITEN2 TO CONCRETE.

RECEIVED
FEB 16 2021
TOWN OF LONGBOAT MEY
Flamming, Zonng 8 Budding

CONCRETE BEAM SCHEDULE

DESCRIPTION
8"x14" F&P CONCRETE BEAM
w/ (1)#5 TOP & (1)#5 BOTTOM

B-16A 8"x16" F8.P CONCRETE BEAM w/ (1)#5 TOP & (1)#5 BOTTOM

B-16B 8"x16" F8P CONCRETE BEAM W (2)46 TOP \$ (2)45 BOTTOM #3 TIES AT 6" O.C.

B-16C 8"x16" F8P CONCRETE BEAM W (2#5 TOP 8 (2#6 BOTTOM #3 TIES AT 6" C.C.

B-24B 8"x24" F&P CONCRETE BEAM w/ (2)#5 TCP & (2)#5 BOTTOM #3 TIES AT 10" O.C.

B-32B 8'x32' F&P CONCRETE BEAM W (2/#5 TOP & (2/#5 BOTTOM #3 TIES AT 12' O.C.

B-4/B 81W/01F8P CONCRETE BEAM W (2)45 TOP, (4)45 MIDDLE & (2)46 BOTTOM 4/3 TIES AT 12" C.C.

8" x 8" PRECAST BEAM w' (1) #5 CONT, FILLED SOLID w' 16" TIE-BEAM AT TOP OF WALL w' (1) #5 TOP & BOTT FILL ALL CELLS ABOVE PRECAST LINTEL.

WOOD BEAM SCHEDULE DESCRIPTION

LEDGER/RIM BOARD SCHED. MARK DESCRIPTION REMARKS (1) 2X8 PT LEDGER OR BETTER L-2 (2) 2X8 PT LEDGER OR



No. 8183

50

McCALL & YOUN ENGINEERING, LL

34228

A New Residence for:
CLARE & JAMES FOX
GULF OF MEXICO DRIVE, LBK, FL 5910

FIRST FLOOR FRAMING PLAN 3/16" = 1'-0"

REVISIONS BY DATE

SHEET S3.0

DRAG STRUT SCHEDULE

BLDG PERMIT PLANS
Copy of Record


MARK

DESCRIPTION WIND DRAG STRUT ROOF TRUSS TO TRANSFER SOOM FROM ROOF DIAMPRAGAM TO CAU WALL BELOW.

ALIAN DRAG STRUT TRUSS WITH THE EXTERNING FACE OF CAU WALL BELOW.

ATTACH DROTHOM CHORD OF TRUSS TO TOP OF WALL W/7 SUMPSON MASA AT 12" O.C. MINISTAN.

ATTACH FLYWOOD FLOOR SHEATHING ABOVE.
WITH 10d NAILS AT 4" O.C.

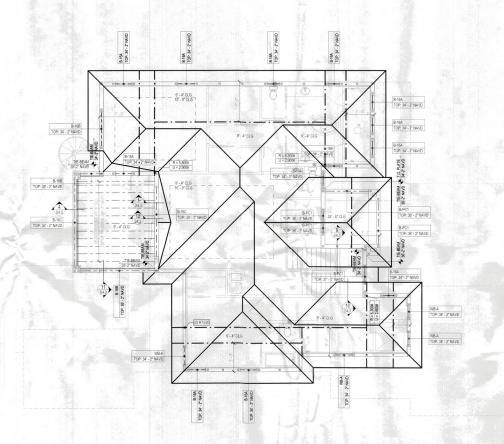

GENERAL NOTES

- 1. FILL ALL CELLS ABOVE PRECAST LINTELS.
- STUB RAISED HEEL TRUSSES BACK 3/4" FROM FACE OF MASONRY FOR PLYWOOD AND STUCCO.
- ALL WOOD OR WOOD PRODUCTS IN CONTACT WITH CONCRETE OR MASONRY TO BE MOISTURE PROTECTED OR PRESSURE TREATED.
- 4. ENTRY I LANA I CABANA CEILINGS (AREAS EXPOSED TO WINI PROVIDE 248 ELOCKING AT 48" O.C. AT THE BOTTOM CHORD OF ALL TRUSSES. PROVIDE 15/22" EXTERIOR GRADE PLYWOOD SHEATHING WITH 36 NAILS AT 4" EDGE 18" FIELD.
- ALL CONCRETE BEAMS AND PRECAST LINTELS 6' OR GREATER SHALL BE SHORED FOR A MINIMUM OF 28 DAYS AFTER CONCRETE / GROUT HAS BEEN POURED.

STRUCTURAL NOTES





MARK	DESCRIPTION
B-14A	8"x14" F&P CONCRETE BEAM W (1)#5 TOP & (1)#5 BOTTOM
B-16A	8"x16" F&P CONCRETE BEAM w/ (1)#5 TCP & (1)#5 BOTTOM
B-16B	8"x16" F&P CONCRETE BEAM w/(2)#5 TOP & (2)#5 BOTTOM #3 TIES AT 6" O.C.
B-16C	8'x16' F&P CONCRETE BEAM W (2)I6 TOP & (2)I6 BOTTOM #3 TIES AT 6" O.C.
B-24B	8'x24" F8P CONCRETE BEAM w/ (2)45 TOP 8, (2)45 BOTTOM #3 TIES AT 10" O.C.
B-24C	8"24" F&P CONCRETE BEAM w/ (2#5 TOP & (4#5 BOTTOM, BUNDLED #3 TIES AT 10" O.C.
B-32B	8"x32" F&P CONCRETE BEAM W (2)#5 TOP & (2)#5 BOTTOM

3	WOO	D BEAM SCHEDULE
3	MARK	DESCRIPTION

8"x40" F&P CONCRETE BEAM W (2M5 TOP: (4M5 MIDDLE & (2)46 BOTTOM #3 TIES AT 12" O.C.

MARK	DESCRIPTION	REMARKS
L1	(1) 2X8 PT LEDGER OR BETTER	SEE TRUSS PARALLEL TO LEDGER DETAIL



REVISIONS BY DATE

SHEET S3.1

McCALL & YOUNG ENGINEERING, LLC

34228 A New Residence for: CLARE & JAMES FOX 5910 GULF OF MEXICO DRIVE, IBK, FL

ROOF FRAMING PLAN 3/16" = 1'-0"

- FBC-R REFERS TO 2020 FLORIDA BUILDING CODE, 7TH EDITION, RESIDENTIAL.
- COMPACT BACK FILL 5'-0' FROM STRUCTURE. MINIMUM ALLOWABLE BEARING CAPACITY SHALL BE 2000PSF.
- CONTRACTOR TO VERIFY MANUFACTURED TRUSS PLAN PRIOR TO PLACEMENT OF STEMWALL OR MONOLITHIC FOOTING.
- PLUMBER IS TO INFORM SUPERINTENDENT OF ANY VENTING WHICH IS UTILIZES A MASONRY WALL TO RESOLVE ANY POSSIBLE STRUCTURAL INTEGRITY ISSUES.

CONCRETE / MASONRY NOTES

- ALL CONCRETE SHALL BE F'c = 3000 PSI.
- MASONRY SHALL USE TYPE S MORTAR, Fm = 1900 PSI.
- REINFORCING STEEL SHALL SATISFY ASTM A615, GRADE 60. FOOTINGS MAY USE GRADE 40.
- WHERE INDICATED ON FLOOR PLANS, PROVIDE CONCRETE FILLED CELL WITH REINFORCING STEEL FROM FOOTING TO THE BEAM HOOKED A TIED BEFORE INSPECTION. IF GROUT LIFT EXCEEDS 4/07, AM INSPECTION HOLE TO VERIFY GROUTING SHALL BE PROVIDED AT THE BOTTOM CELL.
- PROVIDE (1) #5 VERTICAL REINFORCING STEEL ELECTRICAL GROUND TO FOUNDATION STEEL.
- FOUNDATION DOWELS AND VERTICAL REINFORCING SPACES AS SHOWN ON FLOOR PLANS. IN THE EVENT OF CONFLICTS, THE FLOOR PLANS SHALL TAKE PRECEDENCE OVER THE FOUNDATION PLAN ALL FOOTINGS TO BE SMOOTH AND LEVEL.
- LAP LENGTH OF INDIVIDUAL BARS WITHIN A BUNDLE SHALL BE THAT FOR TI INDIVIDUAL BAR. INCREASED 20% FOR THREE-BAR BUNDLE, AND 33% FOR FOUR-BAR BUNDLE.
- A FILLED CELL WITH (1) #5 VERTICAL SHALL BE LOCATED AT GIRDER TRUSSES WITH UPLIFT EXCEEDING 2000LBS U.N.O.
- MINIMUM CONCRETE COVER 3" CAST AGAINST SOIL AND 1-1/2" ELSE U.N.O. MAXIMUM CONCRETE COVER 6" U.N.O.
- EMBEDDED TRUSS ANCHORS SHALL BE INSTALLED IN ACCORDANCE WITH MANUFACTURER'S REQUIREMENTS.
- EMBEDDED ANCHORS/TIEDOWNS SHALL MIN 2" COVER.
- MASONRY WALLS SHALL BE BRACED IN ACCORDANCE WITH "STANDARD PRACTICE FOR BRACING MASONRY WALLS UNDER CONSTRUCTION" MASON CONTRACTORS ASSOCIATION OF AMERICA, JULY 2001.
- THE CONCRETE TIE BEAM AT THE TOP OF ALL WALLS SHALL BE AN 8" X 16" WITH (1) #5 CONTINUOUS TOP AND BOTTOM.
- BEAM SIZES SHOWN ON DRAWINGS ARE MINIMUM NOMINAL DIMENSIONS.
 BEAMS SIZES MAY BE INCREASED BY UP TO 12" TO ACCOMMODATE ON-SITE
 BEAM REQUIREMENTS PROVIDED THAT THE DISTANCE BETWEEN THE TOP AND
 BOTTOM REINFORCING STEEL REMAINS THE SAME OR IS INCREASED.
- REINFORCING STEEL LAP LENGTH IN CONCRETE AND/OR MASONRY SHALL BE:

FRAMING NOTES

- ALL DOOR HEADERS AT BEARING WALLS TO BE (2) 2X10 SYP OR BETTER.
- EXTERIOR FRAME WALLS, BEARING OR NON-BEARING SHALL BE SHEATHED WITH 15/32" PLYWOOD OR EQUAL. BLOCKED AND NAILED WITH 8d NAILS AT 4" O.C. EDGES, 8" O.C. FIELD.
- SHEAR WALL AND EXTERIOR WALL PLYWOOD SHEATHING SHALL BE BLOCKED.
- TRUSSES AND BEAMS SHALL BEAR DIRECTLY ON PSL OR SYP POSTS, U.N.O. WHERE REQUIRED, SHIMS TO BE A36 STEEL U.N.O.
- PSL OR SYP POST SHALL BEAR DIRECTLY ON CONCRETE SLAB OR ON SYP OR PT PLATE U.M.O.
- UPLIFTS AND REACTIONS SHOWN ON MANUFACTURED TRUSS PLANS SHALL BE USED U.N.O. ON ENGINEER'S SEALED ROOF/FLOOR LAYOUT PLAN.
- BUILD-OUTS SHALL BE ATTACHED TO THE MASONRY/CONCRETE WITH 3/16" TAPCONS AT 16" O.C. WITH MINIMUM EMBEDMENT OF 1-3/6".
- FLOOR SHEATHING SHALL BE 34" PLYWOOD SHEATHING OR EQUAL. FASTEN WITH 10d NAILS AT 4" O.C. EDGES AND 8" O.C. FIELD U.N.O.

ROOF FRAMING NOTES

- THE DESIGN OF ROOF FRAMING SHALL BE BASED ON THE REQUIREMENTS OF THE FBC-R.
- DESIGN WIND LOADS SHALL BE APPLIED IN ACCORDANCE WITH FBC SECTION 1609. SEE WIND NOTES FOR WIND DESIGN REQUIREMENTS.
- ROOF TRUSS MANUFACTURER SHALL SUBMIT AND PROVIDE COMPLETE LAYOUT AND FURMISH THE POLLOWING INFORMATION: ROOF PITCH, LUMBER SIZE, SPACING, SPECIES AND GRADING, LOCATION AND MAGNITUDE OF UPUIFT LOADS.
- PRE-ENGINEERED TRUSS DESIGN SHALL BE SIGNED AND SEALED BY A FLORIDA LICENSED PROFESSIONAL ENGINEER.
- ROOF SHEATHING SHALL BE 19/32" CD PLYWOOD SHEATHING OR EQUAL, FASTENED WITH 88 FING-SHAMK NAILS AT 4" O.C. EDGES AND 6" O.C. FIELD WITHIN 4-4" OF PILOGES AND EDGES OF ROOF AND 3" O.C. WITHIN 4-4" OF EXTERIOR ROOF CORNERS.
- CONTRACTORS SHALL VERIFY WITH ROOF TRUSS PLAN PRIOR TO PLACEMENT OF FOOTINGS.

WOOD NOTES

- PSL: 1.8E PARALLEL STRAND LUMBER, Fb = 2400 PSI.
- 2 LVL: 1.9E LAMINATED VENEER LUMBER. Fb = 2600 PSL
- 3. PT: PRESSURE TREATED SOUTHERN PINE #2 GRADE OR BETTER
- SPF: SPRUCE PINE FIR #2 GRADE OR BETTER.

DESIGN LOADS AND NOTES

- 55PSF W: 1.33 STRESS INCREASE FACTOR, OI 45PSF W: 1.25 STRESS INCREASE FACTOR, OI 41PSF W: 1.00 STRESS INCREASE FACTOR.
- FLOOR TRUSSES D + L
 A. 66PSF W/ 1.00 STRESS INCREASE FACTOR.
- 3. DL = 10 PSF IN COMBINATION WITH WIND LOADS.
- 4. MEAN ROOF HEIGHT SHALL BE DETERMINED BY CONTRACTOR.
- 5. LATERAL LOADS AT TOP OF EXTERIOR WALLS SHALL BE BASED ON 40.4 PSF ON WALL.
- LATERAL LOADS IN TRUSSES ARE RESISTED BY ROOF DIAPHRAGM AT POINT OF WIND LOAD INPUT U.N.O.
- TRUSS MANUFACTURER'S TRUSS LAYOUT SHALL SHOW ALL CONNECTIONS BETWEEN TRUSSESS AND OTHER TRUSSES AND BETWEEN TRUSSES AND WOOD BEAMS.
- TRUSSES MUST BE DESIGNED TO SUPPORT WALLS AGAINST OUT-OF-PLANE LOADS IN ACCORDANCE WITH ITEM 5. THIS APPLIES TO ALL TRUSSES WITH A RAISED HEEL CONDITION THAT BEAR ON EXTERIOR WALLS. NO PROVISIONS HAS BEEN MADE IN THE STRUCTURAL DESIGN FOR TEMPORARY CONDITIONS OCCURRING DURING CONSTRUCTION, UNLESS SPECIFICALLY NOTED ON THE STRUCTURAL DRAWNINGS. THE CONTRACTO SHALL PROVIDE ALL NECESSARY SHORING AND BRACKING REQUIRED TO SHALL PROVIDE ALL NECESSARY SHORING AND BRACKING REQUIRED TO CONSTRUCTURAL TO CONTRACTOR SHALL ASSUME COMPLETE RESPONSIBILITY FOR SUCH MESSURES.

WIND NOTES

- WIND LOADS ARE BASED ON A WIND VELOCITY OF 160 MIPH APPLIED FOR A FULLY PINLOSED STRUCTURE.

 THIS BUILDING IS DEGISIED AS FULLY ENCLOSED BUILDING BASED ON ALL OPENINGS BEING PROTECTED OR HAVING MISSIE IN MACT GLASS.

 WIND DESIGN LOADS WERE DETERMINED BASED ON THE FOLLOWING:

 BASIC WIND SPEED:

 150 MPH.

WIND EXPOSURE
INTERNAL PRESSURE COEFFICIENT: .18
FULLY ENCLOSED BUILDING

DESIGN WIND PRESSURES FOR COMPONENTS AND CLADDING

NEGATIVE PRESSURE = OUTWARD ALL PRESSURE VALUES ARE IN PSF

	COMPONENT AREA (SQ. FT.)	ZONE 4	ZONE 5
-	10	+42.27-45.9	+42.27-56.6
	20	+39.87-44.0	+39.8 / -52.7
-	30	+39.57-43.0	+39.5 / -50.6
-	40	+38.37-41.9	+38.3 / -49.0
1357	50	+38.07-41.6	+38.0 / -47.7
á	75	+36.97-40.5	+36.9 / -45.5
	100	+35.97-39.5	+35.9 / -44.1
	150	+34.87-38.4	+34.8 / -41.6

PEST/DECAY PROTECTION NOTES

- SOIL TREATMENTS FOR TERMITES SHALL MEET THE REQUIREMENTS OF FBC SECTION R320. SENTRICON SHALL BE USED.
- WOOD GRADE STAKES SHALL NOT BE USED.
- PROTECTION AGAINST DECAY AND TERMITES SHALL BE PROVIDED IN ACCORDANCE WITH FBC SECTIONS R317 AND R318.
- ROOF FLASHING SHALL BE PROVIDED IN ACCORDANCE WITH THE REQUIREMENTS OF FBC SECTIONS R7G3.7.5, R7G3.8, R9G3.2 AND R9G5.

GARAGE NOTES

- OPENINGS FROM GARAGE INTO LIVING SPACE OF RESIDENCE SHALL MEET THE REQUIREMENTS OF FBC SECTION R302.5.1.
- DUCTS IN THE GARAGE AND DUCT PENETRATING THE WALLS OR CEILINGS SEPARATING THE DWELLING FROM THE GARAGE SHALL MEET THE REQUIREMENTS OF FBC SECTION R302.5.2.
- GARAGE AND LIVING SPACE SEPARATION SHALL MEET THE REQUIREMENTS OF FBC SECTION R302.6.
- GARAGE DOORS SHALL SATISFY THE REQUIREMENTS OF FBC FOR WIND LOADS AS DEFINED IN ROOF FRAMING AND WIND NOTES.

GENERAL CONNECTIONS NOTES

- CONNECTIONS SHOWN ARE RECOMMENDED, BUT OTHER CONNECTORS MAY BE SUBSTITUTED AS LONG AS THEY MEET OR EXCEED THE UPLIFTS AND LATERAL CAPACITY OF THE AMENDES SECURED AND SATISFY TRUSS LAYOUT REQUIREMENTS COMPLANCE WITH USP. SIMPSON OR OTHER MANUFACTURES RECOURSEMENTS.
- FOR ADDITIONAL TIE DOWN INFORMATION, SEE SIMPSONS OR USP CATALOGS.
- FOR POST-INSTALLED ANCHORS: HOLE PREPARATION, CARTRIDGE PREPARATION, AND EPOXY FILLING SHALL BE PERFORMED PER MANUFACTURERS ADHESIVE ANCHOR INSTALLATION INSTRUCTIONS.
- AN EPOXY INSPECTION MAY BE REQUIRED DEPENDING ON JURISDICTION, CONTRACTOR MUST VERIFY.

TRUSS UPLIFT ANCHORS - MASONRY / CONCRETE

TRUSS ANCHORS TO MASONRY OR CONCRETE BE AS POLICIVIS.

(RECERT TO SIMPSON 2015-16 CATALOG NC-2019)

OTHER BRANDS OF CONNECTORS INVESTIGATION FOR SITUATION FROM UPUFIT AND LATERAL LOAD CAPACITIES ARE EQUAL OR GREATER THAN CONNECTORS SPECIFIED.

TYPE MEMBER	NOMINAL UPLIFT CAPACITY	CONNECTOR TYPE	PRODUCT APPROVAL#	NAILS TO TRUSS FOR NOMINAL UPLIFT	NOTES AND COMMENTS
SINGLE PLY, CMU	595#	SIMPSON HM9KT	FL11473.6	(4) SDS 1/4" X 1-1/2" LONG TO TRUSS AND (5) 1/4" X 2-1/4" SIMPSON TITEN SCREW TO CMU	POST INSTALLED
SINGLE PLY, CONCRETE	5954	SIMPSON HM9KT	FL11473.6	(4) SDS 1/4" X 1-1/2" LONG TO TRUSS AND (5) 1/4" X 1-3/4" SIMPSON TITEN SCREW TO CMU	POST INSTALLED
	1065#	SIMPSON H10S	FL11478.4	(8) 8d X 1-1/2" LONG TO TRUSS AND (2) 3/8" X 4" SIMPSON TITEN SCREW TO CMU	POST INSTALLED
	1450#	SIMPSON META12	FL11473.3	(7) 10d x 1-1/2" LCNG	D 300 1 14.
	1520#	SIMPSON HETA12	FL11473.3	(7) 10d x 1-1/2" LCNG	- C. SAGE 181
SINGLE PLY	18100	SIMPSON HETA16	FL11473.3	(9) 10d x 1-1/2" LONG	
	1810#	SIMPSON HETA20	FL11473.3	(9) 10d x 1-1/2" LONG	
	1985#	(2) SIMPSON META12	FL11473.3	(10) 10d x 1-1/2" LONG	NOTE 1
	2035#	(2) SIMPSON HETA12	FL11473.3	(10) 10d x 1-1/2" LCNG	NOTE 1
	2035#	(2) SIMPSON HETA20	FL11473.3	(10) 10d x 1-1/2" LCNG	NOTE 1
SINGLE OR MULTI-PLY.	860#	SIMPSON MTSM16 EA TRUSS • SIMPSON HGAM AT 48" O.C.	FL11473.11 FL11473.6	(7) 10d TO TRUSS AND (4) 1/4" x 2-1/4" SIMPSON TITEN SCREW TO CMU	POST INSTALLED, MISSING EMBEDS
CMU	1175#	SIMPSON HTSM16 EA TRUSS + SIMPSON HGAM AT 48" O.C.	FL11473.11 FL11473.6	(8) 10d TO TRUSS AND (4) 1/4" x 1-3/4" SIMPSON TITEN SCREW TO CONCRETE	POST INSTALLED, MISSING EMBEDS
SINGLE OR MULTIPLY, CONCRETE	860#	SIMPSON MTSM16 EA TRUSS + SIMPSON HGAM AT 48" O.C.	FL11473.11 FL11473.6	(7) 10d TO TRUSS AND (4) 1/4" x 1-3/4" SIMPSON TITEN SCREW TO CONCRETE	POST INSTALLED, MISSING EMBEDS
	1175#	SIMPSON HTSM16 EA TRUSS + SIMPSON HGAM AT 48" O.C.	FL11473.11 FL11473.6	(8) 10d TO TRUSS AND (4) 1/4" x 1-3/4" SIMPSON TITEN SOREW TO CONCRETE	POST INSTALLED. MISSING EMBEDS
SINGLE OR MULTI PLY	3330#	SIMPSON MGT	FL11470.7	(22) 10d x 1-1/2" LCNG	NOTE 2
	2150#	SIMPSON LGT2	FL11470.6	(16) 10d SINKERS	POST INSTALLED, NOTE 4
DOUBLE PLY	10980W	SIMPSON HGT-2	FL10456.10 FL10866.10	(16) 10d	NOTE 3
DOUBLE OR TRIPLE	1900W	(2) SIMPSON META12	FL11473.3	(14) 16d	NOTE 1
PLY, CMU	2500#	(2) SIMPSON HETA12	FL11473.3	(12) 16d	NOTE 1
2 2 2	2565#	(2) SIMPSON META12	FL11473.3	(14) 16d	NOTE 1
DOUBLE OR TRIPLE PLY, CONCRETE	2700#	(2) SIMPSON HETA12	FL11473.3	(12) 16d	NOTE 1
	3350#	(2) SIMPSON HHETA12	FL11473.9	(14) 16d	NOTE 1
	3285#	SIMPSON LGT3-SDS2.5	FL11470.6	(12) SBS 1/4" x 2-1/2" LONG	POST INSTALLED, NOTE 5
TRIPLE PLY	10530W	SIMPSON HGT-3	FL10456.19 FL10866.10	(16) 10d	NOTE 3
QUAD PLY	9250#	SIMPSON HGT-4	FL10456.20 FL10866.10	(16) 10d	NOTE 3
	1450#	SIMPSON META12	FL11473.3	(6) 16d	State
MULTI PLY	1520#	SIMPSON HETA12	FL11473.3	(7) 16d	
	1810#	SIMPSON HETA16	FL11473.3	(8) 16d	

TRUSS/FRAME CONNECTION NOTES

NOMINAL UPLIFT CAPACITY COMMISSION TYPE FASTENER TO POST FOR

POST UPLIFT ANCHORS - MASONRY / CONCRETE

POST ANDIDIOS TO MACOWNY OR CONCRETE SHALL BE AS FOLLOWS
(REFERT OR SHAMON ADOS ADOS ADOS AND CATALOG ACCOMP)
OTHER REANIDS OF CONNECTORS MAY BE SUBSTITUTED IF BOTH UPLIFT AND LATERAL LOAD CAPACITIES ARE EQUAL OF
REATER THAN.

THICKNESS	FOR SYP OR BETTER	CONNECTOR TYPE	NOMINAL UPLIFT	ANCHOR BOLT DIAMETER
	1310e	SIMPSON LTT19	(8) 10d x 1-1/2" LONG NAILS	1/2", 5/8" OR 3/4"
	1350#	SIMPSON LTTI31	(18) 10d x 1-1/2" LCNG NAILS	5/8"
1-1/2"	3610#	SIMPSON HTT4	(18) 10d x 1-1/2" LONG NAILS	5/8"
	4350#	SIMPSON HTT5	(26) 10d x 1-1/2" LONG NAILS	5/8"
	2405#	SIMPSON HD5	(2) 3/4" DIA, STUD BOLTS	5/8" OR 3/4"
2-1/2"	3955#	SIMPSON HTT16	(18) 10d x 1-1/2" LONG NAILS	5/8"
	4235#	SIMPSON HTT4	(18) 10d x 1-1/2" LONG NAILS	5/8"
	5090#	SIMPSON HTT5	(26) 10d x 1-1/2" LCNG NAILS	5/8"
	3835#	SIMPSON HD5	(2) 34° DIA. STUD BOLTS	5/8" OR 3/4"
3"	4165#	SIMPSON HTT22	(32) 10d NAILS	5/8"
	4670#	SIMPSON HTT5	(26) 10d NAILS	5/8"
	6480¢	SIMPSON HD5	(3) 7/8" DIA. STUD BOLTS	7/8" OR 1"
	50100	SIMPSON HD5	(2) 3/4" DIA. STUD BOLTS	3/4*
3-1/2"	6480#	SIMPSON HD7	(3) 7/8" DIA. STUD BOLTS	7/8" OR 1"
3-02	10330#	SIMPSON HD9	(3) 1" DIA. STUD BOLTS	7/8" OR 1"
	11350#	SIMPSON HD12	(4) 1" DIA. STUD BOLTS	de P

1. 1/2" DAM/ETER A307 ALL THREAD SET IN 9/16" DAM/ETER HCLE WI SIMPSON SET EPCXY, MIN EMBED 5"
2. 58 DAM/ETER A307 ALL THREAD SET IN 3/19" DAM/ETER HCLE WI SIMPSON SET EPCXY, MIN EMBED 3"
3. 34" DIAM/ETER A307 ALL THREAD SET IN 3/19" DAM/ETER HCLE WI SIMPSON SET OR COLUL, MIN EMBED 6"
4. 1" DIAM/ETER A307 ALL THREAD SET IN 118" DIAM/ETER HCLE WI SIMPSON SET OR ECULAL, MIN EMBED 6"

MULTIPLE MEMBER CONNECTION FOR 1.9E MICROLLAM LVL BEAMS



MINIMUM (2) ROWS OF 12d NAILS AT 12" O.C. FOR MEMBERS LESS THAN 14" DEEP MINIMUM (3) ROWS OF 12d NAILS AT 12" O.C. FOR MEMBERS GREATER THAN 14" DEEP

1.34" WILE: (3) ROWS OF 12t NAILS AT 12" O.C.; OR (2) ROWS OF 1/2" BOLTS AT 12" O.C.; OR (2) ROWS OF 1/4" X 3-1/2" LAG SCREWS AT 12" O.C.

- 1-3/4" WIDE: (2) ROWS OF 1/2" BOLTS AT 12" O.C.; OR (2) ROWS OF 1/4" X 6" LAG SCREWS AT 12" O.C.

NOTES: A 307 BOLTS WITH WASHERS REQUIRED. BOLT HOLES TO BE 9/16" DIA. SCREWS MUST HAVE SELF-DRILLING TIPS AND MINIMUM BENDING YIELD STRENGTH

OF 217,000 PSI. 6" LONG SCREWS REQUIRED CONNECTION INSTRUCTIONS ON PLAN SUPERSEDE PRECEDING.

WATERPROOFING NOTES

- ROOF TRUSSES: USE SIMPSON HIGA OR HIGA-2 AT EACH TRUSS WHERE POSSIBLE. PROVIDE ADDITIONAL THE DOWNS FOR UPLIETS IN EXCESS OF GIVEN ALLOWING VALUES. WHERE HIGA OR HIGA-2 CANNOT BE USED [EX. 3-BLY GIRDERS, CORNERS, ETC), USE SIMPSON H2-SA PLUS ADDITIONAL TIE-DOWNS AS REQUIRED TO MEET PUPIE FLOXES. SHING AND WATERPROOFING IS THE RESPOSIBILITY OF THE
- FLOOR TRUSSES: USE SIMPSON H2.5A. AT EACH TRUSS (WITH OR WITHOUT UPUIFT) WHERE POSSIBLE. PROVIDE ADDITIONAL TIE-DOWN AS REQUIRED TO MEET UPLIFT LOADS.

TYPICAL WALL SECTION NOTES

- INSTALLATION OF LATH SHALL MEET THE REQUIREMENTS OF SECTION R703.7.1 OF THE FBC-R.
- PLASTERING WITH PORTLAND GEMENT PLASTER SHALL MEET THE REQUIREMENTS OF SECTION R703.7.2 OF THE FBC-R.
- INSTALLATION OF WATER RESISTIVE BARRIER SHALL MEET THE REQUIREMENTS OF R/03.7.3 OF THE FBC-R.
- INSTALLATION OF FLASHING SHALL MEET THE REQUIREMENTS OF R703.4 OF THE FBC-R.

DRAFTSTOPPING NOTES

- SHALL BE PROVIDED AND INSTALLED SO THAT THE AREA OF THE CONCEALED SPACE DOES NOT EXCEED 1,000 SQ. FT AND INSTALLED PER FBC-R302.12.
- DRAFTSTOPPING SHALL DIVIDE THE CONCEALED SPACE INTO APPROXIMATELY EQUAL AREAS.
- 3. DRAFTSTOPPING MATERIAL SHALL BE IN ACCORDANCE WITH FBC-R302.12.1


-COMPONENT AREA (SQ. FT.)




DESIGN WIND PRESSURES FOR

COMPONENT AND CLADDING

EXTERIOR CEILING NOTES

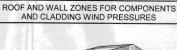

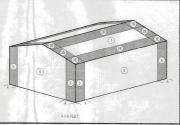



SHEET

50 Z 5-0

> 5 Z ∞ ~ _ 1 CAL UZ Zω

NEW E HE STATE OF

34228


for: FOX LBK, F Residence & JAMES F DRIVE, MEXICO [A New F CLARE A GULF


5910


GENERAL STRUCTURAL ON NOTES


REVISIONS BY DATE


\$4.0

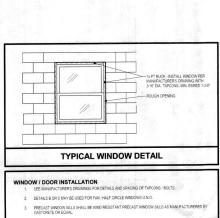

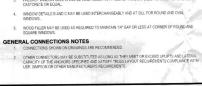

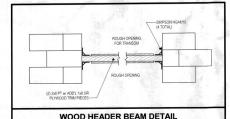

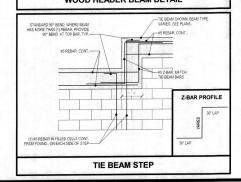

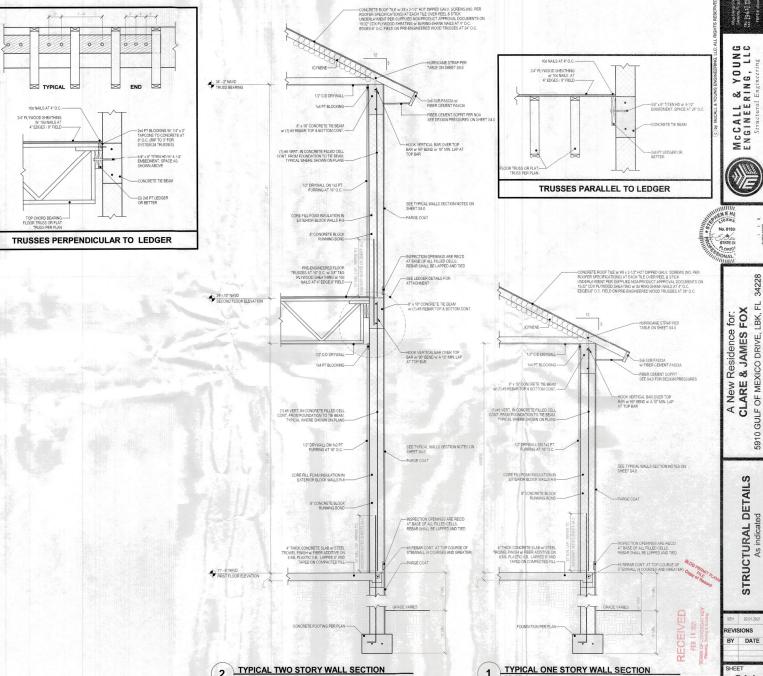

UNG MCCALL



34228


/ Residence for:


8. JAMES FOX


EXICO DRIVE, LBK, FL A New Residence of CLARE & JAMES FOLF OF MEXICO DRIVE, LI


BY DATE


S4.1

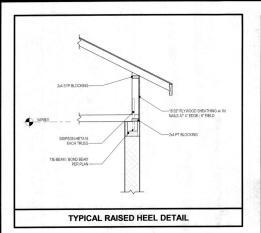

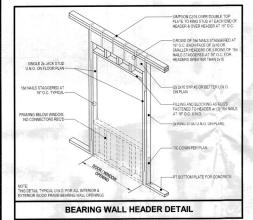

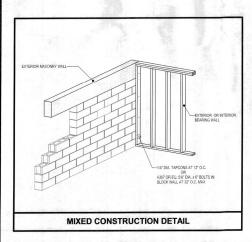


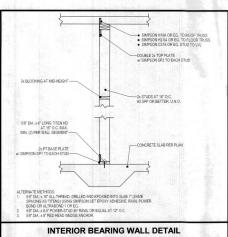

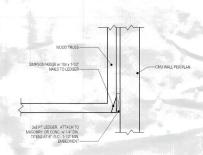


SECTION


5

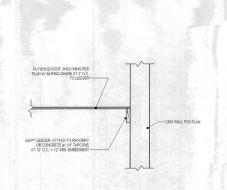


6 TRUSSES PARALLEL TO LEDGER

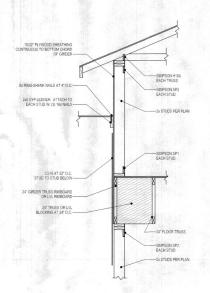




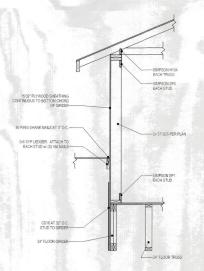

4 SECTION
34° = 1-40°

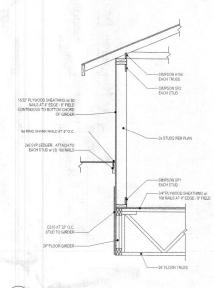

SECTION 34" = 1"-0"

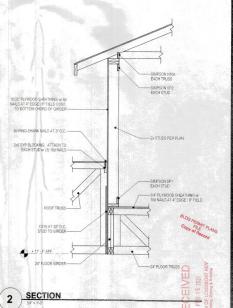

A New Residence for:
CLARE & JAMES FOX
5910 GULF OF MEXICO DRIVE, IBK, FL 34228


No. 8183


MCCALL & YOUNG ENGINEERING, LLC

STRUCTURAL DETAILS
As indicated

SEH 02.01.2021
REVISIONS
BY DATE

S4.2

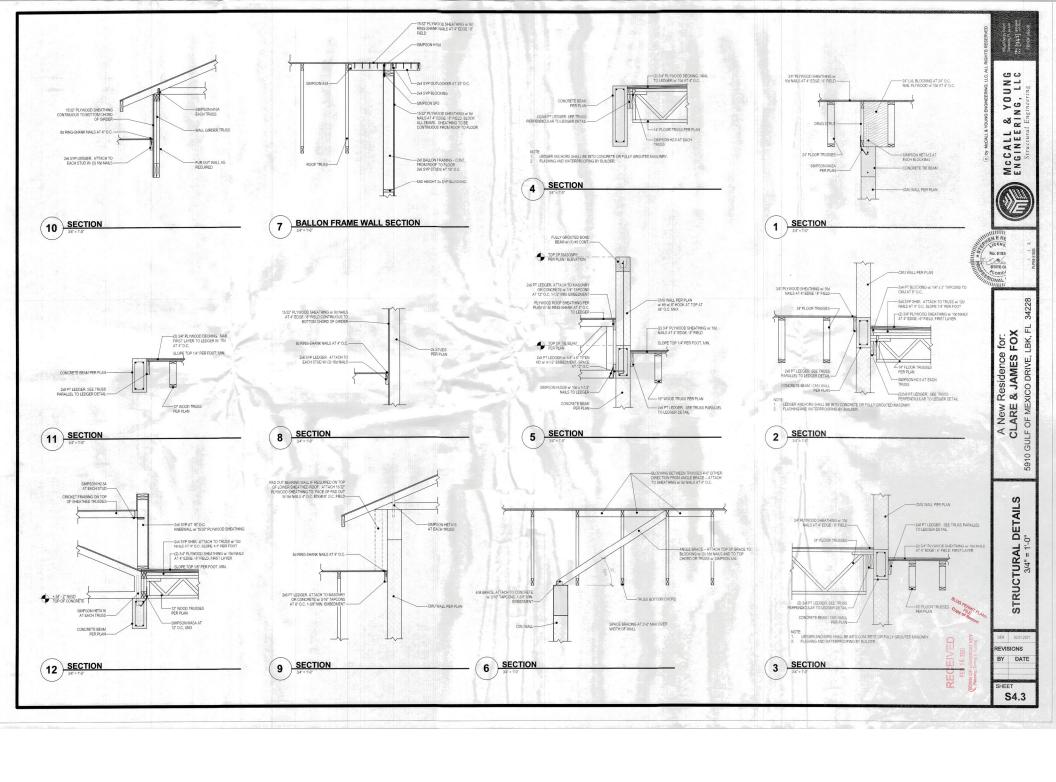

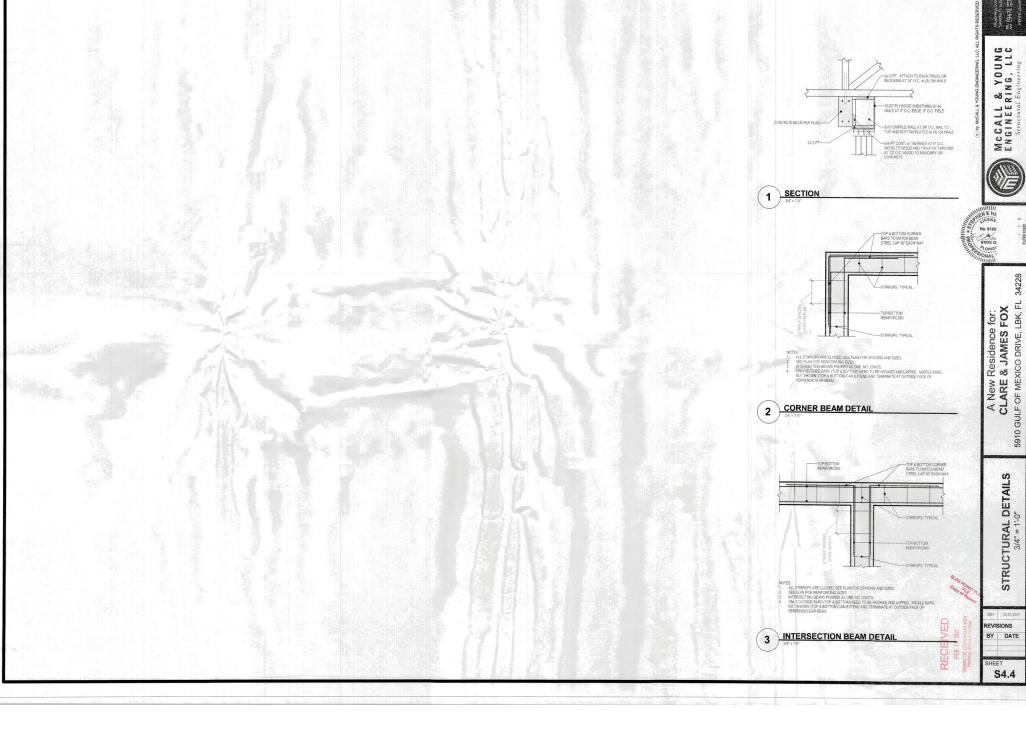

McCALL & YOUNG ENGINEERING, LLC

34228

STRUCTURAL DETAILS
3/4" = 1'-0"

REVISIONS BY DATE

S4.4